

STATE OF CALIFORNIA

CITY OF TURLOCK

CITY OF TURLOCK APPROVAL

08/08/2025

WILLIAM D. MORRIS, P.E., P.L.S

CITY ENGINEER


MUNICIPAL SERVICES DEPARTMENT

SIGNING AND STRIPING PLAN - CLIFFORD AVENUE II

SIGNING AND STRIPING PLAN - THE BURL

CONSTRUCTION PLANS FOR ROADS PROGRAM CAPITAL IMPROVEMENT PROJECT


CITY PROJECT NO. 23-069

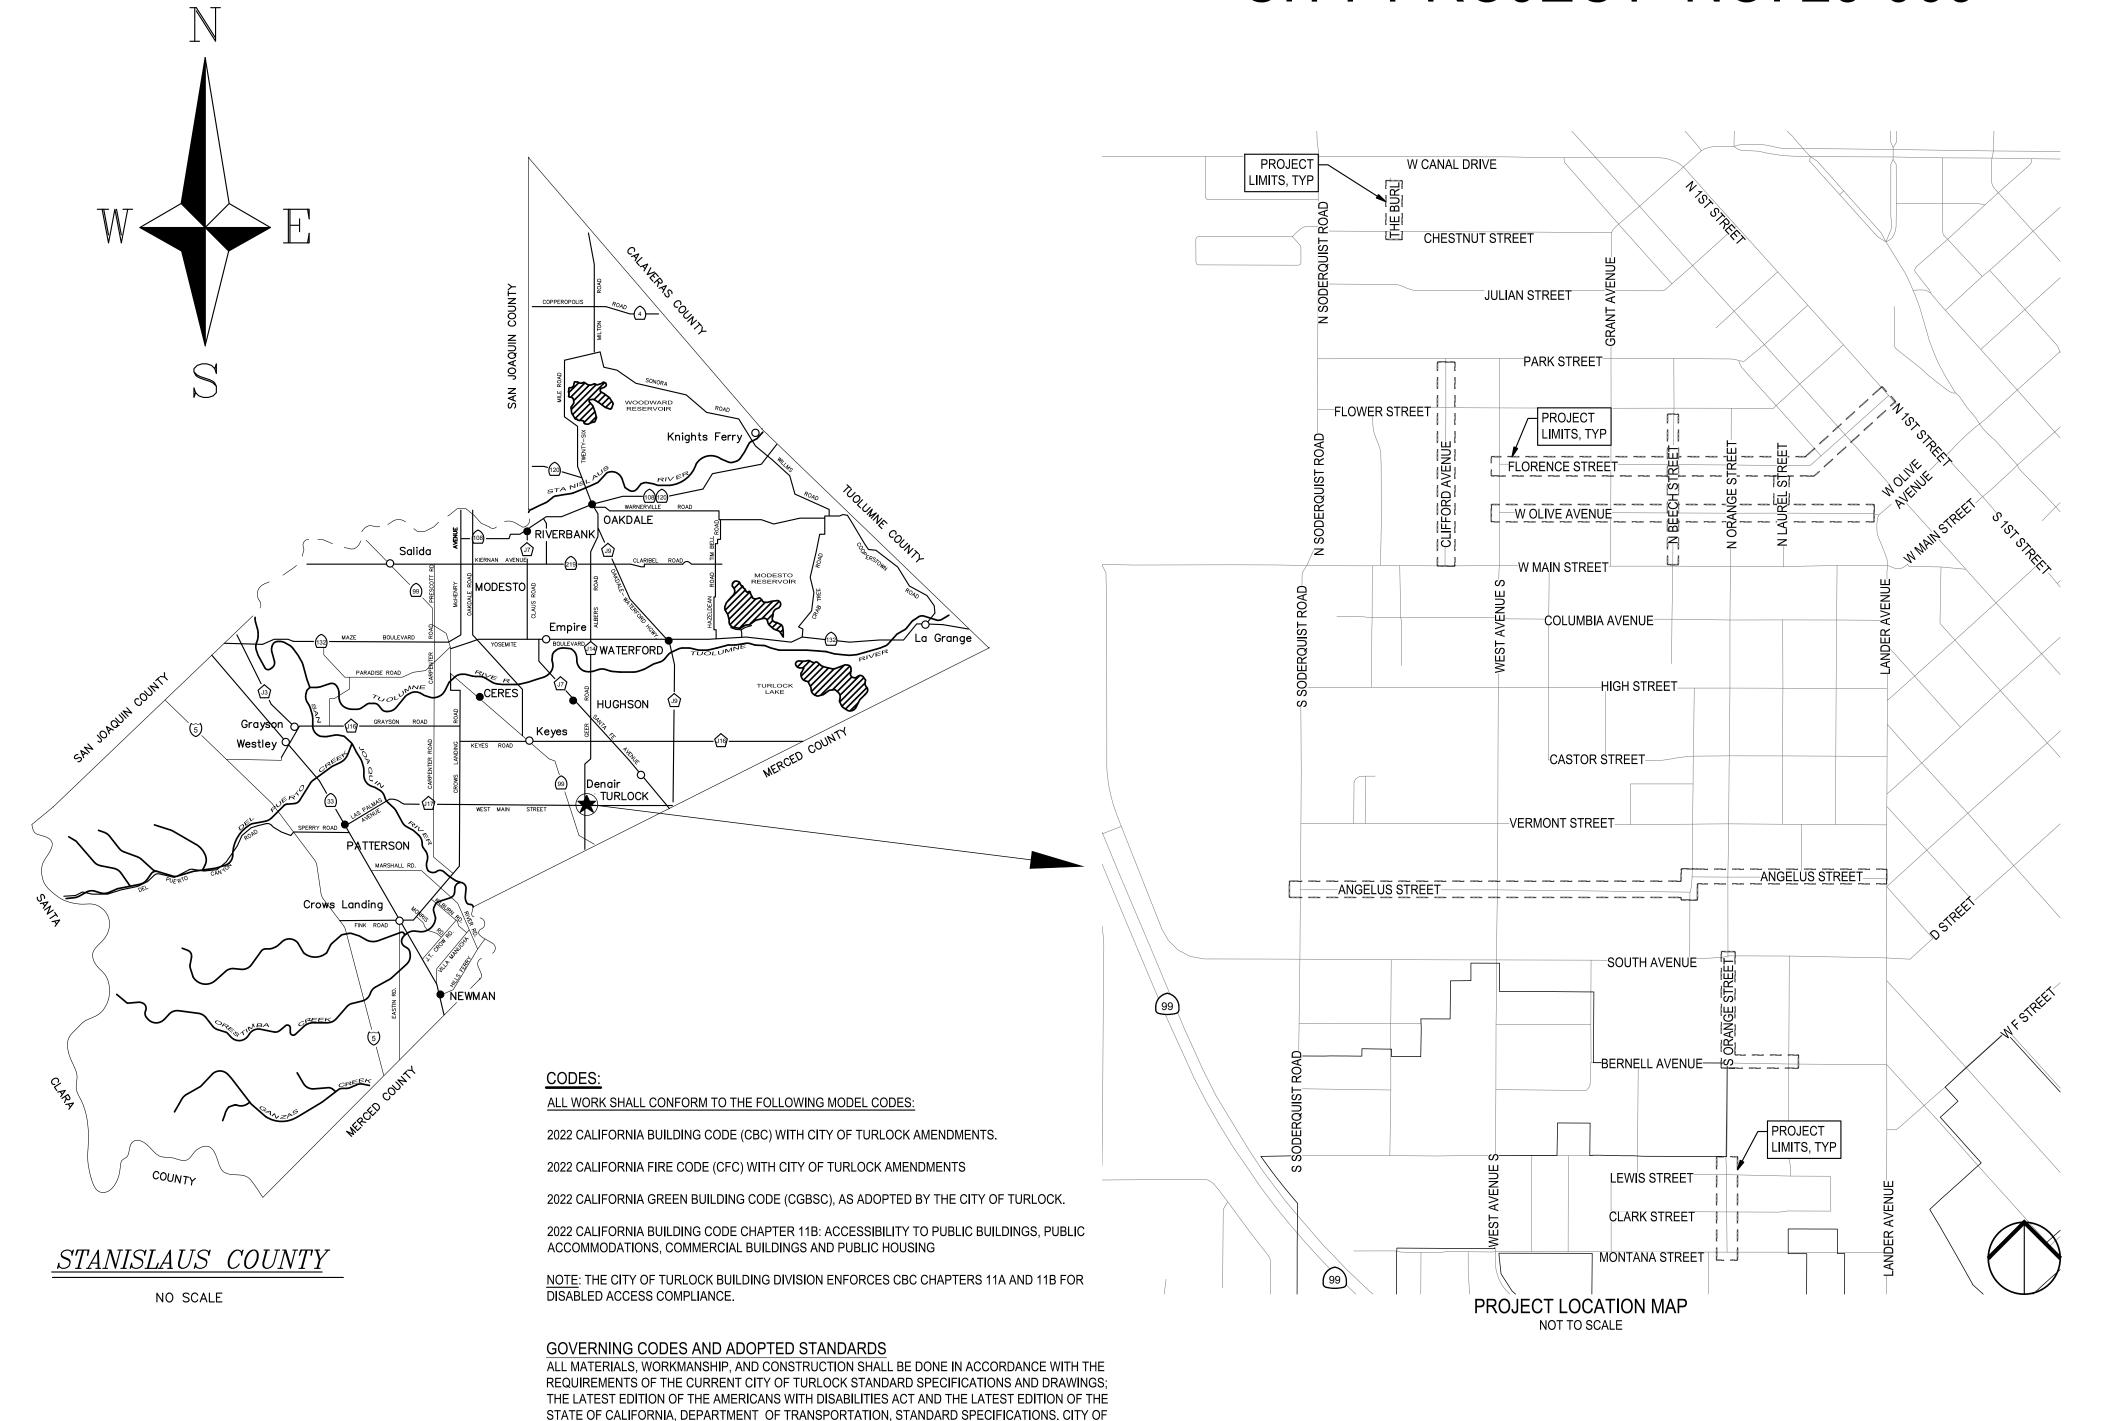

SIGNING AND STRIPING PLAN - S ORANGE STREET & **COVER SHEET GENERAL NOTES** SIGNING AND STRIPING PLAN - S ORANGE STREET II TYPICAL CROSS SECTIONS - FLORENCE STREET CURB RAMP DETAILS - FLORENCE STREET I TYPICAL CROSS SECTIONS - FLORENCE STREET II CURB RAMP DETAILS - FLORENCE STREET II TYPICAL CROSS SECTIONS - OLIVE AVENUE I CURB RAMP DETAILS - W OLIVE AVENUE I TYPICAL CROSS SECTIONS - OLIVE AVENUE II CURB RAMP DETAILS - W OLIVE AVENUE II TYPICAL CROSS SECTIONS - ANGELUS STREET **CURB RAMP DETAILS - ANGELUS STREET** TYPICAL CROSS SECTIONS - ANGELUS STREET II CURB RAMP DETAILS - S ORANGE STREET I TYPICAL CROSS SECTIONS - BEECH STREET CURB RAMP DETAILS - S ORANGE STREET II TYPICAL CROSS SECTIONS - CLIFFORD AVENUE I CURB RAMP DETAILS - S ORANGE III & THE BURL TYPICAL CROSS SECTIONS - CLIFFORD AVENUE II GRADING PLAN - FLORENCE STREET TYPICAL CROSS SECTIONS - THE BURL & S ORANGE GRADING PLAN - FLORENCE STREET II GRADING PLAN - FLORENCE STREET III KEYMAP & SURVEY CONTROL POINTS PLAN I GRADING PLAN - W OLIVE AVE I KEYMAP & SURVEY CONTROL POINTS PLAN I GRADING PLAN - W OLIVE AVE II **EXISTING UTILITIES - FLORENCE STREET I** GRADING PLAN - ANGELUS STREET I **EXISTING UTILITIES - FLORENCE STREET II** GRADING PLAN - ANGELUS STREET I **EXISTING UTILITIES - FLORENCE STREET II** GRADING PLAN - ANGELUS STREET III EXISTING UTILITIES - W OLIVE AVE I **GRADING PLAN - ANGELUS STREET IV** EXISTING UTILITIES - W OLIVE AVE II GRADING PLAN - N BEECH STREET I EXISTING UTILITIES - ANGELUS STREET GRADING PLAN - N BEECH STREET II **EXISTING UTILITIES - ANGELUS STREET I** GRADING PLAN - CLIFFORD AVENUE I **EXISTING UTILITIES - ANGELUS STREET I** GRADING PLAN - CLIFFORD AVENUE II **EXISTING UTILITIES - ANGELUS STREET** GRADING PLAN - THE BURL EXISTING UTILITIES - N BEECH STREET I GRADING PLAN - S ORANGE STREET & BERNELL **EXISTING UTILITIES - N BEECH STREET II EXISTING UTILITIES - CLIFFORD AVENUE I** GRADING PLAN - S ORANGE STREET II EXISTING UTILITIES - CLIFFORD AVENUE II STORM DRAIN PROFILES - CHESTNUT STREET I **EXISTING UTILITIES - THE BURL** STORM DRAIN PROFILES - CHESTNUT STREET II EXISTING UTILITIES - S ORANGE STREET & BERNELL STORM DRAIN PROFILES - FLORENCE STREET STORM DRAIN PROFILES - N BEECH STREET I EXISTING UTILITIES - S ORANGE STREET II STORM DRAIN PROFILES - N BEECH STREET II IMPROVEMENTS PLAN - FLORENCE STREET I STORM DRAIN PROFILES - N BEECH STREET III IMPROVEMENTS PLAN - FLORENCE STREET II STORM DRAIN PROFILES - N BEECH STREET IV IMPROVEMENTS PLAN - FLORENCE STREET II STORM DRAIN PROFILES - N BEECH STREET V IMPROVEMENTS PLAN - W OLIVE AVE I STORM DRAIN PROFILES - N ORANGE STREET I IMPROVEMENTS PLAN - W OLIVE AVE II STORM DRAIN PROFILES - N ORANGE STREET II IMPROVEMENTS PLAN - ANGELUS STREET I STORM DRAIN PROFILES - N ORANGE STREET III IMPROVEMENTS PLAN - ANGELUS STREET II STORM DRAIN PROFILES - N ORANGE STREET IV IMPROVEMENTS PLAN - ANGELUS STREET III STORM DRAIN PROFILES - ANGELUS STREET I IMPROVEMENTS PLAN - ANGELUS STREET IV STORM DRAIN PROFILES - ANGELUS STREET II IMPROVEMENTS PLAN - N BEECH STREET I TRAFFIC CONTROL NOTES I IMPROVEMENTS PLAN - N BEECH STREET II TRAFFIC CONTROL DETAILS IMPROVEMENTS PLAN - CLIFFORD AVENUE I TRAFFIC CONTROL - STAGE 1 - FLORENCE STREET IMPROVEMENTS PLAN - CLIFFORD AVENUE II TRAFFIC CONTROL - STAGE 2 - FLORENCE STREET IMPROVEMENTS PLAN - THE BURL TRAFFIC CONTROL - STAGE 3 - ORANGE STREET IMPROVEMENTS PLAN - S ORANGE STREET & TRAFFIC CONTROL - STAGE 4 - W OLIVE AVENUE BERNELL AVENUE IMPROVEMENTS PLAN - S ORANGE STREET II TRAFFIC CONTROL - STAGE 5 - W OLIVE AVENUE SIGNING AND STRIPING PLAN - FLORENCE STREET I TRAFFIC CONTROL - STAGE 6 - ANGELUS STREET SIGNING AND STRIPING PLAN - FLORENCE STREET II TRAFFIC CONTROL - STAGE 7 - ANGELUS STREET SIGNING AND STRIPING PLAN - FLORENCE STREET III TRAFFIC CONTROL - STAGE 8 - N BEECH STREET SIGNING AND STRIPING PLAN - W OLIVE AVE I TRAFFIC CONTROL - STAGE 9 - CLIFFORD AVENUE SIGNING AND STRIPING PLAN - W OLIVE AVE II TRAFFIC CONTROL - STAGE 10 - THE BURL SIGNING AND STRIPING PLAN - ANGELUS STREET I TRAFFIC CONTROL - STAGE 11 - S ORANGE STREET & BERNELL AVENUE SIGNING AND STRIPING PLAN - ANGELUS STREET II TRAFFIC CONTROL - STAGE 12 - S ORANGE STREET SIGNING AND STRIPING PLAN - ANGELUS STREET III SIGNING AND STRIPING PLAN - ANGELUS STREET IV CONSTRUCTION DETAILS I SIGNING AND STRIPING PLAN - N BEECH STREET I CONSTRUCTION DETAILS II SIGNING AND STRIPING PLAN - N BEECH STREET II CONSTRUCTION DETAILS III SIGNING AND STRIPING PLAN - CLIFFORD AVENUE I




NOTE:
ALL REFERENCES AND WRITTEN
DIMENSIONS SHALL SUPERCEDE
ALL SCALED DISTANCES AND
SHALL BE VERIFIED IN THE
FIELD. ANY DISCREPANCY
SHALL BE BROUGHT TO THE
ATTENTION OF THE ENGINEER
PRIOR TO THE COMMENCEMENT
OF WORK

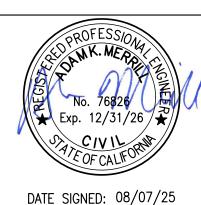

TURLOCK STANDARD DRAWINGS ARE AVAILABLE AT THE OFFICE OF THE CITY ENGINEER.



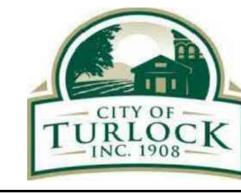

CITY OF TURLOCK
MUNICIPAL SERVICES DEPARTMENT
156 S. BROADWAY,
SUITE 150
(209) 668-5520



SHEET INDEX

DESCRIPTION

PROJECT NO. 23-069 CITY OF TURLOCK ROADS PROGRAM VERIFY SCALE

O

1"

REV. BY: AKM

CH. BY: AKM

DATE: 8/7/2025

SCALE: SEE SHEET

SEI PROJ NO: 22157

DRAWING NO.

01

SHEET:
01 OF 117

GENERAL NOTES

- 1. ALL IMPROVEMENTS SHALL BE CONSTRUCTED IN STRICT ACCORDANCE WITH CITY OF TURLOCK STANDARD SPECIFICATIONS AND PLANS, LATEST EDITION, AND ALL AMENDMENTS THERE TO-DATE. ALL CITY OF TURLOCK STANDARD DETAILS REFER TO CITY OF TURLOCK ENGINEERING DIVISION STANDARD SPECIFICATIONS AND DETAILS 2016 UNLESS OTHERWISE NOTED
- 2. THE CONTRACTOR SHALL BE RESPONSIBLE FOR PROTECTING FROM DAMAGE ALL EXISTING IMPROVEMENTS THAT ARE TO REMAIN. SUCH IMPROVEMENTS THAT ARE DAMAGED BY THE CONTRACTOR SHALL BE REPLACED AT HIS EXPENSE AND APPROVED BY THE CITY ENGINEER.
- 3. EXCAVATION OF 5 FEET OR MORE IN DEPTH WILL REQUIRE AN EXCAVATION PERMIT FROM THE STATE OF CALIFORNIA DEPARTMENT OF INDUSTRIAL SAFETY.
- 4. THE CONTRACTOR SHALL DEMOLISH, EXCAVATE, REMOVE AND DISPOSE OF ALL EXISTING CONCRETE CURB, GUTTER OR SIDEWALK, ASPHALT CONCRETE PAVING, AND DELETERIOUS MATERIAL AS REQUIRED TO CONSTRUCT THE CONTRACT WORK. ALL SUCH EXCESS MATERIAL GENERATED SHALL BE DISPOSED OF FROM THE SITE BY THE CONTRACTOR. SITE PREPARATION SHALL INCLUDE STRIPPING AND REMOVAL OF ALL VEGETATION AND ANY DEBRIS FROM THE CONSTRUCTION AREAS. THE DEPTH OF STRIPPING ONSITE SHALL BE EVALUATED BY THE OWNER'S SOILS
- 5. THE CONTRACTOR SHALL OBTAIN AN ENCROACHMENT PERMIT FOR ANY WORK DONE WITHIN THE CITY OF TURLOCK RIGHT-OF-WAY FROM THE CITY ENGINEERING DIVISION AND NOTIFY THE CORRESPONDING AGENCY 48 HOURS IN ADVANCE OF STARTING ANY WORK TO BE ACCEPTED FOR OWNERSHIP AND MAINTENANCE BY CITY OF TURLOCK.
- 6. EXISTING UTILITIES ARE SHOWN AS THEY ARE BELIEVED TO EXIST. THE OWNER AND THE ENGINEER DO NOT ACCEPT RESPONSIBILITY FOR THEIR ACCURACY. PRIOR TO COMMENCING ANY WORK, THE CONTRACTOR SHALL HAVE EACH UTILITY COMPANY ACCURATELY LOCATE IN THE FIELD THEIR MAINS AND SERVICE LINES. IT SHALL BE THE CONTRACTOR'S RESPONSIBILITY TO PROTECT ALL EXISTING UTILITIES. THE CONTRACTOR SHALL NOTIFY MEMBERS OF THE UNDERGROUND SERVICE ALERT (U.S.A.) 48 HOURS IN ADVANCE OF PERFORMING EXCAVATION WORK BY CALLING THE TOLL-FREE NUMBER (800-227-2600).
- 7. ATTENTION IS CALLED TO: SECTION 1540 (A) (1) OF THE CONSTRUCTION SAFETY ORDERS (TITLE 8 CALIFORNIA ADMINISTRATION CODE SECTION 1540), ISSUED BY THE OCCUPATIONAL SAFETY AND HEALTH STANDARDS BOARD PURSUANT TO THE CALIFORNIA OCCUPATIONAL SAFETY AND HEALTH ACT OF 1973, AS AMENDED, WHICH STATES:

"PRIOR TO OPENING AN EXCAVATION, EFFORT SHALL BE MADE TO DETERMINE WHETHER UNDERGROUND INSTALLATION I.E., SEWER, WATER, FUEL, ELECTRIC LINES, ETC., WILL BE ENCOUNTERED AND, IF SO, WHERE SUCH UNDERGROUND INSTALLATIONS ARE LOCATED. WHEN THE EXCAVATION APPROACHES THE APPROXIMATE LOCATION OF SUCH AN INSTALLATION, THE EXACT LOCATION SHALL BE DETERMINED BY CAREFUL PROBING OR HAND DIGGING AND WHEN IT IS UNCOVERED, ADEQUATE PROTECTION SHALL BE PROVIDED FOR THE EXISTING INSTALLATION. ALL KNOWN OWNERS OF UNDERGROUND FACILITIES IN THE AREA CONCERNED SHALL BE ADVISED OF PROPOSED WORK AT LEAST 48 HOURS PRIOR TO THE START OF ACTUAL EXCAVATION."

- 8. WHENEVER EXISTING PAVEMENT IS BROKEN OR CUT DURING THE INSTALLATION OF THE WORK COVERED BY THESE PLANS AND SPECIFICATIONS, THE PAVEMENT SHALL BE REPLACED WITH PAVEMENT MATERIALS EQUAL TO OR BETTER THAN THE MATERIALS USED IN THE ORIGINAL PAVING.
- 9. PAYMENT FOR PAVEMENT WILL BE MADE FOR THE AREAS SHOWN ON THE PLANS. REPLACEMENT OF PAVEMENT WHICH IS BROKEN OR CUT IN THE INSTALLATION OF THE IMPROVEMENTS COVERED BY THESE PLANS AND SPECIFICATIONS, AND WHICH LIES OUTSIDE OF SAID AREAS, SHALL BE INCLUDED IN THE STREET CONTRACTOR'S UNIT PRICE FOR PAVEMENT, AND NO ADDITIONAL PAYMENT SHALL BE MADE FOR SUCH WORK.
- 10. THE CONTRACTOR AGREES THAT HE SHALL ASSUME SOLE AND COMPLETE RESPONSIBILITY FOR JOB SITE CONDITIONS DURING THE COURSE OF CONSTRUCTION OF THIS PROJECT INCLUDING SAFETY OF ALL PERSONS AND PROPERTY, THAT THIS REQUIREMENT SHALL APPLY CONTINUOUSLY AND NOT BE LIMITED TO NORMAL WORKING HOURS, AND THAT THE CONTRACTOR SHALL DEFEND, INDEMNIFY AND HOLD THE OWNER AND THE ENGINEER HARMLESS FROM ANY AND ALL LIABILITY, REAL OR ALLEGED, IN CONNECTION WITH THE PERFORMANCE OF WORK ON THIS PROJECT, EXCEPTING FOR LIABILITY ARISING FROM THE SOLE NEGLIGENCE OF THE OWNER OR THE ENGINEER.
- 11. THE CONTRACTOR SHALL OBTAIN A FIRE HYDRANT METER FROM CITY OF TURLOCK MUNICIPAL SERVICES FOR USE OF WATER FROM FIRE HYDRANTS FOR CONSTRUCTION PURPOSES.
- 12. THE CONTRACTOR SHALL FURNISH, INSTALL OPERATE AND MAINTAIN ALL MACHINERY, APPLIANCES AND EQUIPMENT TO MAINTAIN ALL EXCAVATIONS FREE FROM WATER DURING CONSTRUCTION, AND SHALL DEWATER AND DISPOSE OF THE WATER SO AS TO NOT CAUSE INJURY TO PUBLIC OR PRIVATE PROPERTY, OR TO CAUSE A NUISANCE OR MENACE TO THE PUBLIC. THE DEWATERING SYSTEM SHALL BE INSTALLED AND OPERATED SO THE GROUNDWATER LEVEL OUTSIDE THE EXCAVATION IS NOT REDUCED TO THE EXTENT WHICH WOULD CAUSE DAMAGE OR ENDANGER ADJACENT STRUCTURES OR PROPERTY. ALL COSTS FOR DEWATERING SHALL BE INCLUDED IN THE UNIT PRICE BID FOR ALL PIPE CONSTRUCTION. THE STATIC WATER LEVEL SHALL BE DRAWN DOWN A MINIMUM OF 1 FOOT BELOW THE BOTTOM OF EXCAVATION OF ANY FILL TO THE SPECIFIED DENSITY. DISPOSAL OF WATER SHALL BE IN ACCORDANCE WITH THE APPROVED SWPPP AND SHALL NOT DAMAGE PROPERTY, CREATE A PUBLIC NUISANCE OR VIOLATE THE LAW. THE CONTRACTOR SHALL HAVE ON HAND, PUMPING EQUIPMENT AND MACHINERY IN GOOD WORKING CONDITION FOR EMERGENCIES AND SHALL HAVE WORKMEN AVAILABLE FOR ITS OPERATION. THE DEWATERING SYSTEM SHALL OPERATE CONTINUOUSLY UNTIL BACK-FILL HAS BEEN COMPLETED TO 1 FOOT ABOVE THE NORMAL STATIC GROUNDWATER LEVEL.
- 13. ANY VOIDS LEFT BY THE REMOVAL OF UNDERGROUND UTILITIES OR OTHER BURIED OBJECTS SHALL BE CLEANED OF ALL LOOSE SOILS AND SHALL BE PROPERLY BACKFILLED WITH ENGINEERED FILLED THAT THE OWNER'S SOIL ENGINEER APPROVES, MONITORS, TESTS, AND APPROVES.
- 14. THE SUBGRADE SOILS OR BASE MATERIALS BENEATH ALL PAVING AREAS SHOULD BE COMPACTED TO A MINIMUM OF 95% RELATIVE COMPACTION.
- 15. IF ANY SOFT OR LOOSE SOIL POCKETS ARE FOUND ONSITE DURING THE STRIPPING OR RECOMPACTION PROCESS, THEY SHALL BE OVER EXCAVATED AND RECOMPACTED.
- 16. CONTRACTOR SHALL MAINTAIN MOISTURE CONDITION RIGHT UP TO POURING OF CONCRETE.
- 17. WHERE COMBINATIONS OF SIDEWALK OR CURB AND GUTTER ARE POURED CONTIGUOUS TO EXISTING, ALL ADJOINING EXISTING CONCRETE VERTICAL FACES SHALL BE DOWELED. ALL ABUTTING SIDEWALK ENDS SHALL BE DOWELED MID-SECTION VERTICALLY WITH TWO DOWELS FOR FOUR THROUGH SIX-FOOT WIDE SIDEWALK AND THREE DOWELS FOR WIDER SIDEWALK. ABUTTING CURB AND GUTTER ENDS SHALL BE DOWELED TWICE, 18 INCHES APART AT GUTTER PAN MID-SECTION. DOWEL CONNECTIONS OF LONGITUDINAL RUNS OF SIDEWALK TO BACK OF CURB SHALL BE THREE FEET ON CENTER. ALL DOWELS SHALL BE 16 INCHES LONG, GRADE 60: #4 REBAR PENETRATING FOUR INCHES. THE DOWEL HOLE SHALL BE 5/8-INCH DIAMETER AT A SLIGHT HORIZONTAL ANGLE FROM PERPENDICULAR. THE PENETRATING PORTION OF THE DOWEL AND THE ENTIRE (CLEANED) VERTICAL SURFACE OF THE ADJOINING, EXISTING CONCRETE SHALL BE THOROUGHLY COATED WITH STATE STANDARD TWO-PART EPOXY.

CLEARING NOTES

THE CONTRACTOR IS RESPONSIBLE FOR CLEARING AND GRUBBING, PRUNING AND REMOVING TREE ROOTS THAT INTERFERE WITH THE WORK. THE CONTRACTOR SHALL BE RESPONSIBLE FOR ENSURING NO TREE ROOTS ARE PRUNED OR CUT THAT COULD COMPROMISE THE STABILITY OF THE TREE. THE CONTRACTOR SHALL RETAIN AN ARBORIST, AT THEIR OWN EXPENSE PRIOR TO BEGINNING WORK. THE CONTRACTOR'S ARBORIST SHALL PROVIDE A WORK PLAN THAT DESCRIBES THE METHOD OF PRUNING AND REMOVING MINOR TREE ROOTS THAT MAY BE ENCOUNTERED DURING CONSTRUCTION. THE ARBORIST WILL PROVIDE RECOMMENDATIONS FOR

DEMOLITION NOTES:

EXISTING STRUCTURES, CONCRETE, PAVEMENT, FENCES, CURBS, UTILITY BOXES, LIGHTS, GATES, ETC. NOT CALLED OUT IN PLANS TO BE REMOVED OR DEMOLISHED SHALL BE PROTECTED IN PLACE.

GRADING NOTES

- GRADING AND LAND STABILIZATION SHALL INCLUDE COST OF DEWATERING; REMOVING FROM THE SITE ALL STRIPPED VEGETATION, DEBRIS, STRUCTURES, POWER POLES, EXISTING PAVEMENT, BUILDINGS, TREES, AND OTHER DELETERIOUS MATERIALS.
- 2. TOPOGRAPHICAL INFORMATION SHOWN REFLECTS A TOPOGRAPHY SURVEY PERFORMED BY SIEGFRIED ENGINEERING.
- 3. ANY AND ALL SEDIMENT AND/OR EROSION CONTROL DETAILS CONTAINED WITHIN THESE PLANS ARE TO BE CONSIDERED AS "REFERENCE DETAILS" ONLY AND THE CITY'S APPROVAL OF THESE PLANS AND "REFERENCE DETAILS" DOES NOT RELIEVE THE OWNER/DEVELOPER FROM COMPLIANCE WITH THE STORM WATER POLLUTION PREVENTION PLAN AS APPROVED BY THE CITY'S STORM WATER DIVISION
- 4. CONTRACTOR SHALL MATCH EXISTING ELEVATIONS ALONG CONFORM LINES.
- POSITIVE DRAINAGE SHALL BE MAINTAINED ON ALL SURFACE AREAS WITHIN THE SCOPE OF THIS PROJECT. CONTRACTOR SHOULD TAKE PRECAUTIONS NOT TO ALLOW ANY PONDING OF WATER.
- 6. ALL DISTURBED AREAS SHALL BE REVEGETATED, BY THE CONTRACTOR, IN ACCORDANCE WITH PROJECT
- 7. THE CONTRACTOR WILL BE RESPONSIBLE FOR DETERMINING THE EXACT LOCATION OF ALL UTILITIES AND DRAINAGE STRUCTURES WHETHER SHOWN ON THE PLANS OR NOT. THE CONTRACTOR SHALL UNCOVER EXISTING UTILITIES PRIOR TO CONSTRUCTION TO VERIFY SIZE, GRADE, AND LOCATION. THE CONTRACTOR SHALL NOTIFY THE ENGINEER IMMEDIATELY OF ANY DEVIATIONS FROM PLANS PRIOR TO BEGINNING CONSTRUCTION. ANY DAMAGE TO EXISTING UTILITIES, WHETHER SHOWN ON THE PLANS OR NOT, SHALL BE THE CONTRACTOR'S RESPONSIBILITY TO REPAIR, AT HIS EXPENSE.
- CONTRACTOR SHALL BE RESPONSIBLE FOR RESTORING TO ORIGINAL, OR BETTER, CONDITION ANY DAMAGES DONE TO EXISTING SIGNS, UTILITIES, PAVEMENT, CURBS, SIDEWALKS OR DRIVEWAYS.
- 9. DUE TO FEDERAL REGULATION TITLE 49, PART 192.181, THE GAS UTILITY MUST MAINTAIN ACCESS TO GAS VALVES AT ALL TIMES. THE CONTRACTOR MUST PROTECT AND WORK AROUND ANY GAS VALVES THAT ARE IN THE PROJECT AREA.
- 10. CONTRACTOR SHALL IMMEDIATELY NOTIFY THE ENGINEER OF ANY QUESTIONS THAT MAY ARISE CONCERNING THE INTENT, PLACEMENT, OR LIMITS, OF DIMENSIONS OR GRADES NECESSARY FOR CONSTRUCTION OF THIS
- 11. THE CONTRACTOR SHALL BE RESPONSIBLE FOR ACQUIRING ALL PERMITS, TESTS, AND APPROVALS AND ACCEPTANCES REQUIRED TO COMPLETE CONSTRUCTION OF THIS PROJECT.
- 12. TOPSOIL STRIPPING MATERIALS TO BE RE-USED FOR REVEGETATION SHALL BE MAINTAINED IN ACCORDANCE WITH APPLICABLE POLLUTION PREVENTION PLANS OR PERMITS.
- 13. WASTE MATERIALS, OR EXCESS TOPSOIL GENERATED AS A RESULT OF CLEARING AND GRADING OPERATIONS SHALL BECOME THE PROPERTY OF THE CONTRACTOR. APPROPRIATE DISPOSAL OF ALL SPOIL SHALL BE AT THE CONTRACTOR'S EXPENSE.

PAVING AND DIMENSIONING NOTES

- 1. ALL DIMENSIONS ARE TO TOP FACE OF CURB, FACE OF BUILDING, CENTER OF PAINT STRIPING OR PERPENDICULAR TO THE PROPERTY LINE. CONTRACTOR SHALL VERIFY DIMENSIONS MATCH FIELD CONDITIONS PRIOR TO CONSTRUCTION.
- 2. THE CONTRACTOR SHALL VERIFY ELEVATIONS AND LOCATIONS OF EXISTING FACILITIES AND NOTIFY THE ENGINEER OF ANY CONFLICTS PRIOR TO BEGINNING CONSTRUCTION.
- 3. ALL SIGNS SHALL CONFORM TO MUTCD, LATEST EDITION.

TREE PROTECTION NOTES

CONTRACTOR SHALL PROVIDE A CERTIFIED ARBORIST TO INSPECT TREES FOR HEALTH AND STRUCTURAL INTEGRITY AS WELL AS DETERMINE IF TREES ARE TO REMAIN IN PLACE AND BE PROTECTED DURING CONSTRUCTION. CONTRACTOR SHALL PROVIDE TREE PROTECTION AND SIGNAGE PER CITY OF TURLOCK REQUIRED STANDARDS AND METHODS. CARE SHALL BE TAKEN WHEN CONSTRUCTION OCCURS WITHIN THE TREE DRIPLINE.

TREE PROTECTION NOTES

- 1. PRIOR TO START OF CONSTRUCTION, CONTRACTOR SHALL MEET AT THE PROJECT SITE TO DISCUSS TREE PROTECTION MEASURES AND REQUIRED TREE MAINTENANCE FOR THE PROJECT.
- 2. IF ROOTS OR LIMBS OBSERVED OR DAMAGED DURING CONSTRUCTION, THE CONTRACTOR SHALL REPORT IN WRITING THE INCIDENT TO THE CITY ENGINEER.
- 3. REFER TO SECTION 01 56 39 TREE AND PLANT PROTECTIONS FOR ADDITIONAL STANDARD SPECIFICATIONS IN REGARDS TO EXISTING TREES.

LANDSCAPE / IRRIGATION PROTECTION NOTES

- CONTRACTOR SHALL VERIFY ANY IRRIGATION FACILITIES TO BE DISRUPTED IN LANDSCAPED DEMOLITION AREAS.
- 2. CONTRACTOR TO ADJUST EXISTING IRRIGATION FACILITIES AS NECESSARY TO THE SATISFACTION OF THE CITY ENGINEER.
- CONTRACTOR TO VERIFY ANY IRRIGATION FACILITIES TO BE DISRUPTED IN LANDSCAPED DEMOLITION AREAS. EXISTING IRRIGATION FACILITIES SHALL BE CUT BACK AND MODIFIED TO ACCOMMODATE PROPOSED IMPROVEMENTS, AND SERVE LANDSCAPE AREAS TO REMAIN.

LEGEND EXISTING PROPOSED UNDERGROUND ELECTRIC LINE TELE ----TELECOMMUNICATION LINE TOP OF CURB ELEVATION 11.43FL FLOW LINE ELEVATION CONCRETE ELEVATION PAVEMENT ELEVATION **EXISTING ELEVATION** GAS LINE -----AT&T-----AT&T CENTER LINE PROPERTY & R/W LINE WOOD FENCE SANITARY SEWER LINE STORM DRAIN LINE 8"SD>----12"W WATER LINE CATCH BASIN MAINTENANCE HOLE **CURB AND GUTTER** \longrightarrow GATE VALVE STREET LIGHT SIGN **POWER POLE GUY WIRES ELECTRICAL BOX**

UTILITY VAULT

TREE

ABBREVIATIONS

<u>ABBREVIATION</u>	DESCRIPTION
@	AT
AB	AGGREGATE BASE
AC	ASPHALT CONCRETE
ADA	AMERICANS WITH DISABILITIES ACT
BW	BACK OF WALK
С	CONCRETE
CL	CENTERLINE
CO	CLEANOUT
D	DEPTH
DIA	DIAMETER
DWG	DRAWING
EL EP	ELEVATION EXISTING PAVEMENT
EQ	EQUAL, EQUIDISTANT, EQUIVALENT
EX	EXISTING
FC	FACE OF CURB
FL	FLOWLINE
FH	FIRE HYDRANT
G	GROUND
GB	GRADE BREAK
HP	HIGH POINT
HORIZ	HORIZONTAL
LF	LINEAR FEET
L	LEFT
LS	LANDSCAPE
MAX	MAXIMUM
MH	MAINTENANCE HOLE
MIN NO.	MINIMUM NUMBER
NTS	NOT TO SCALE
O.C.	ON CENTER
P.	PAVEMENT
PP	POWER POLE
PSI	POUNDS PER SQUARE INCH
PUE	PUBLIC UTILITY EASEMENT
PVC	POLYVINYL CHLORIDE
PL	PROPERTY LINE
R	RADIAL OR RADIUS
R/W	RIGHT-OF-WAY
SD	STORM DRAIN
SF SS	SQUARE FEET
SL	SANITARY SEWER STREET LIGHT
SW	SIDEWALK
SDMH	STORM DRAIN MAINTENANCE HOLE
SSMH	SANITARY SEWER MAINTENANCE HOLE
STA	STATION
STD	STANDARD
ST	STREET
SWPPP	STORM WATER POLLUTION
	PREVENTION PLAN
TC	TOP OF CURB
TI	TRAFFIC INDEX
TYP VERT	TYPICAL VERTICAL
W	WATER
(W)	WEST
(E)	EAST
(S)	SOUTH
(N)	NORTH
±	PLUS OR MINUS
(L)	LEFT SIDE OF ROAD
(R)	RIGHT SIDE OF ROAD

CONTACTS CITY OF TURLOCK MUNICIPAL SERVICES DEPARTMENT (209) 668-5520

(209) 678-5823 DOYLE PERRY CITY OF TURLOCK STORM AND SEWER

CITY OF TURLOCK ELECTRICAL

CITY OF TURLOCK WATER (209) 740-3868 ORLANDO GUTIERREZ

(209) 345-2169 CARLOS GUERRERO

(209) 605-0945 DAVID PORATH TURLOCK IRRIGATION DISTRICT (IRRIGATION)

TURLOCK IRRIGATION DISTRICT (ELECTRICAL)

CHARTER COMMUNICATIONS (209) 633-3303 ABRAHAM ZAMORA

(209) 883-8415 BILL PENNEY

TURLOCK TRANSIT (209) 668-5600

PACIFIC GAS & ELECTRIC (GAS) (209) 561-6070 TRENT MILLSAF

(209) 507-1689 JIM JELLY

FIRE DEPARTMENT (NON-EMERGENCY) (209) 668-5580

POLICE DEPARTMENT (NON-EMERGENCY)

(209) 668-1200 AMBULANCE

(209) 632-2271

TURLOCK SCAVENGER (209) 668-7274

Know what's below. Call before you dig.


ALL REFERENCES AND WRITTEN DIMENSIONS SHALL SUPERCEDE ALL SCALED DISTANCES AND SHALL BE VERIFIED IN THE FIELD. ANY DISCREPANCY SHALL BE BROUGHT TO THE ATTENTION OF THE ENGINEER PRIOR TO THE COMMENCEMENT OF WORK



DATE SIGNED: 08/07/25



SIEGFRIED Stockton ,California 95219 STRUCTURAL PLANNING LANDSCAPE _ ATHLETIC ARCHITECTURE FACILITY DESIGN www.siegfriedeng.com

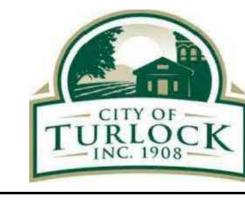



CITY OF TURLOCK MUNICIPAL SERVICES DEPARTMENT 156 S. BROADWAY, SUITE 150 (209) 668 - 5520


GENERAL NOTES


PROJECT NO. 23-069 CITY OF TURLOCK ROADS PROGRAM

DRAWING NO. VERIFY SCALE DRAWN BY: JR REV. BY: AKM CH. BY: AKM DATE: 8/7/2025 SCALE: SEE SHEET SHEET: SEI PROJ NO: 22157 02 OF 117

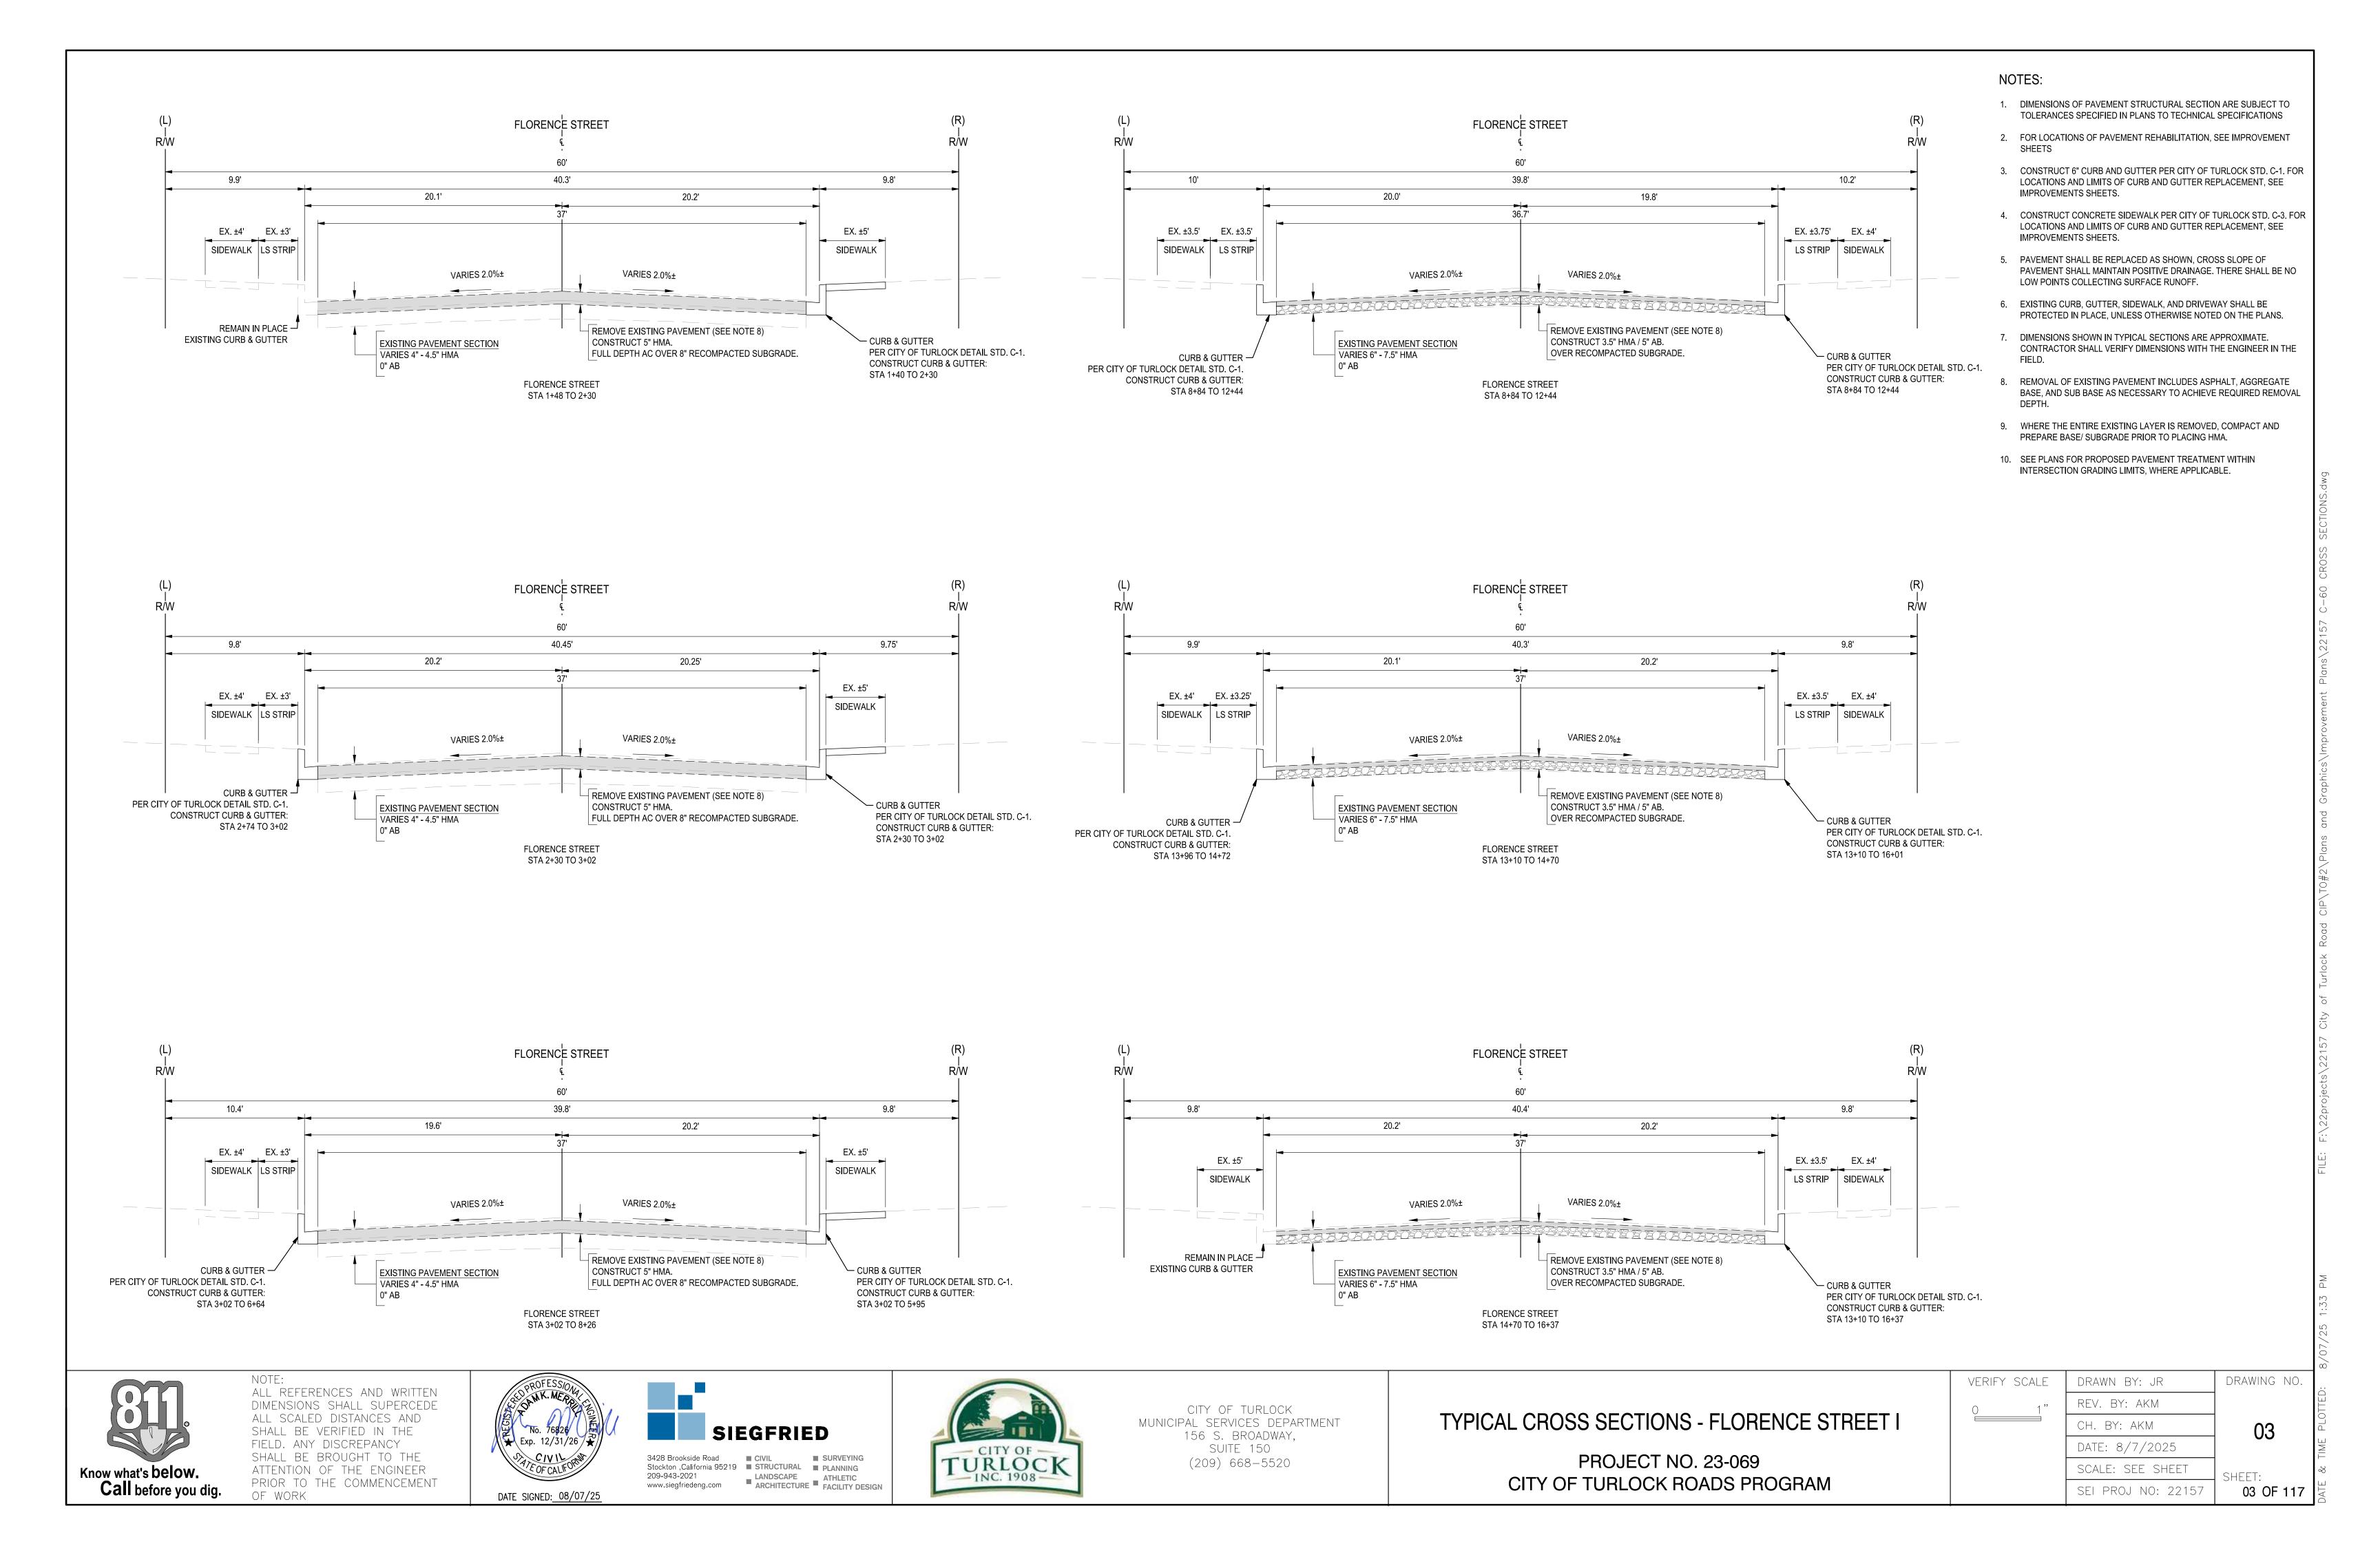

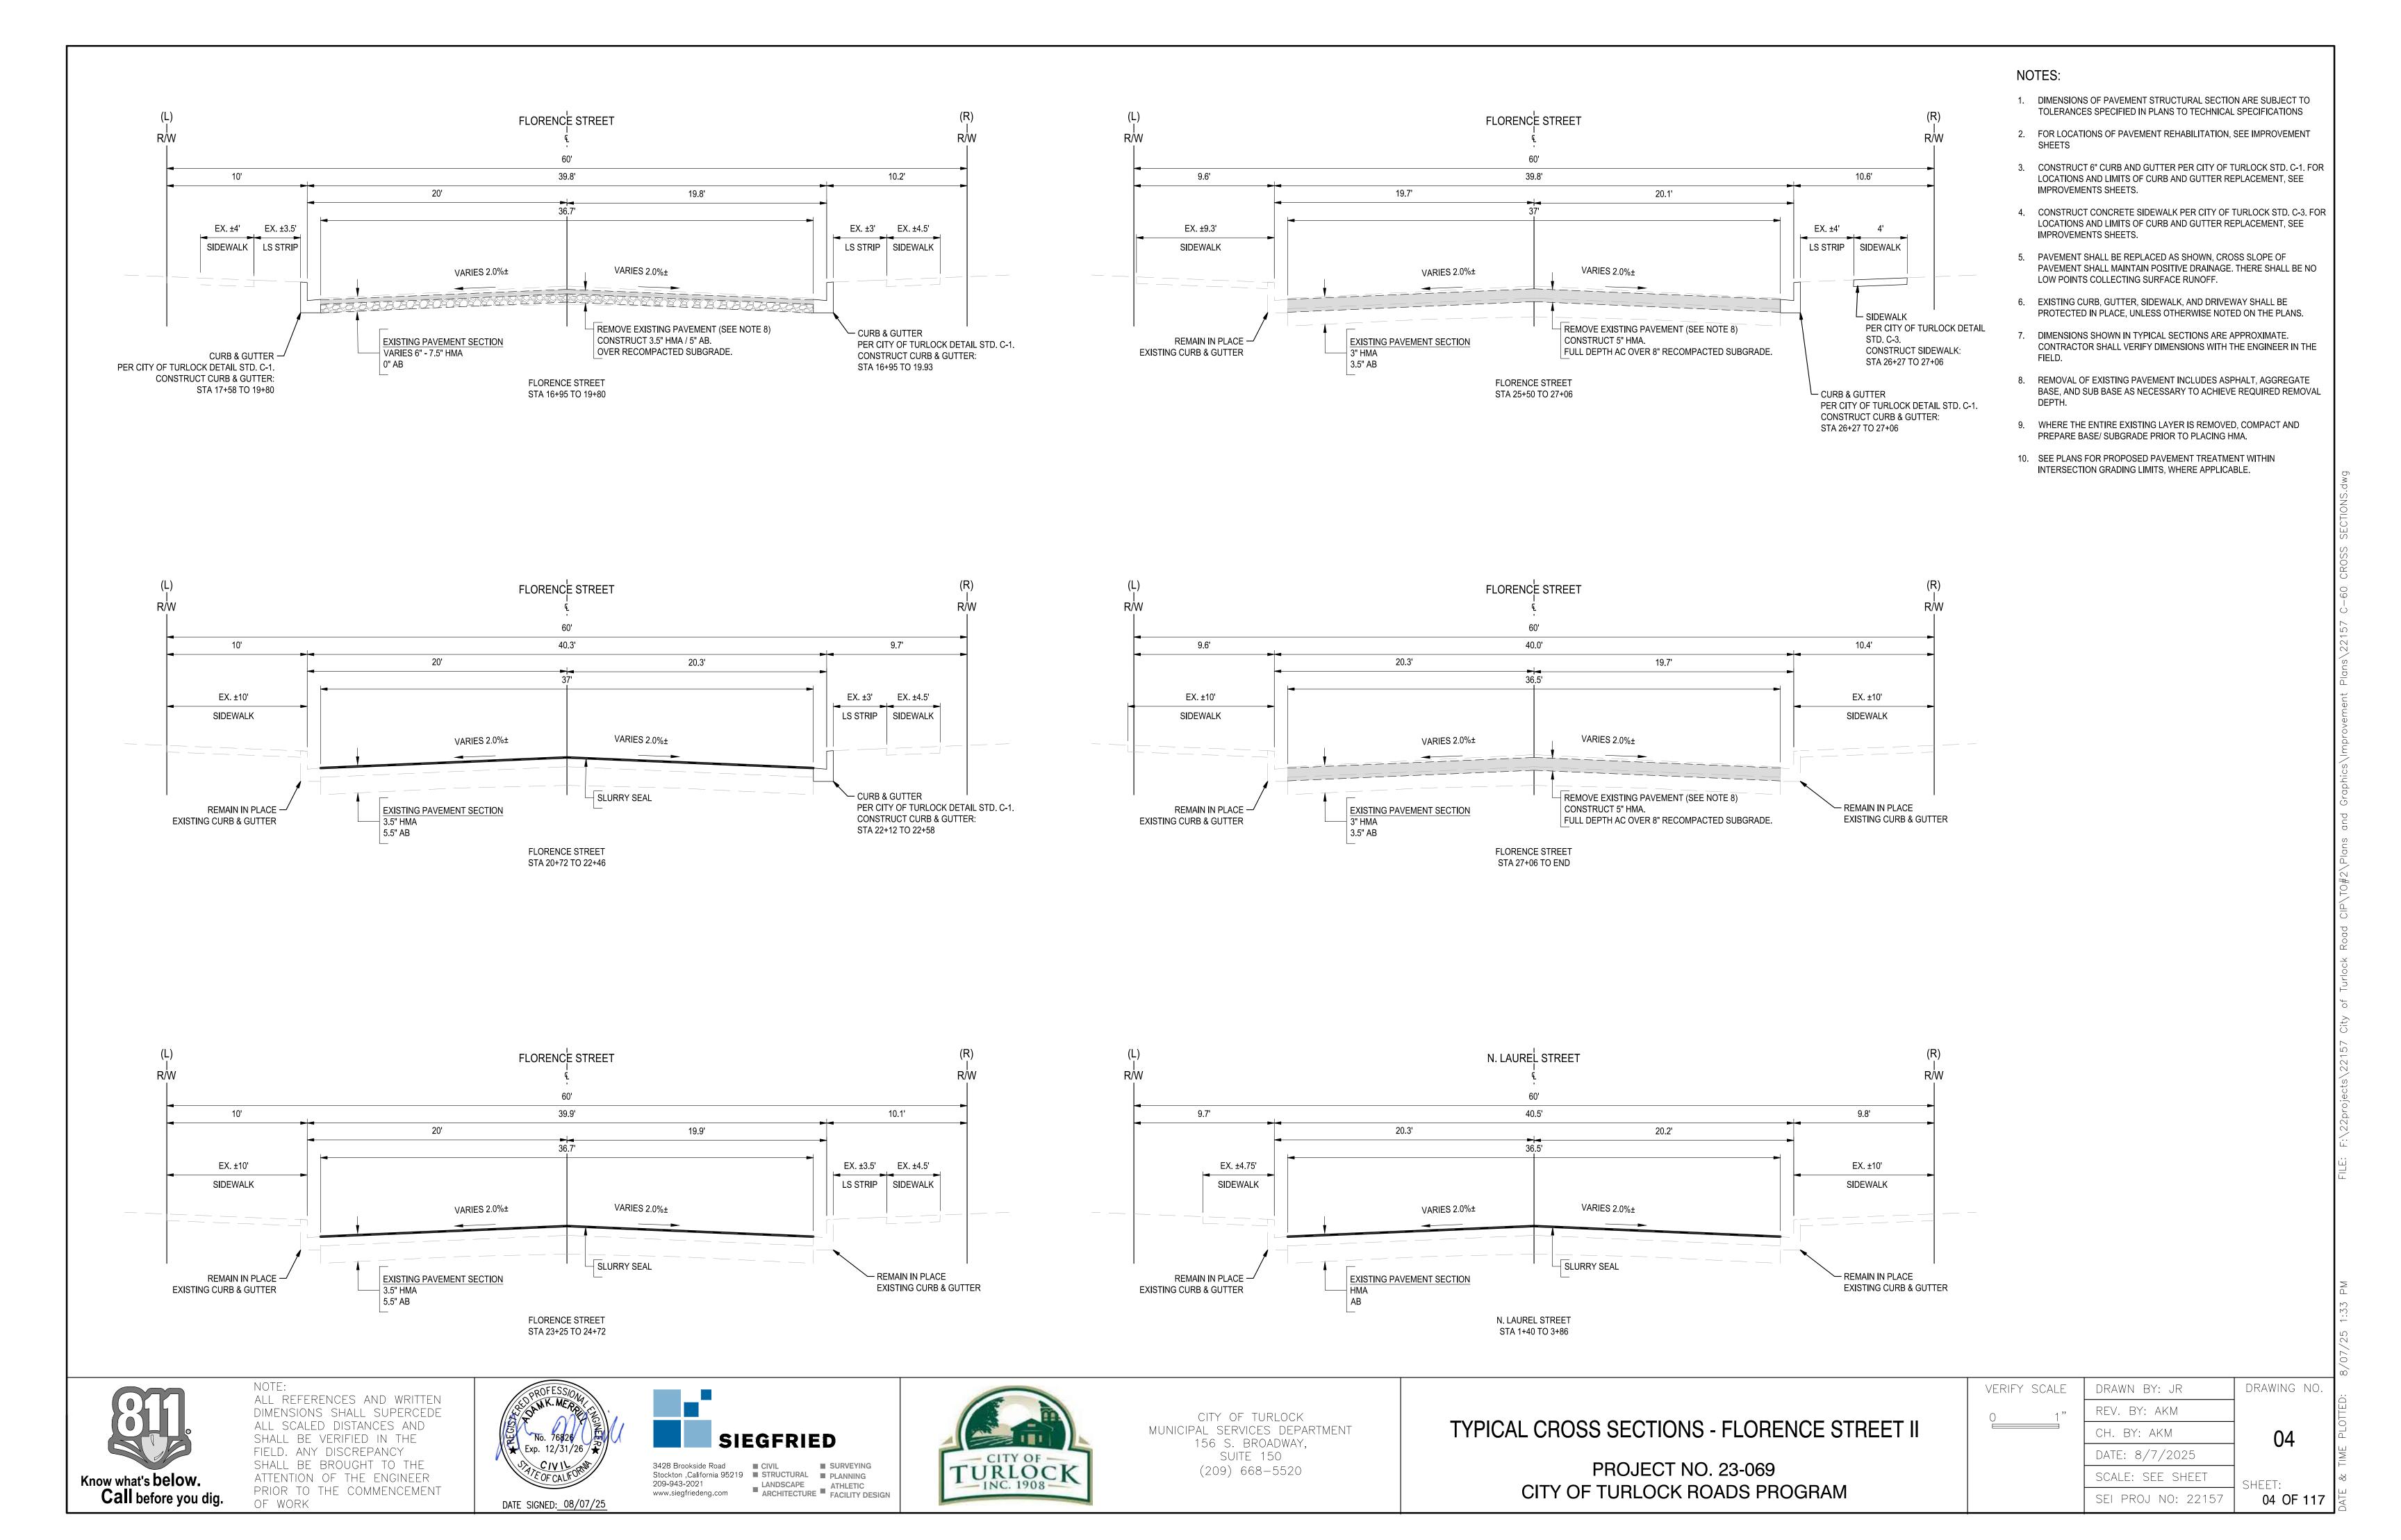

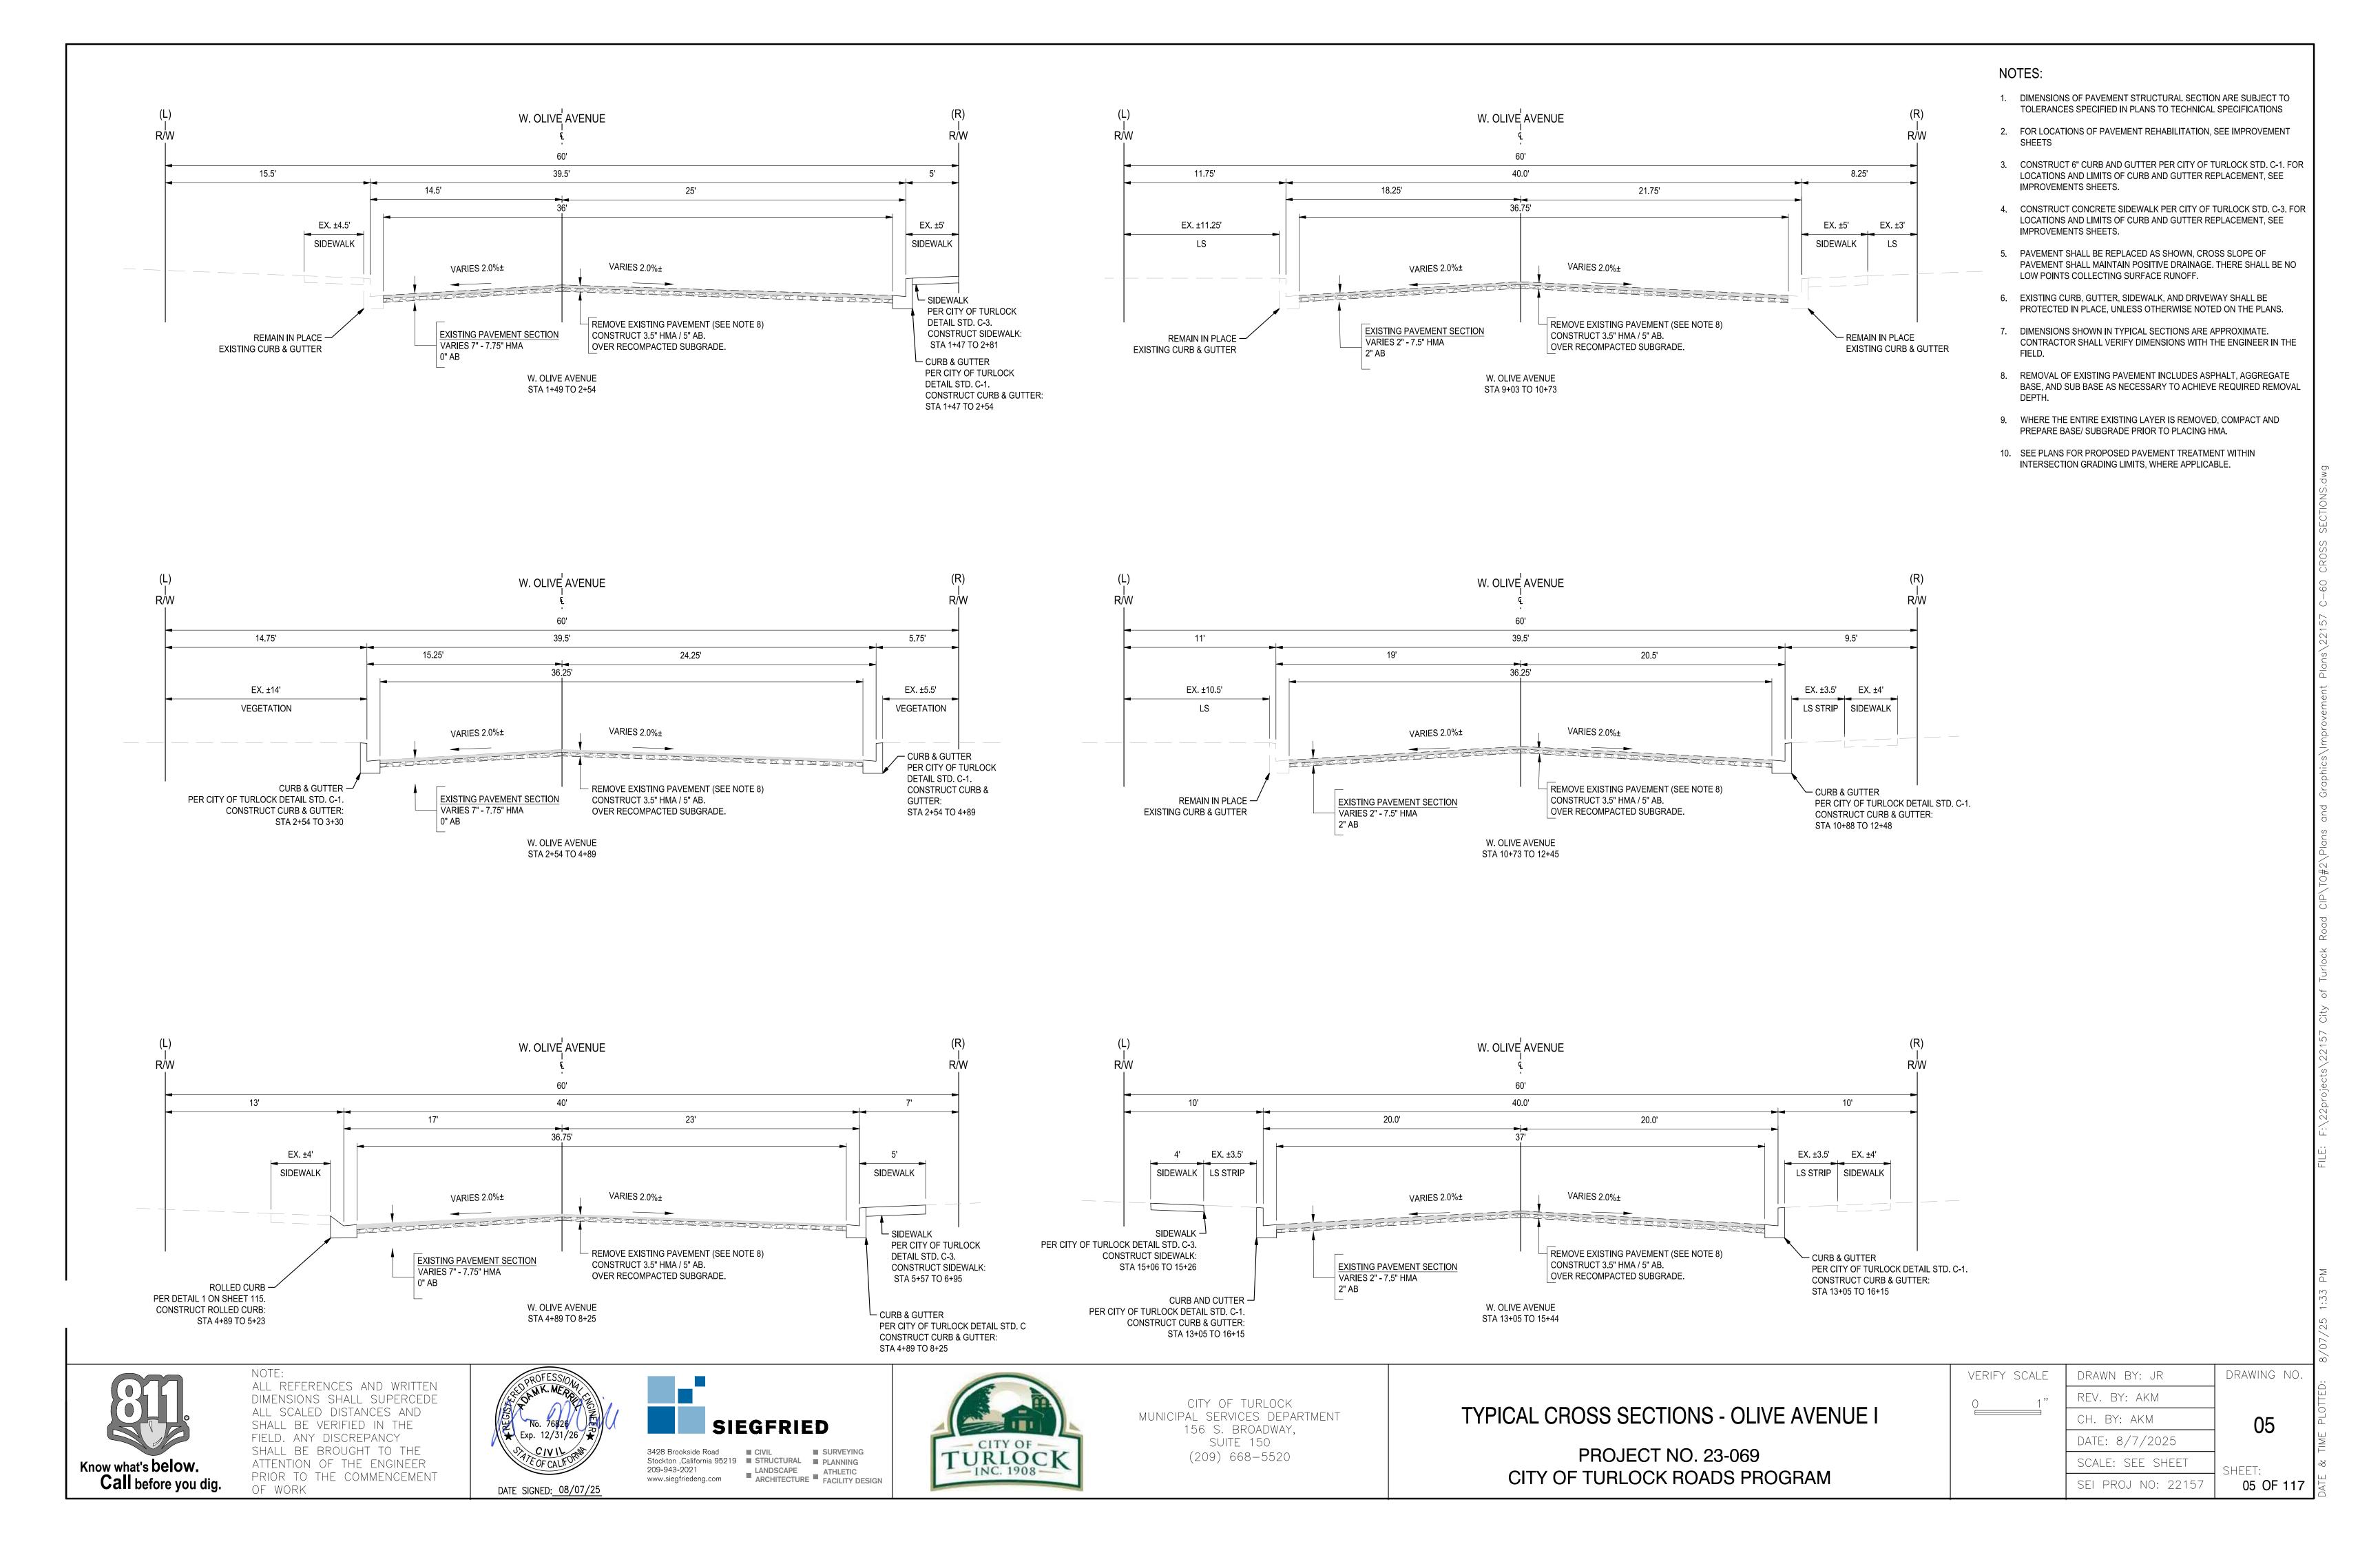

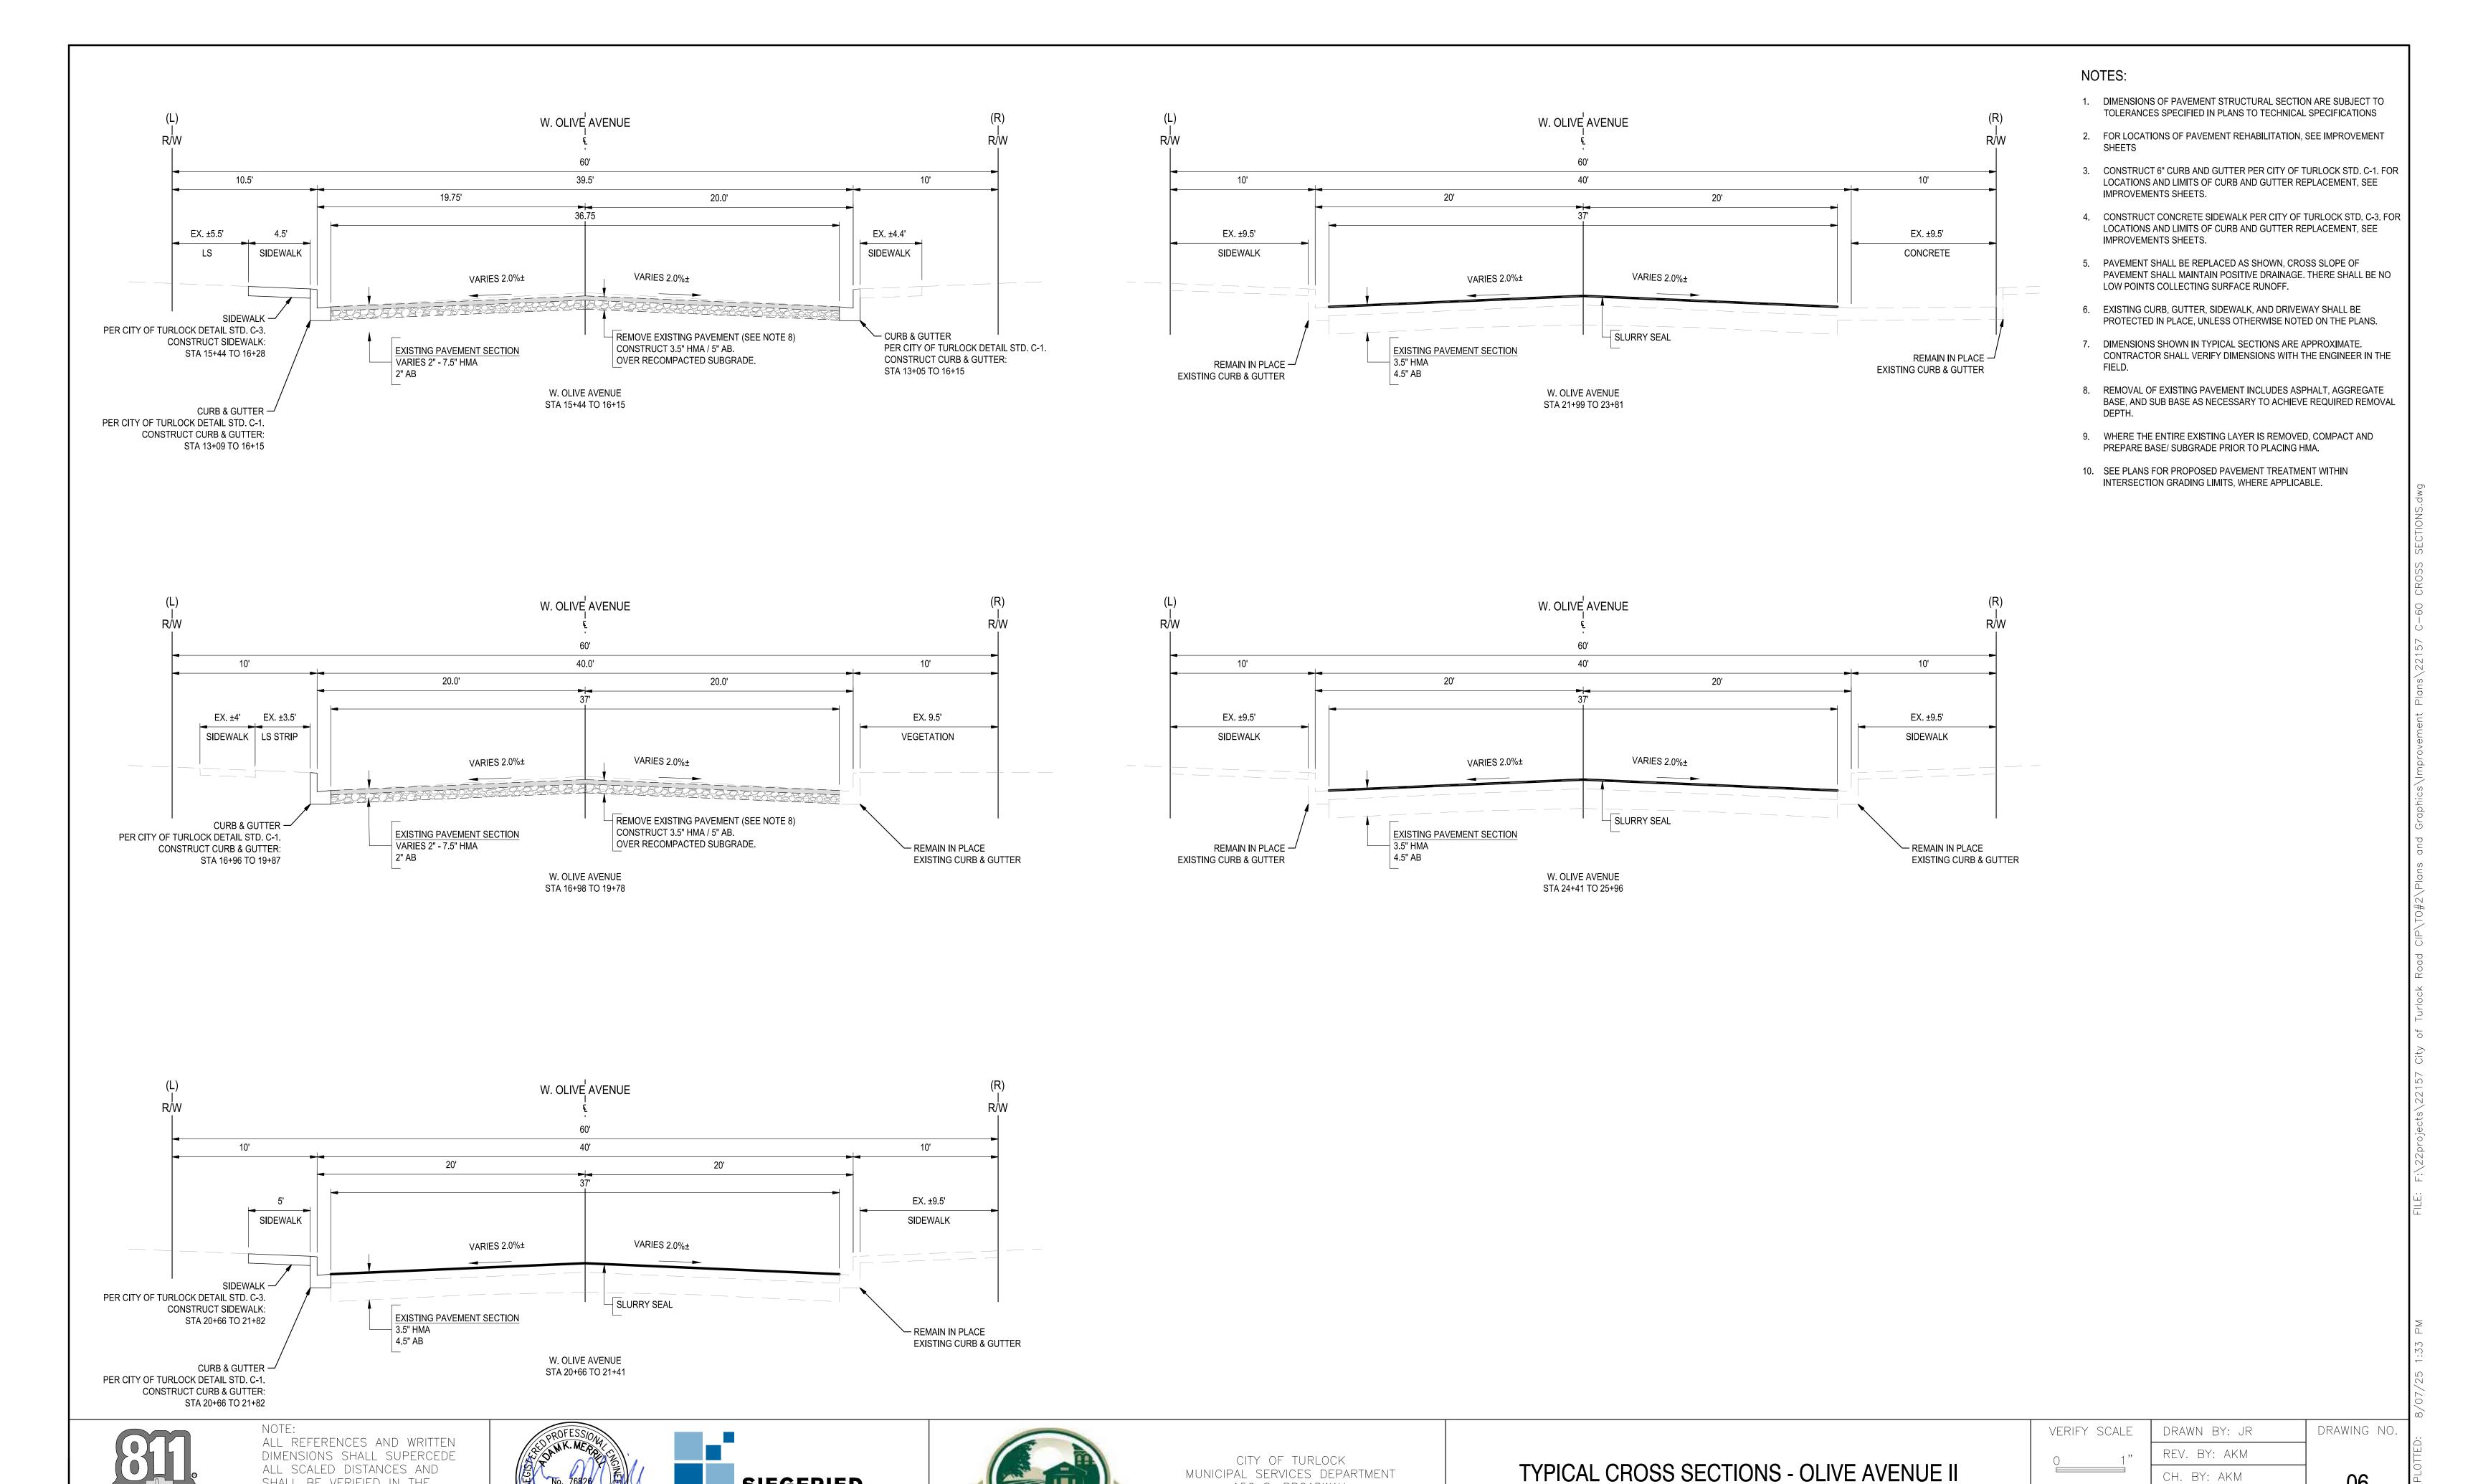

156 S. BROADWAY,

- CITY OF -

TURLOCK

SUITE 150

(209) 668 - 5520

PROJECT NO. 23-069

CITY OF TURLOCK ROADS PROGRAM

SIEGFRIED

LANDSCAPE ATHLETIC FACILITY DESIGN

3428 Brookside Road ■ CIVIL ■ SURVEYING
Stockton ,California 95219 ■ STRUCTURAL ■ PLANNING

www.siegfriedeng.com

DATE SIGNED: 08/07/25

SHALL BE VERIFIED IN THE

SHALL BE BROUGHT TO THE

ATTENTION OF THE ENGINEER

PRIOR TO THE COMMENCEMENT

FIELD. ANY DISCREPANCY

OF WORK

Know what's below.
Call before you dig.

CH. BY: AKM


DATE: 8/7/2025


SCALE: SEE SHEET

SEI PROJ NO: 22157

SHEET:


06 OF 117

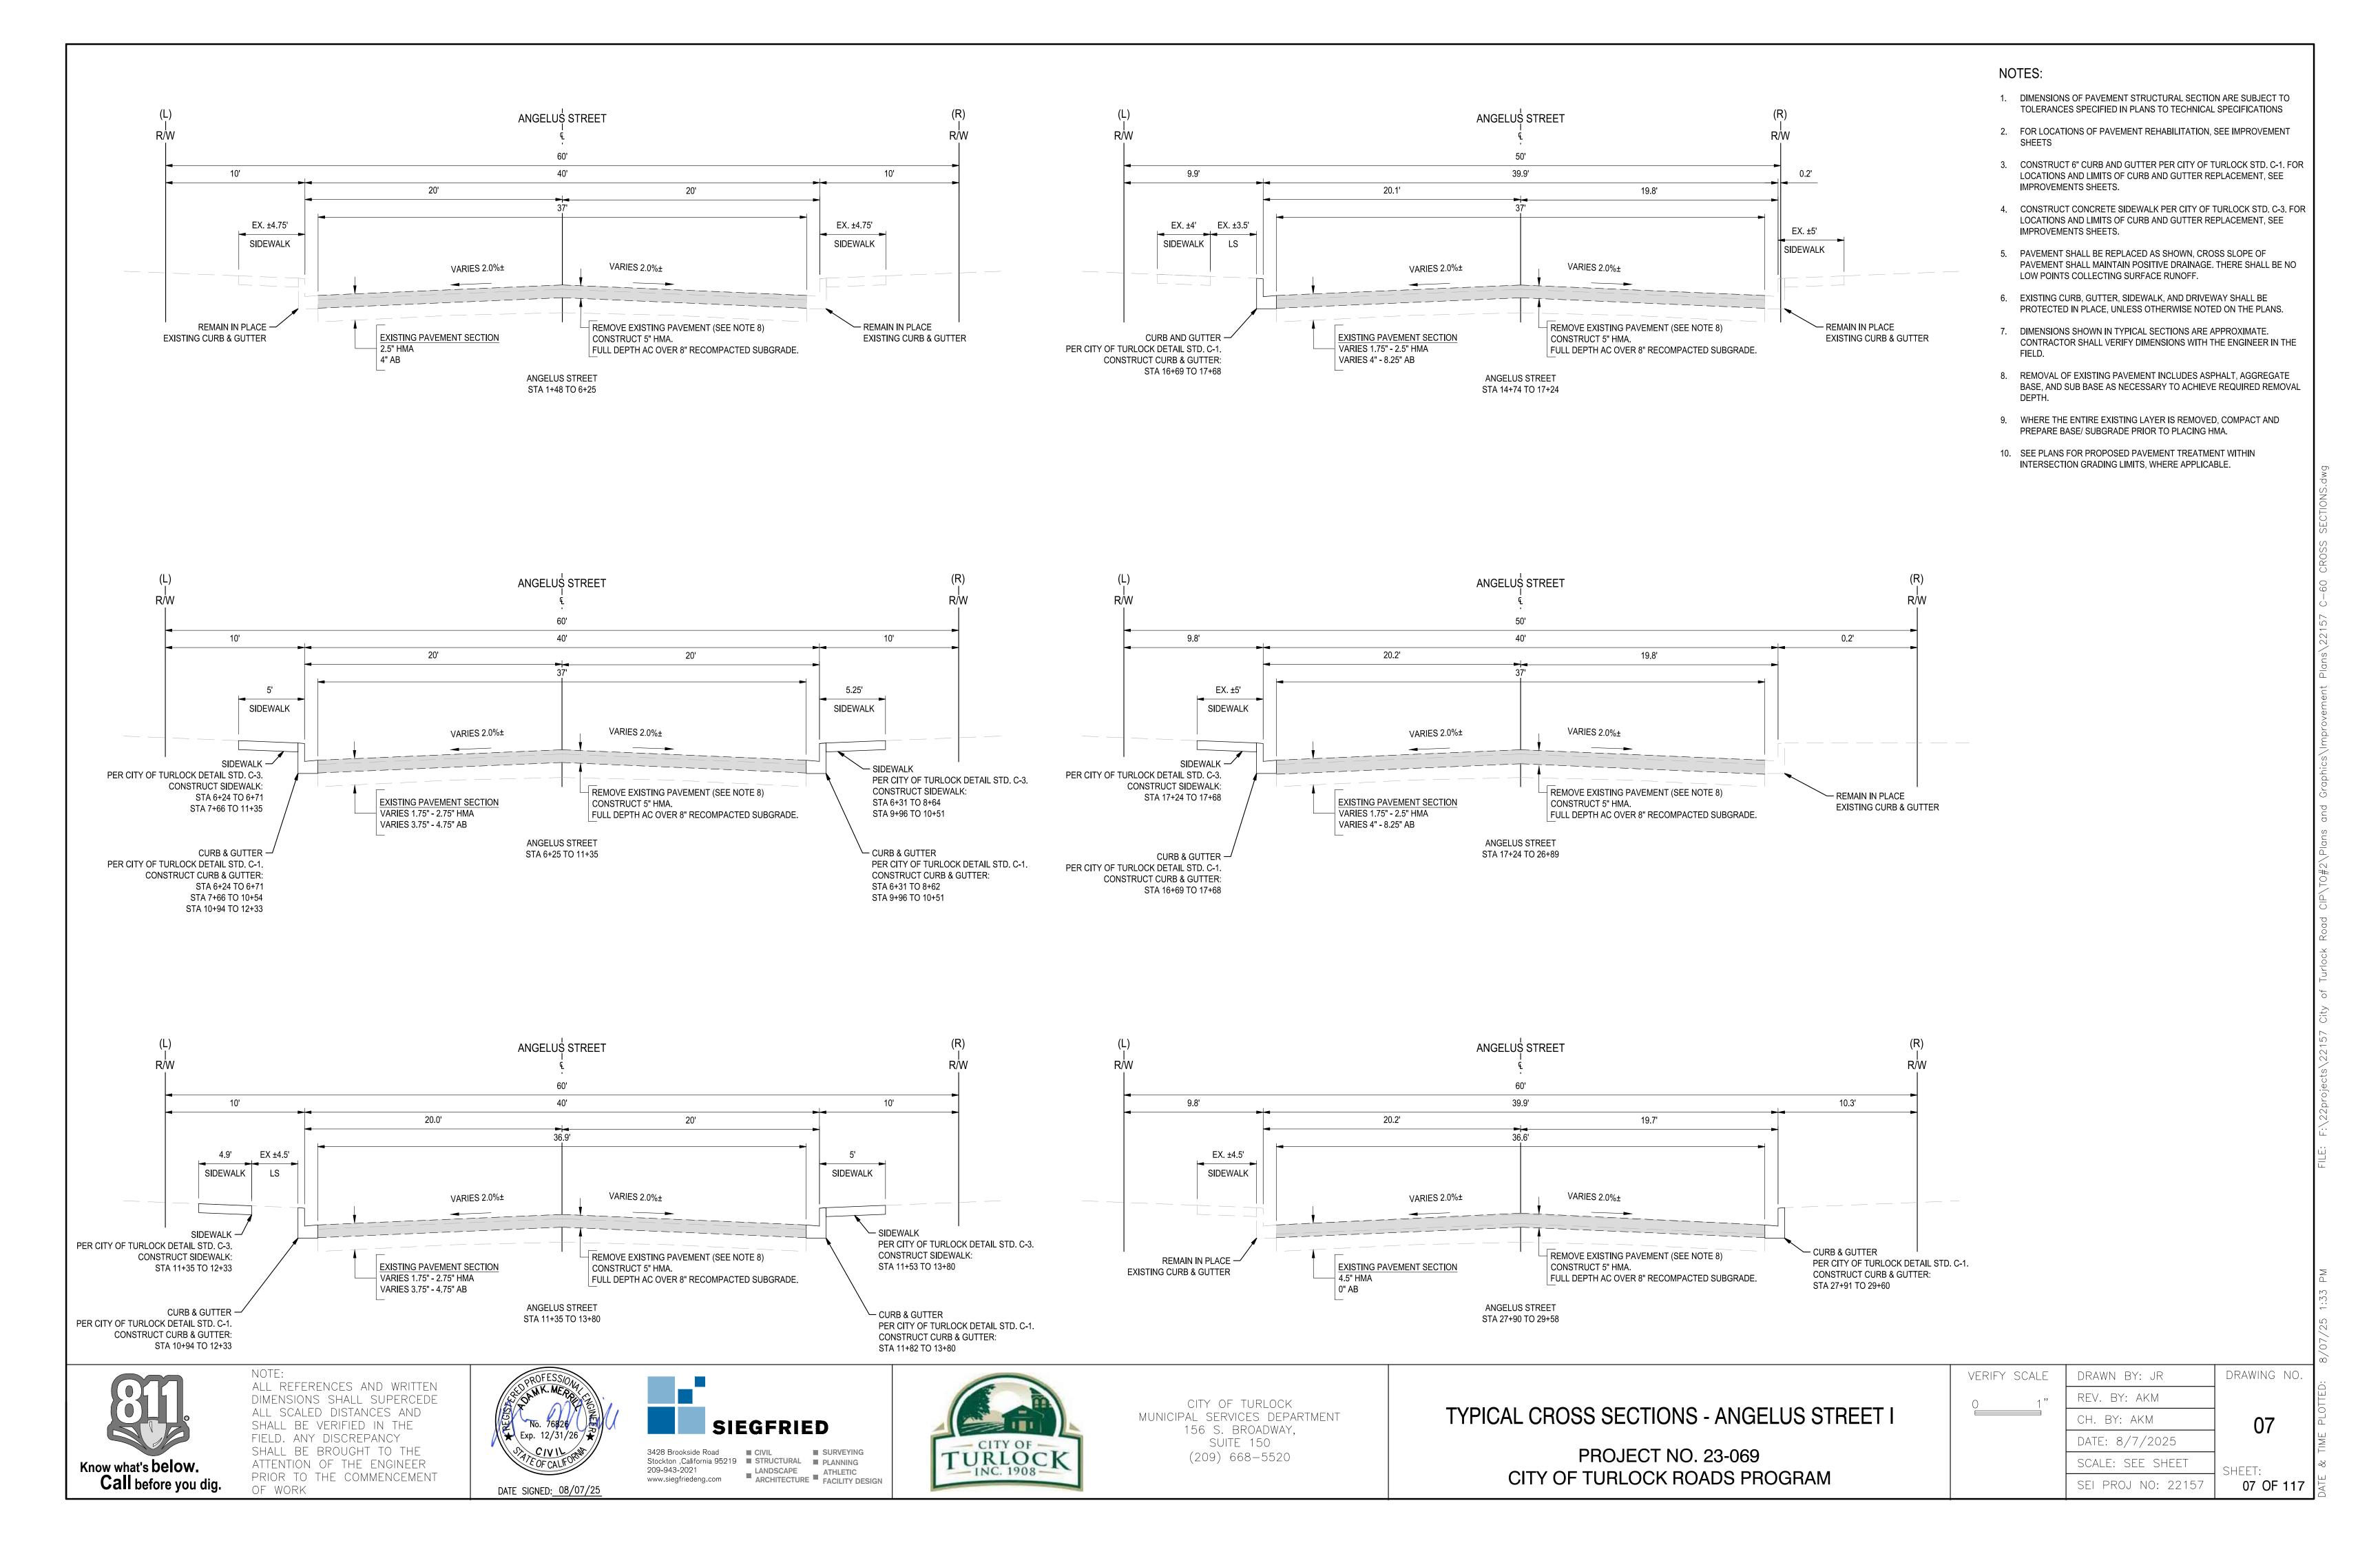

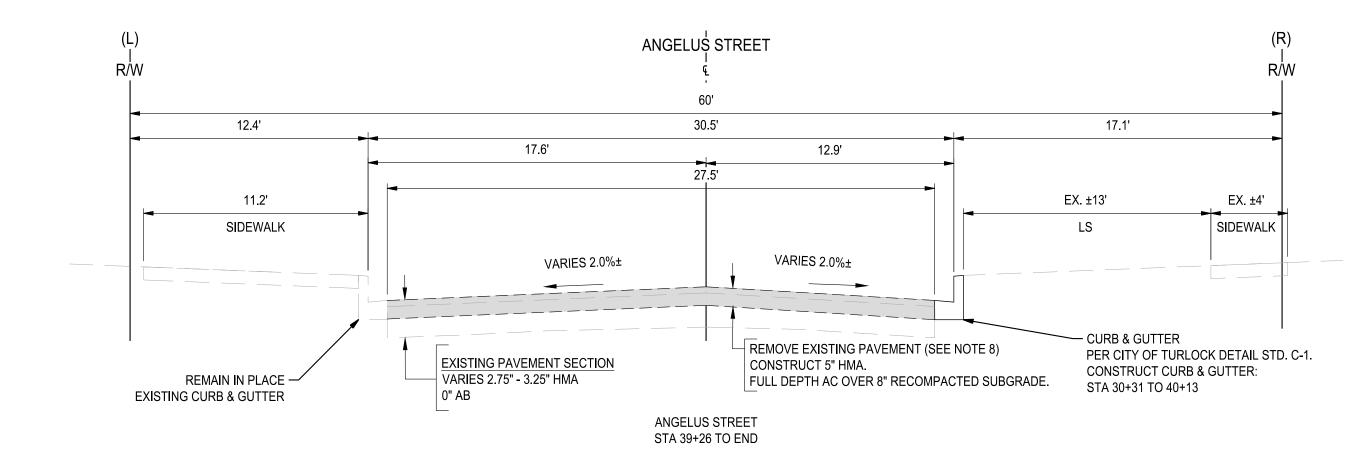


NOTES:


- DIMENSIONS OF PAVEMENT STRUCTURAL SECTION ARE SUBJECT TO TOLERANCES SPECIFIED IN PLANS TO TECHNICAL SPECIFICATIONS
- 2. FOR LOCATIONS OF PAVEMENT REHABILITATION, SEE IMPROVEMENT
- 3. CONSTRUCT 6" CURB AND GUTTER PER CITY OF TURLOCK STD. C-1. FOR LOCATIONS AND LIMITS OF CURB AND GUTTER REPLACEMENT, SEE IMPROVEMENTS SHEETS.
- 4. CONSTRUCT CONCRETE SIDEWALK PER CITY OF TURLOCK STD. C-3. FOR LOCATIONS AND LIMITS OF CURB AND GUTTER REPLACEMENT, SEE IMPROVEMENTS SHEETS.
- 5. PAVEMENT SHALL BE REPLACED AS SHOWN, CROSS SLOPE OF PAVEMENT SHALL MAINTAIN POSITIVE DRAINAGE. THERE SHALL BE NO LOW POINTS COLLECTING SURFACE RUNOFF.
- 6. EXISTING CURB, GUTTER, SIDEWALK, AND DRIVEWAY SHALL BE PROTECTED IN PLACE, UNLESS OTHERWISE NOTED ON THE PLANS.
- 7. DIMENSIONS SHOWN IN TYPICAL SECTIONS ARE APPROXIMATE.
 CONTRACTOR SHALL VERIFY DIMENSIONS WITH THE ENGINEER IN THE
 FIELD.
- 8. REMOVAL OF EXISTING PAVEMENT INCLUDES ASPHALT, AGGREGATE BASE, AND SUB BASE AS NECESSARY TO ACHIEVE REQUIRED REMOVAL
- 9. WHERE THE ENTIRE EXISTING LAYER IS REMOVED, COMPACT AND PREPARE BASE/ SUBGRADE PRIOR TO PLACING HMA.
- 10. SEE PLANS FOR PROPOSED PAVEMENT TREATMENT WITHIN INTERSECTION GRADING LIMITS, WHERE APPLICABLE.

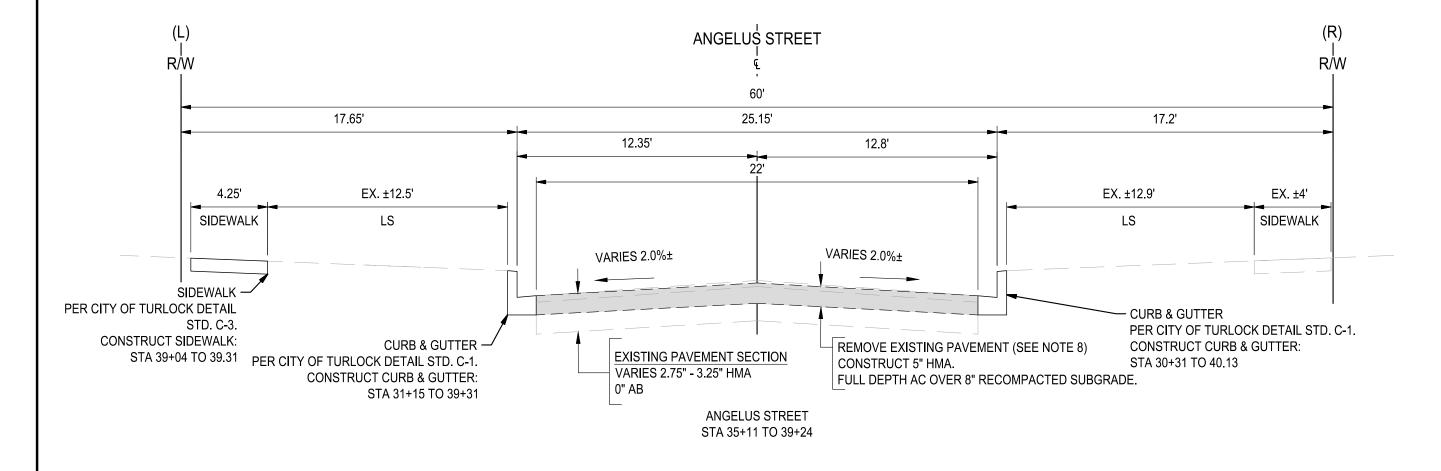


Know what's below.
Call before you dig.

NOTE:
ALL REFERENCES AND WRITTEN
DIMENSIONS SHALL SUPERCEDE
ALL SCALED DISTANCES AND
SHALL BE VERIFIED IN THE
FIELD. ANY DISCREPANCY
SHALL BE BROUGHT TO THE
ATTENTION OF THE ENGINEER
PRIOR TO THE COMMENCEMENT
OF WORK

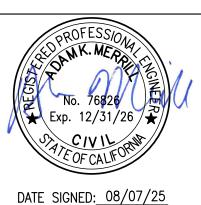

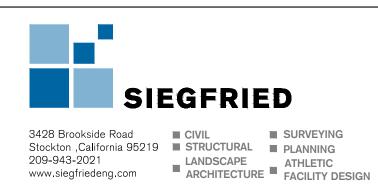

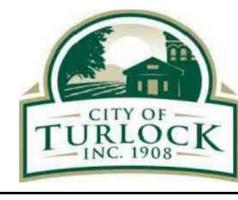

CITY OF TURLOCK
MUNICIPAL SERVICES DEPARTMENT
156 S. BROADWAY,
SUITE 150
(209) 668-5520


TYPICAL CROSS SECTIONS - ANGELUS STREET II


PROJECT NO. 23-069 CITY OF TURLOCK ROADS PROGRAM


VERIFY SCALE	DRAWN BY: JR	DRAWING NO.
0 1"	REV. BY: AKM	
	CH. BY: AKM	08
	DATE: 8/7/2025	
	SCALE: SEE SHEET	SHEET:
	SEI PROJ NO: 22157	08 OF 117


FILE: F:\22projects\22157 City of Turlock Road CIP\TO#2\Plans and Graphics\Improvement Plans

).

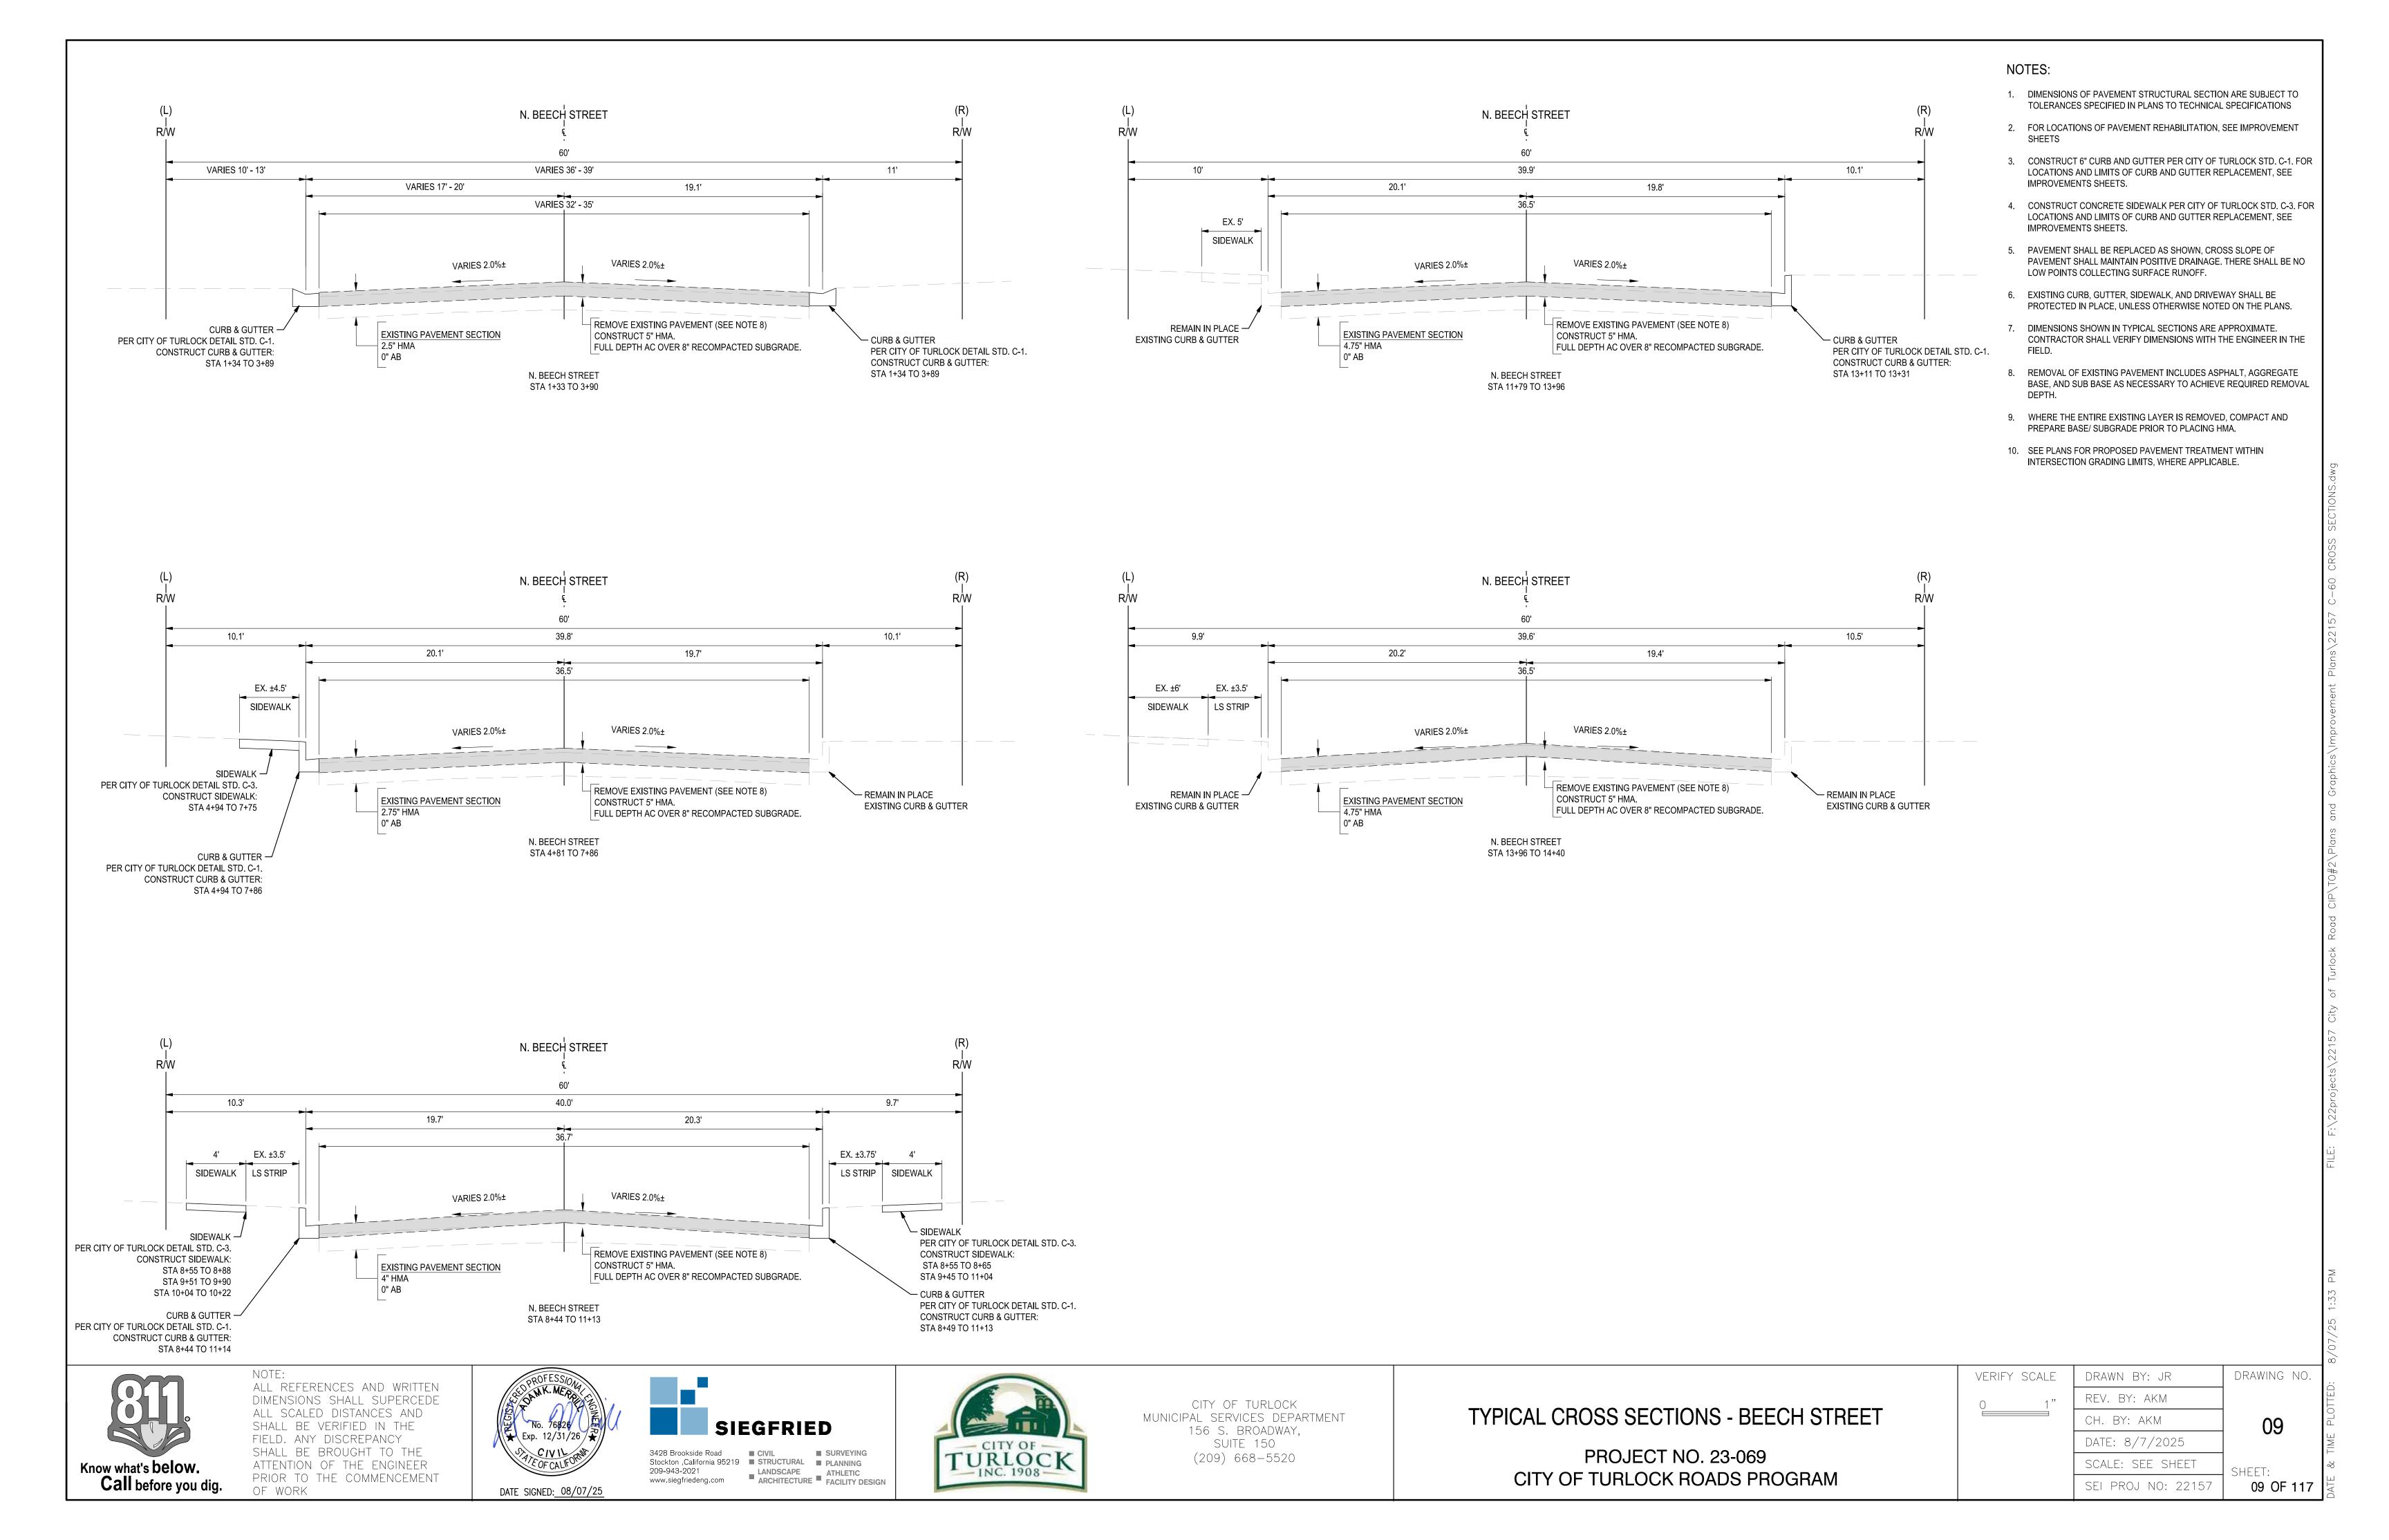

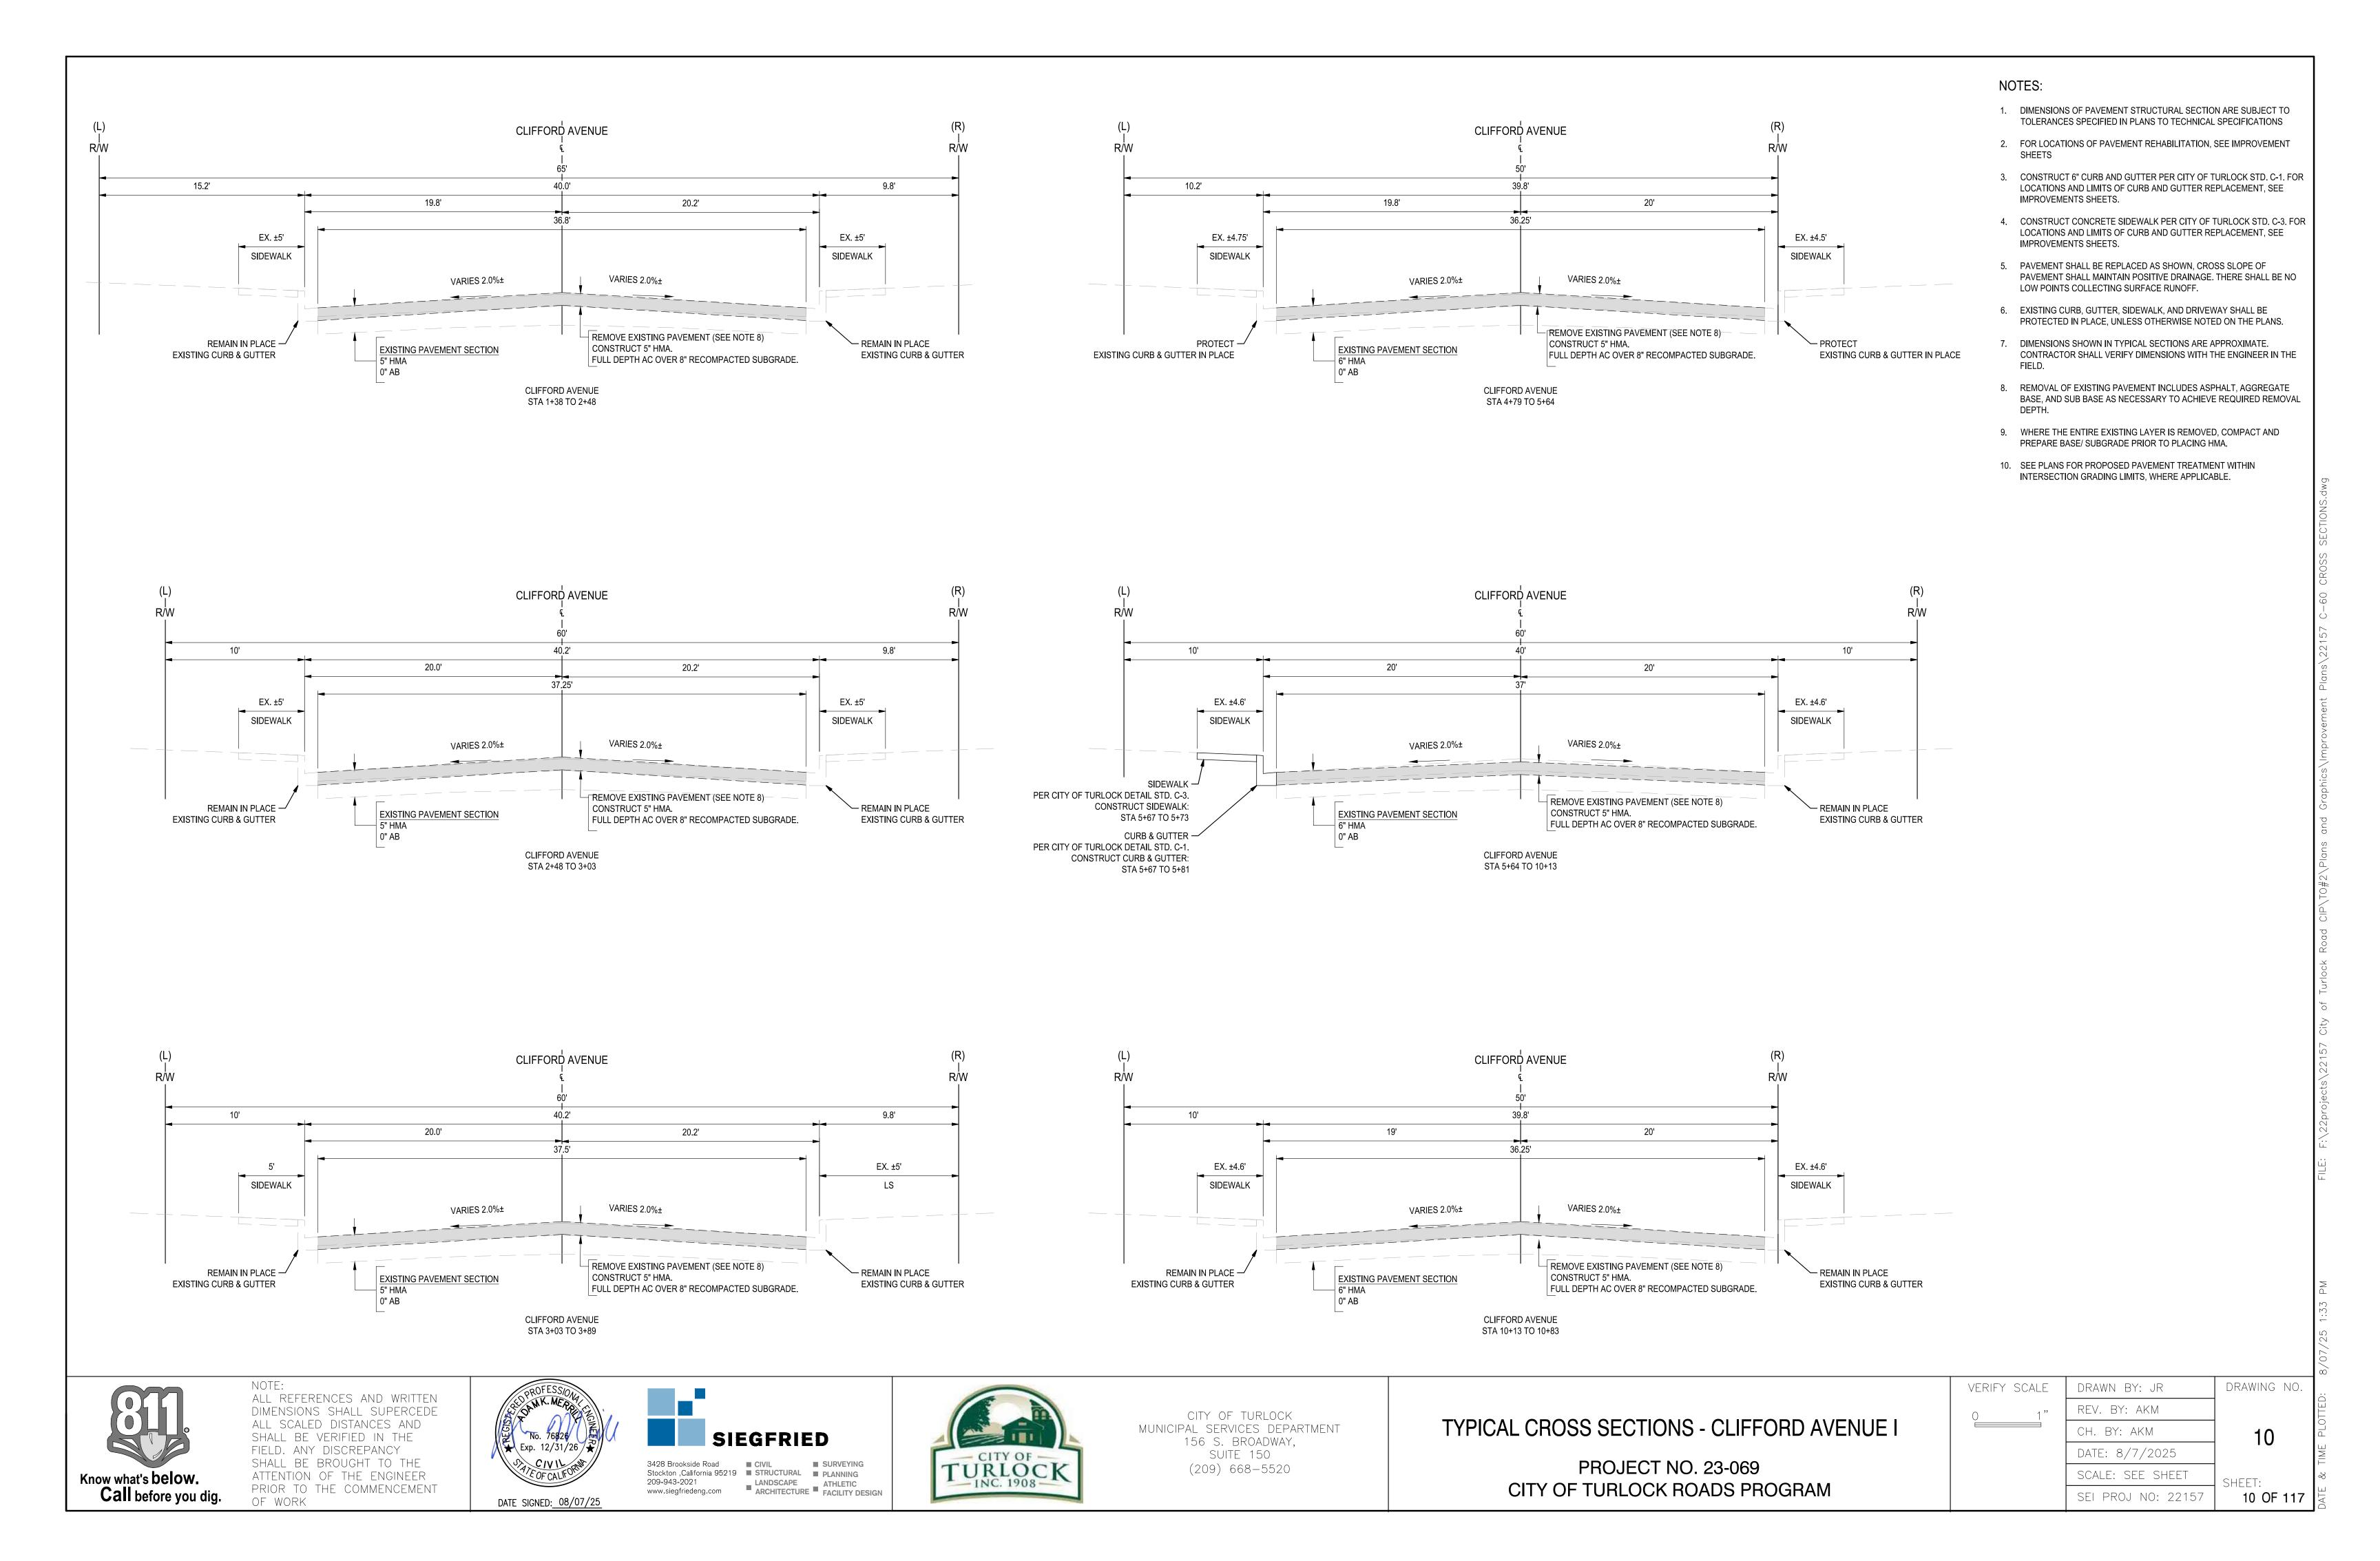

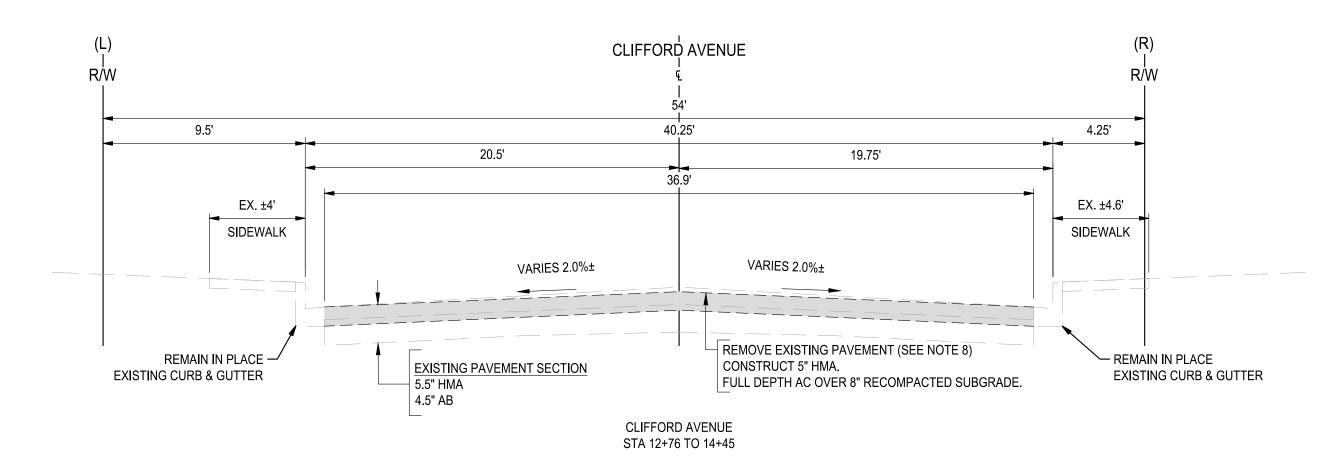

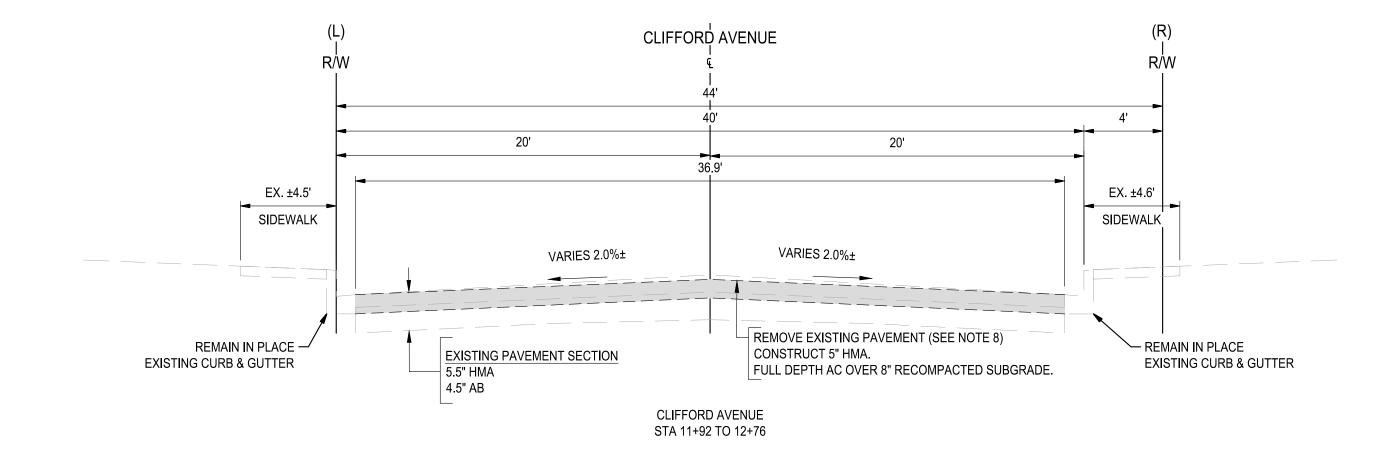





- 1. DIMENSIONS OF PAVEMENT STRUCTURAL SECTION ARE SUBJECT TO TOLERANCES SPECIFIED IN PLANS TO TECHNICAL SPECIFICATIONS
- 2. FOR LOCATIONS OF PAVEMENT REHABILITATION, SEE IMPROVEMENT
- 3. CONSTRUCT 6" CURB AND GUTTER PER CITY OF TURLOCK STD. C-1. FOR LOCATIONS AND LIMITS OF CURB AND GUTTER REPLACEMENT, SEE IMPROVEMENTS SHEETS.
- 4. CONSTRUCT CONCRETE SIDEWALK PER CITY OF TURLOCK STD. C-3. FOR LOCATIONS AND LIMITS OF CURB AND GUTTER REPLACEMENT, SEE IMPROVEMENTS SHEETS.
- 5. PAVEMENT SHALL BE REPLACED AS SHOWN, CROSS SLOPE OF PAVEMENT SHALL MAINTAIN POSITIVE DRAINAGE. THERE SHALL BE NO LOW POINTS COLLECTING SURFACE RUNOFF.
- 6. EXISTING CURB, GUTTER, SIDEWALK, AND DRIVEWAY SHALL BE PROTECTED IN PLACE, UNLESS OTHERWISE NOTED ON THE PLANS.
- 7. DIMENSIONS SHOWN IN TYPICAL SECTIONS ARE APPROXIMATE. CONTRACTOR SHALL VERIFY DIMENSIONS WITH THE ENGINEER IN THE
- 8. REMOVAL OF EXISTING PAVEMENT INCLUDES ASPHALT, AGGREGATE BASE, AND SUB BASE AS NECESSARY TO ACHIEVE REQUIRED REMOVAL
- 9. WHERE THE ENTIRE EXISTING LAYER IS REMOVED, COMPACT AND PREPARE BASE/ SUBGRADE PRIOR TO PLACING HMA.
- 10. SEE PLANS FOR PROPOSED PAVEMENT TREATMENT WITHIN INTERSECTION GRADING LIMITS, WHERE APPLICABLE.



ALL REFERENCES AND WRITTEN DIMENSIONS SHALL SUPERCEDE
ALL SCALED DISTANCES AND
SHALL BE VERIFIED IN THE
FIELD. ANY DISCREPANCY
SHALL BE BROUGHT TO THE
ATTENTION OF THE ENGINEER PRIOR TO THE COMMENCEMENT OF WORK

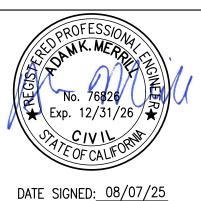




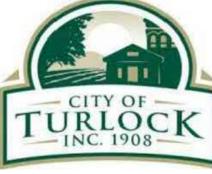

CITY OF TURLOCK MUNICIPAL SERVICES DEPARTMENT 156 S. BROADWAY, SUITE 150 (209) 668-5520

TYPICAL CROSS SECTIONS - CLIFFORD AVENUE II

DRAWN BY: JR	DRAWING NO.
REV. BY: AKM	
CH. BY: AKM	11
DATE: 8/7/2025	
SCALE: SEE SHEET	SHEET:
SEI PROJ NO: 22157	11 OF 117
	REV. BY: AKM CH. BY: AKM DATE: 8/7/2025 SCALE: SEE SHEET

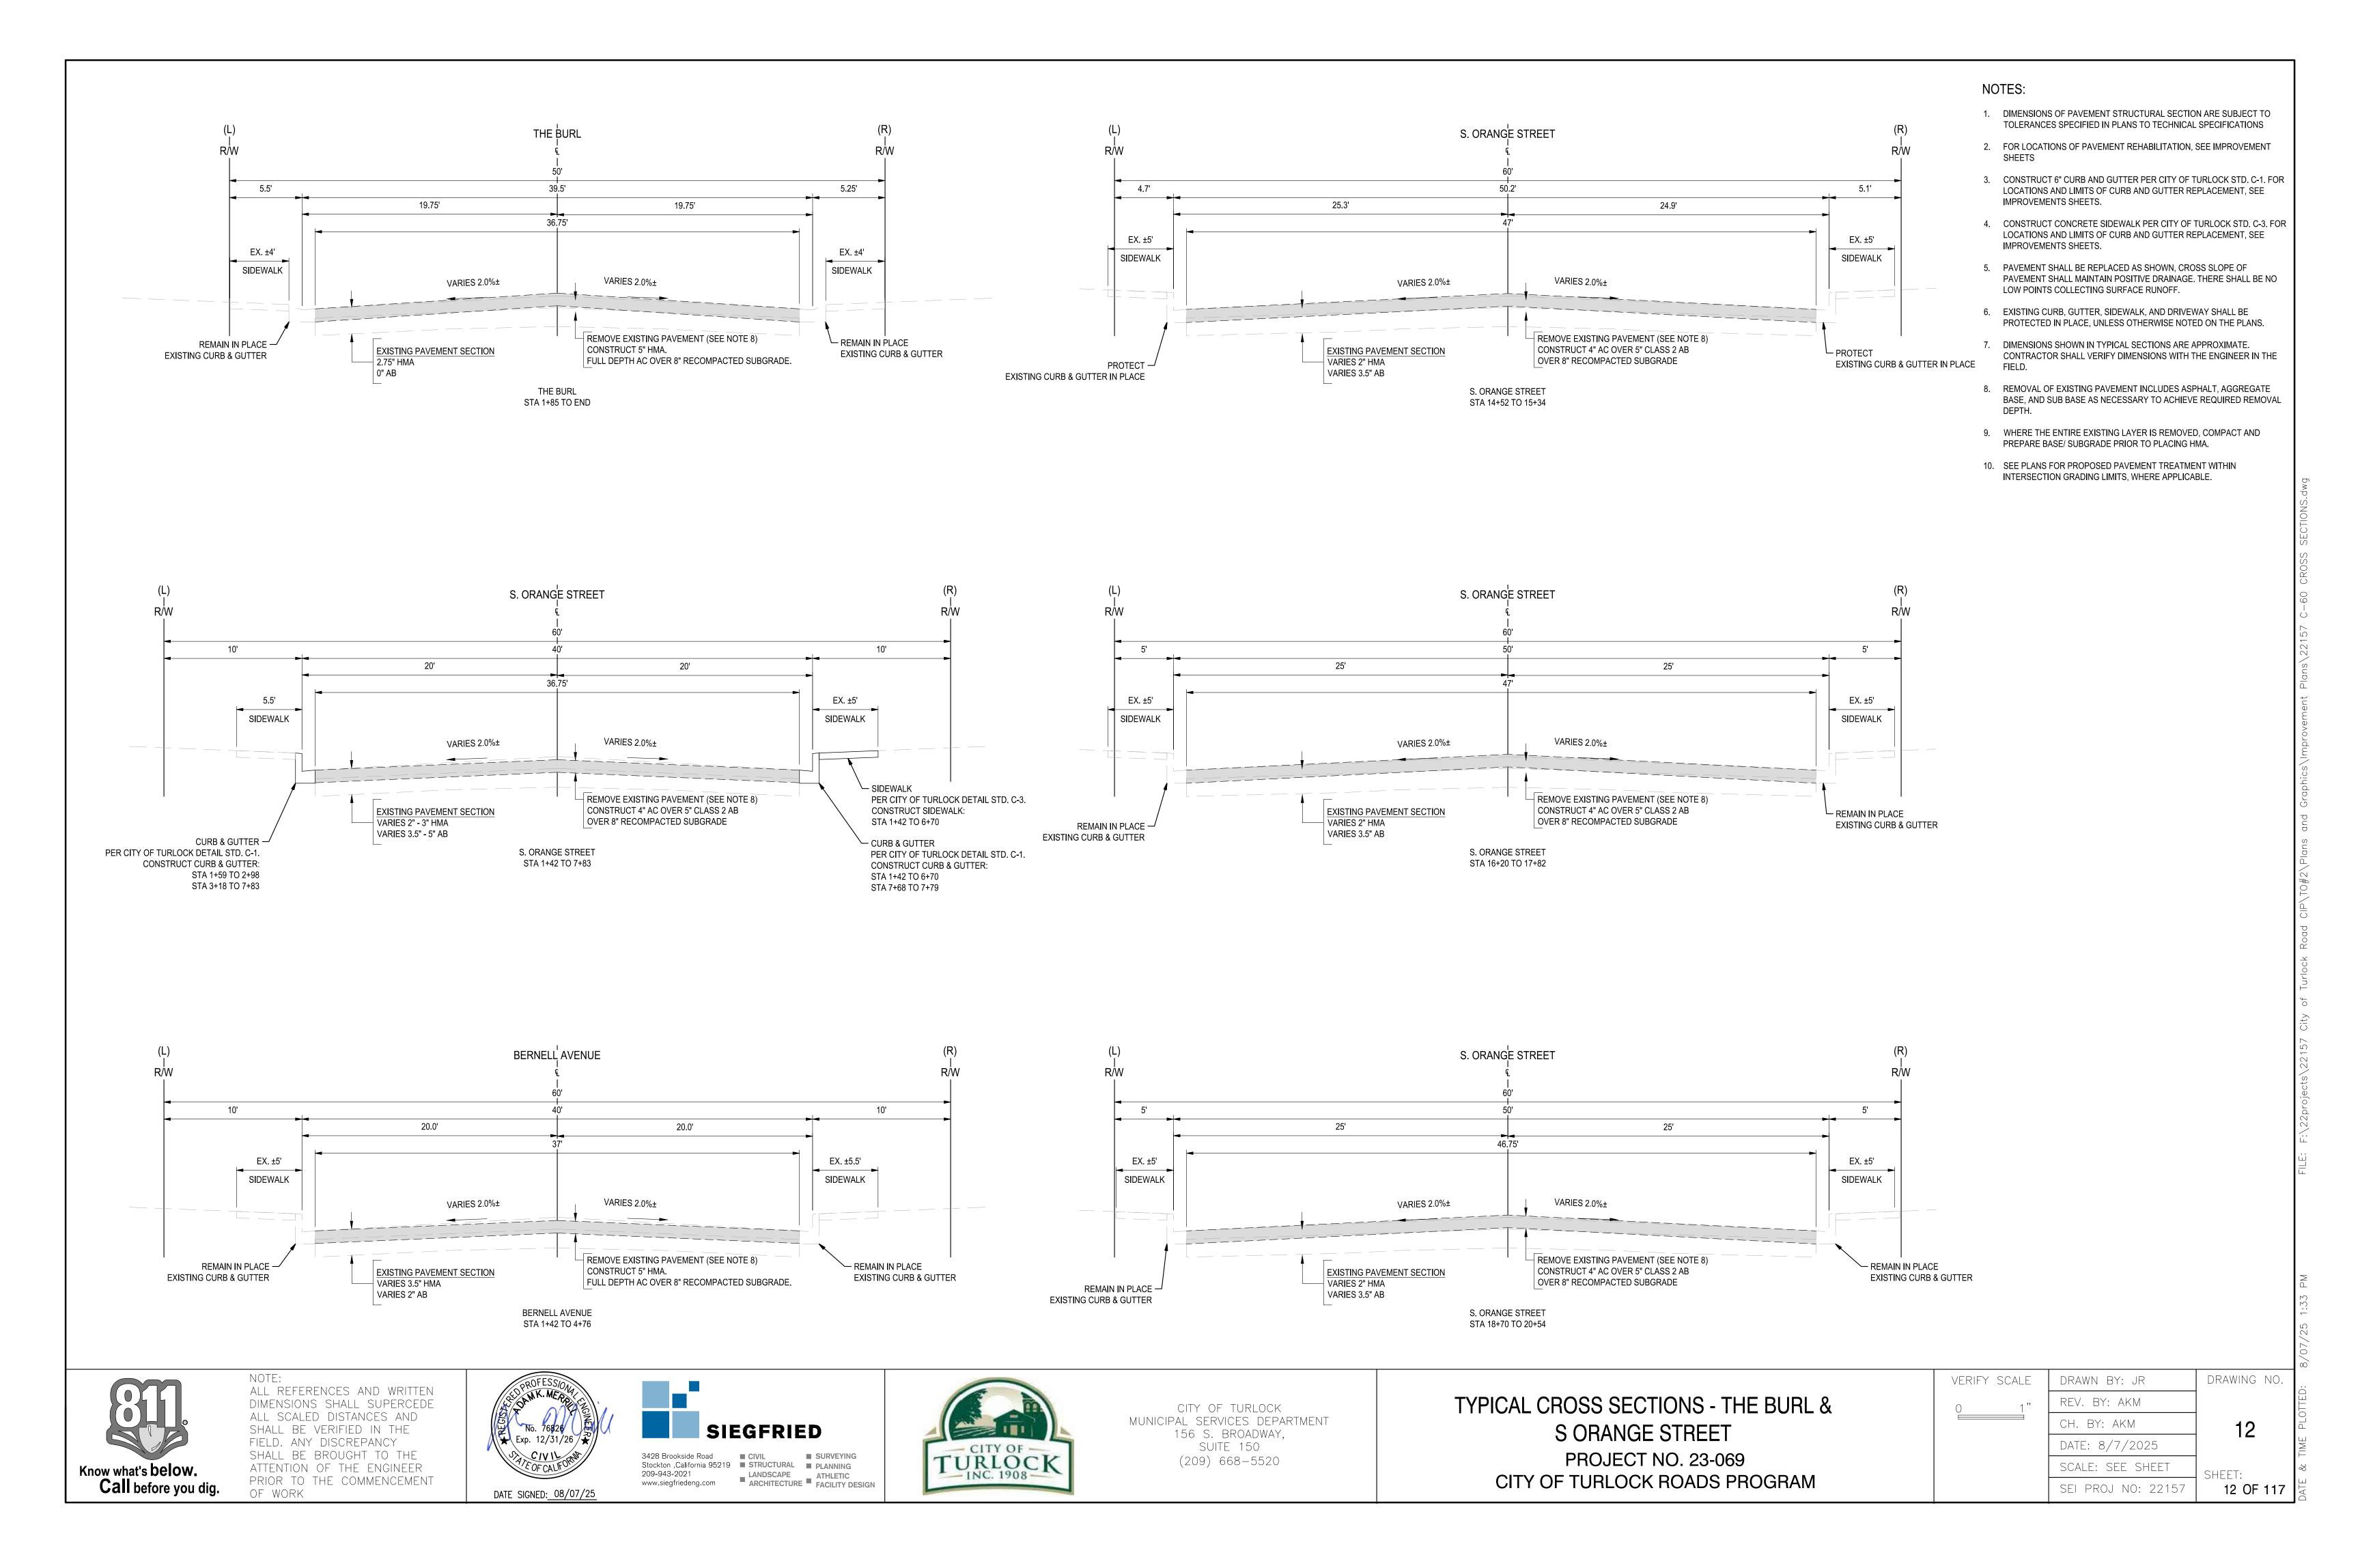

PROJECT CONTROL POINT TABLE

NT NO.	NORTHING	EASTING	ELEVATION	FOUND/SET	DESC	CRIPTION	1
1402	2002762.55	6459722.21	98.55	MF	IP	1"	LS 8078
1501	2003233.06	6460427.78	99.96	MF	BD	2"	
1502	2002967.55	6460131.47	99.71	MF	BD	2"	
1503	2002762.66	6459903.22	99.24	MF	IP	1"	
1504	2002763.28	6458972.17	98.71	MF	RB	1"	
1505	2002763.81	6458550.28	98.09	MF	RB	1"	
1506	2002766.48	6457795.70	95.90	MF	RB	1"	LS 7823
1550	2002886.86	6457402.48	95.81	MF	IP	3/4"	RCE 40990
1551	2002112.42	6457409.28	96.78	MF	IP	3/4"	LS 5443
1553	2002686.39	6457825.42	96.94	MF	IP	3/4"	
1556	2002469.80	6458152.51	96.24	MF	IP	3/4"	
1557	2002437.30	6458969.78	98.56	MF	IP	3/4"	
1558	2002257.12	6458938.54	99.18	MF	IP	3/4"	
1559	2002436.39	6459357.66	99.15	2' SWING TIE			
1560	2002438.27	6459359.78	99.12	2' SWING TIE			
1561	2002436.27	6459359.65	99.12	CL NAIL FUTURE MON			
1562	2002403.56	6460289.79	100.21	MF	СС	2"	
1812	2002436.07	6457794.66	95.82		IP	3/4"	LS 7823
1813	2002435.36	6459719.93	98.55		IP	3"	
1814	2002416.24	6460319.73	97.85		RB	3/4"	
1815	2002410.24	6460363.14	99.82		IP	3/4"	LS 5443
1816	2002133.23	6457429.39	97.52		IIP	3/4"	LS 7823
2000	2002082.27	6459747.02	99.07				L3 7023
2003	2002120.86	6456745.83	97.64				
						0,"	IN MON WELL
2210	2003425.25	6457457.00	97.52		CC	2"	IN MON WELL
2211	2003349.73	6457456.84	96.97		CC	2"	IN MON WELL
2212	2002827.99	6457453.96	96.23		CC	2"	
2213	2002971.20	6457455.28	96.02		CC	2"	
2214	2002498.26	6459380.37	98.85		CC	2"	IN MON WELL
2215	2003182.58	6458958.06	98.96		CC	2"	
2216	2003506.31	6458989.67	98.94		CC	2"	
2414	2003241.82	6460447.74	100.25	MS	CC	2"	
2415	2002779.40	6458945.95	98.33	MS	CC	2"	
2416	2002468.20	6459866.89	99.59	MS	CC	2"	
2417	2002742.18	6459686.88	99.36	MS	CC	2"	
2418	2002743.64	6459328.75	98.32	MS	CC	2"	
2419	2003111.61	6458949.28	98.63	MS	CC	2"	
2420	2002417.35	6459000.27	98.55	MS	СС	2"	
2421	2002743.99	6458521.59	97.88	MS	CC	2"	IN MON WELL
2422	2002730.23	6458945.87	98.57	MS	CC	2"	IN MON WELL
2423	2002462.43	6458526.36	97.81	MS	СС	2"	IN MON WELL
2424	2002451.14	6459329.70	98.42	MS	PK	1/2"	IN MON WELL
2824	2004318.95	6457063.47	97.01	MS	СС	2"	IN MON WELL
2825	2004629.29	6457036.41	97.36	MS	CC	2"	IN MON WELL
2826	2004362.42	6456613.76	97.28	MS	СС	2"	IN MON WELL
2827	2003186.55	6457457.15	95.62	MS	СС	2"	IN MON WELL
2828	2003122.49	6457840.67	96.23	MS	СС	2"	IN MON WELL
2829	2002132.26	6457453.50	97.22	MF	CC	2"	IN MON WELL
2830	2002742.34	6459863.32	100.08	MS	CC	2"	IN MON WELL
2831	2003241.84	6460447.74	100.31		CC	2"	IN MON WELL
2832	2002779.42	6458945.94	98.41		PK		IN MON WELL
2900	2002/75.12	6457825.04	96.72		PK		
2903	2003207.39	6460410.20	100.61		PK		
2903	2003207.39	6460512.15	101.52		PK		
2904			97.75		PK		
3203	2004697.87	6457071.36				2"	TEMPODADY
A // / -	2002520.52	6457454.59	96.07	IVIO	INK		TEMPORARY

SURVEY CONTROL NOTES:

HORIZONTAL DATUM IS BASED ON THE CITY OF TURLOCK G.P.S. CONTROL NETWORK SURVEY FILED IN BOOK 20 OF SURVEYS AT PAGE 56, STANISLAUS COUNTY RECORDS. SAID SURVEY IS BASED ON THE 1983 NORTH AMERICAN DATUM AND ADJUSTMENT AS SHOWN ON THE FACE OF SAID SURVEY. POINTS H12 AND L9 AS SHOWN ON THE SURVEY WERE USED AS THE BASE CONTROL FOR THIS PROJECT.

COORDINATE SYSTEM:
CALIFORNIA COORDINATE SYSTEM OF 1983 (CCS83), ZONE III.

ALL REFERENCES AND WRITTEN DIMENSIONS SHALL SUPERCEDE
ALL SCALED DISTANCES AND
SHALL BE VERIFIED IN THE
FIELD. ANY DISCREPANCY
SHALL BE BROUGHT TO THE
ATTENTION OF THE ENGINEER
PRIOR TO THE COMMENCEMENT
OF WORK Know what's **below. Call** before you dig.







CITY OF TURLOCK MUNICIPAL SERVICES DEPARTMENT 156 S. BROADWAY, SUITE 150 (209) 668-5520

CHESTNUT STREET

PARK STREET

× ²⁸²⁸FLOWER STREET

SHEETS 31, 32, 33,21, 22, 23, 45, 46, 47, 84, 85

FLORENCE STREET.

SHEETS 34, 35, 24, 25, 48, 49, 88, 89

W MAIN STREET

FOR CONTINUATION SEE SHEET 04

JULIAN STREET

KEYMAP & SURVEY CONTROL POINTS PLAN I

PROJECT NO. 23-069 CITY OF TURLOCK ROADS PROGRAM

VERIFY SCALE	DRAWN BY: JR	DRAWING NO.
0 1"	REV. BY: AKM	
	CH. BY: AKM	13
	DATE: 8/7/2025	
	SCALE: SEE SHEET	SHEET:
	SEI PROJ NO: 22157	13 OF 117

HORIZONTAL DATUM:

VERTICAL DATUM: CITY OF TURLOCK BENCHMARK SYSTEM.


DATE SIGNED: 08/07/25

NOT TO SCALE

PROJECT CONTROL POINT TABLE


	MODITHING			FOLIND/SET	DECO	PIDTION	
POINT NO.	NORTHING 1999888.92	EASTING 6457780.29	ELEVATION 95.38	FOUND/SET	NA	RIPTION 1/4"	
1564	1999423.77	6456446.21	93.36		IR	3/4"	
1565	1999938.67	6456479.51	95.22		IP	3/4"	
1566	1999855.06	6458869.05	95.73		IP	3/4"	
1567	1999975.61	6459343.19	96.69		BOLT	3/4"	LS 7823
1568	1999974.28	6459835.54	96.97		IR		
1569	1999973.56	6460048.01	96.70		NA	1/4"	
1570	1999973.05	6460045.06	96.72		PK	5/8"	
1811	1998721.97	6459753.24	96.35	MF	IP	3/4"	PLS 7601
1817	1998723.23	6459335.07	96.04	MF	IP	3/4"	LS 7604
1818	1997967.09	6459331.03	95.90	MF	IP	3/4"	
1819	1997717.05	6459335.35	95.44	MF	IP	3/4"	
1820	1997444.43	6459333.64	96.70	MF	IP	3/4"	
1821	1999858.74	6457734.50	95.09	MF	IP	3/4"	
1822	1999843.74	6457749.53	95.00	MF	IP	3/4"	
1823	1999892.91	6456662.68	95.15	MF	PK	1"	
1824	1999922.96	6456662.90	94.50	MF	IP	3/4"	
1825	1999862.92	6456653.64	94.87	MF	IP	3/4"	LS 5443
1826	1999863.19	6456589.64	94.86	MF	IP	3/4"	LS 5443
1827	1999863.53	6456494.17	94.79	MF	IP	3/4"	LS 5443
1828	1999848.60	6456479.08	94.87	MF	IP	3/4"	LS 5443
1829	1999892.34	6456450.77	95.17	MF	PK	2"	
1830	1999895.17	6456450.75	95.14	MF	PK	2"	
1831	1998692.81	6459454.84	96.01	MF	IP	3"	
1832	1998692.98	6459379.89	96.29	MF	IP	3/4"	
1833	1998678.06	6459364.75	95.75	MF	IP	3/4"	
1834	1998623.08	6459364.45	95.28		IP	3/4"	
1835	1998006.95	6459301.27	96.94		IP	3/4"	
1836	1997992.14	6459286.26	96.26		IP	3/4"	
1837	1998006.98	6459361.34	96.74		IP _	3/4"	
1838	1997991.81	6459376.37	96.35		IP	3/4"	
1839	1997941.58	6459377.49	96.50		IP	3/4"	
1840	1997926.67	6459361.78	96.90		IP	3/4"	
1841	1997757.39	6459304.65	96.50		IP	3/4"	
1842	1997742.06	6459289.63	96.36		IP ID	3/4"	
1843	1997691.47	6459289.99	95.95		IP IP	3/4"	
1845	1997691.88 1997741.86	6459380.12 6459379.64	96.37 96.59		IP	3/4"	
1846	1997756.61	6459364.72	96.59		IP	3/4"	
1847	1997473.85	6459377.82	96.57		IP	3/4"	
1848	1997474.46	6459288.98	96.03		IP	3/4"	
2001	1999480.09	6460465.57	96.89		<u> </u>	,	
2002	1999497.34	6456308.61	95.11				IN MON WELL
2603	2004921.49	6464890.35	106.03		IP	3/4"	CONTROL
2829	2002132.26	6457453.50	97.22	MF	СС	2"	
2401	1999870.67	6456513.76	95.11	MS	СС	2"	
2402	1999863.02	6458018.13	95.51	MS	СС	2"	
2403	1999973.35	6459938.73	96.87	MS	PK	2"	
2404	2000000.68	6459820.79	96.98	MS	CC	2"	
2405	2000001.24	6459482.60	97.54	MS	CC	2"	
2410	1999861.09	6458667.59	97.09	MS	СС	2"	
2411	1999916.55	6457760.71	95.01	MS	SM	1"	
2412	1999880.95	6457228.79	94.17	MS	PK	3/4"	
2413	1999872.62	6457659.63	94.82	MS	PK		
2821	1999414.44	6460358.08	96.35	MS	СС	2"	IN MON WELL
2822	1999415.15	6459314.56	97.60	MS	СС	2"	IN MON WELL
2823	1999440.30	6457818.27	94.65	MS	CC	2"	IN MON WELL
2833	1999468.58	6459767.25	98.41	MS	CC	2"	IN MON WELL
2834	2000004.79	6459321.39	97.48	MS	CC	2"	IN MON WELL
2835	1999393.37	6459085.29	97.18	MS	CC	2"	
2836	1998690.03	6459368.63	96.46	MS	CC	2"	
2837	1998838.82	6459357.91	96.43		CC	2"	
2838	1998742.26	6459794.16	97.20	MS	CC	2"	

2839	1998007.43	6459306.16	97.13	MS	CC	2"	
2840	1998273.94	6459312.35	96.62	MS	CC	2"	
2841	1999945.44	6460374.03	96.02	MS	CC	2"	
2842	1999907.97	6459054.13	97.31	MS	CC	2"	
2843	1999972.12	6459078.73	97.92	MS	CC	2"	
2844	1997643.78	6459361.29	97.15	MS	CC	2"	
2901	1999913.17	6456470.66	94.87	MF	PK		
2902	1997694.22	6459334.78	97.18	MF	PK		
				•	•		•

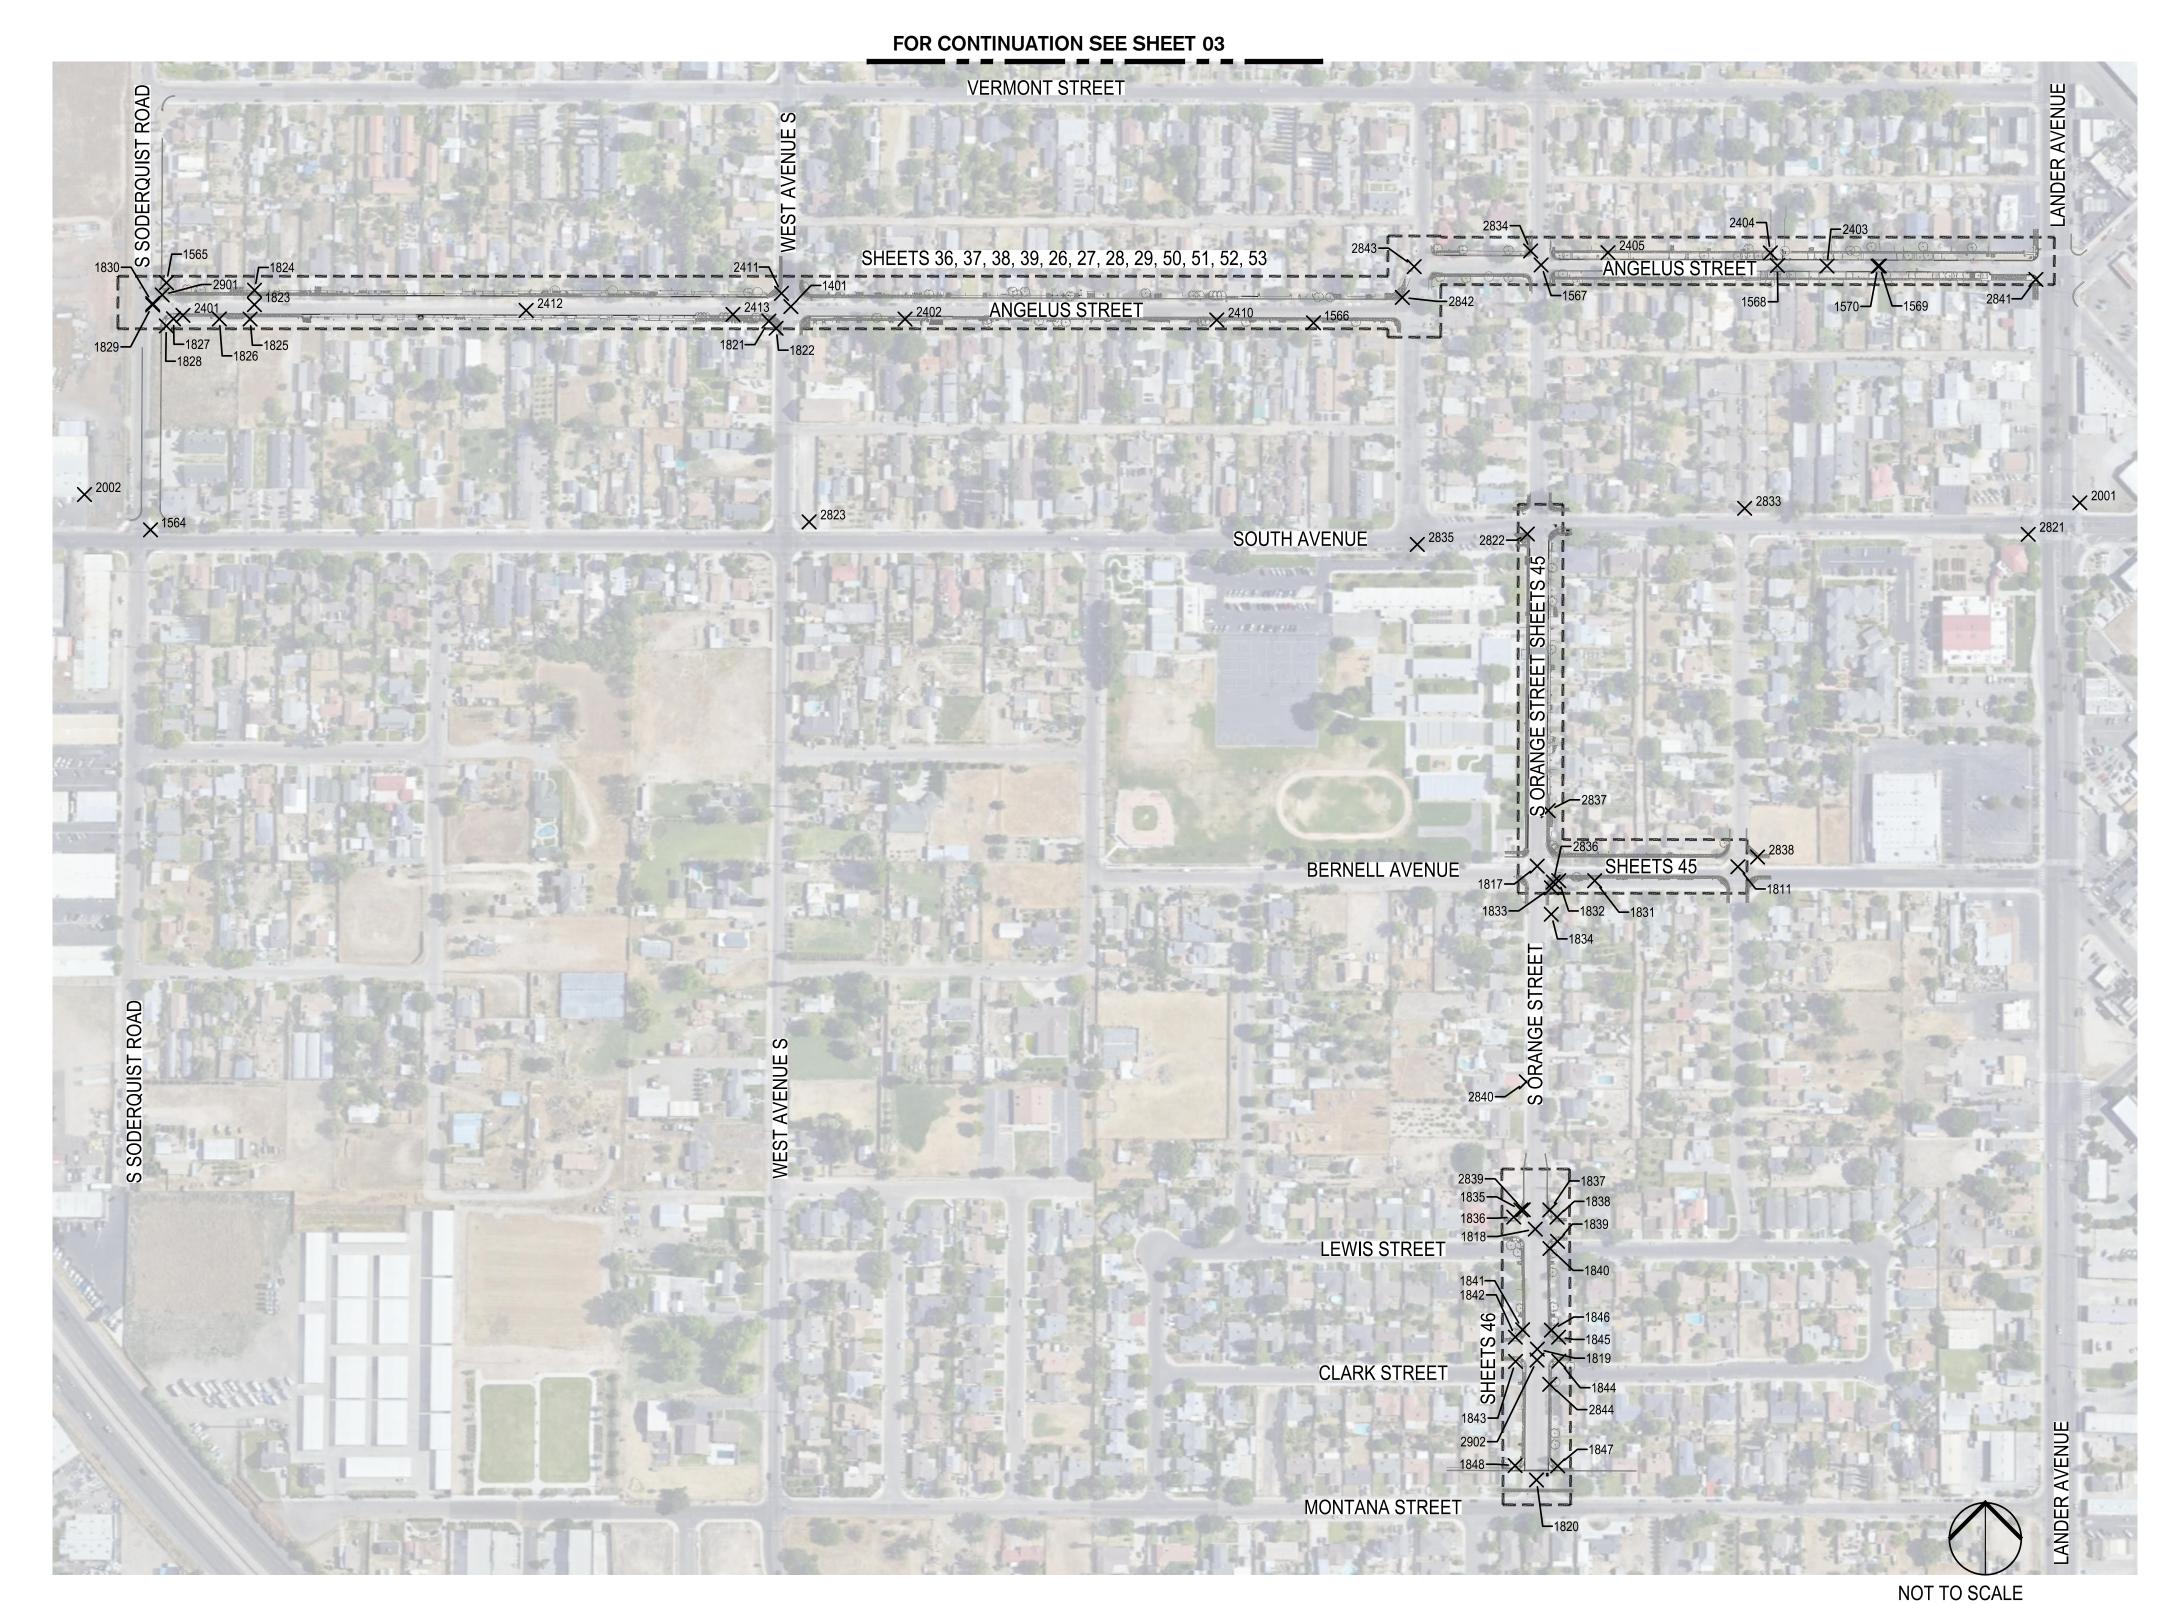




ALL REFERENCES AND WRITTEN DIMENSIONS SHALL SUPERCEDE ALL SCALED DISTANCES AND SHALL BE VERIFIED IN THE FIELD. ANY DISCREPANCY
SHALL BE BROUGHT TO THE
ATTENTION OF THE ENGINEER
PRIOR TO THE COMMENCEMENT
OF WORK

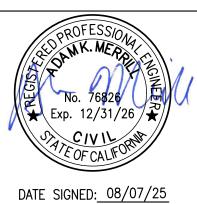



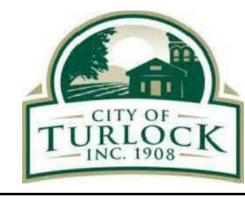

CITY OF TURLOCK
MUNICIPAL SERVICES DEPARTMENT
156 S. BROADWAY,
SUITE 150 (209) 668-5520

KEVMAD & CLIDVEY CONTDOL DOINTS DLAN II


VERIFY SCALE	DRAWN BY: JR	DRAWING NO.
0 1"	REV. BY: AKM	
	CH. BY: AKM	14
	DATE: 8/7/2025	
	SCALE: SEE SHEET	SHFFT:
	SEI PROJ NO: 22157	14 OF 117


14 OF 117

KEYWAP	& SURVEY	CONTROL	POINTS PLAN II	

PROJECT NO. 23-069

CITY OF TURLOCK ROADS PROGRAM

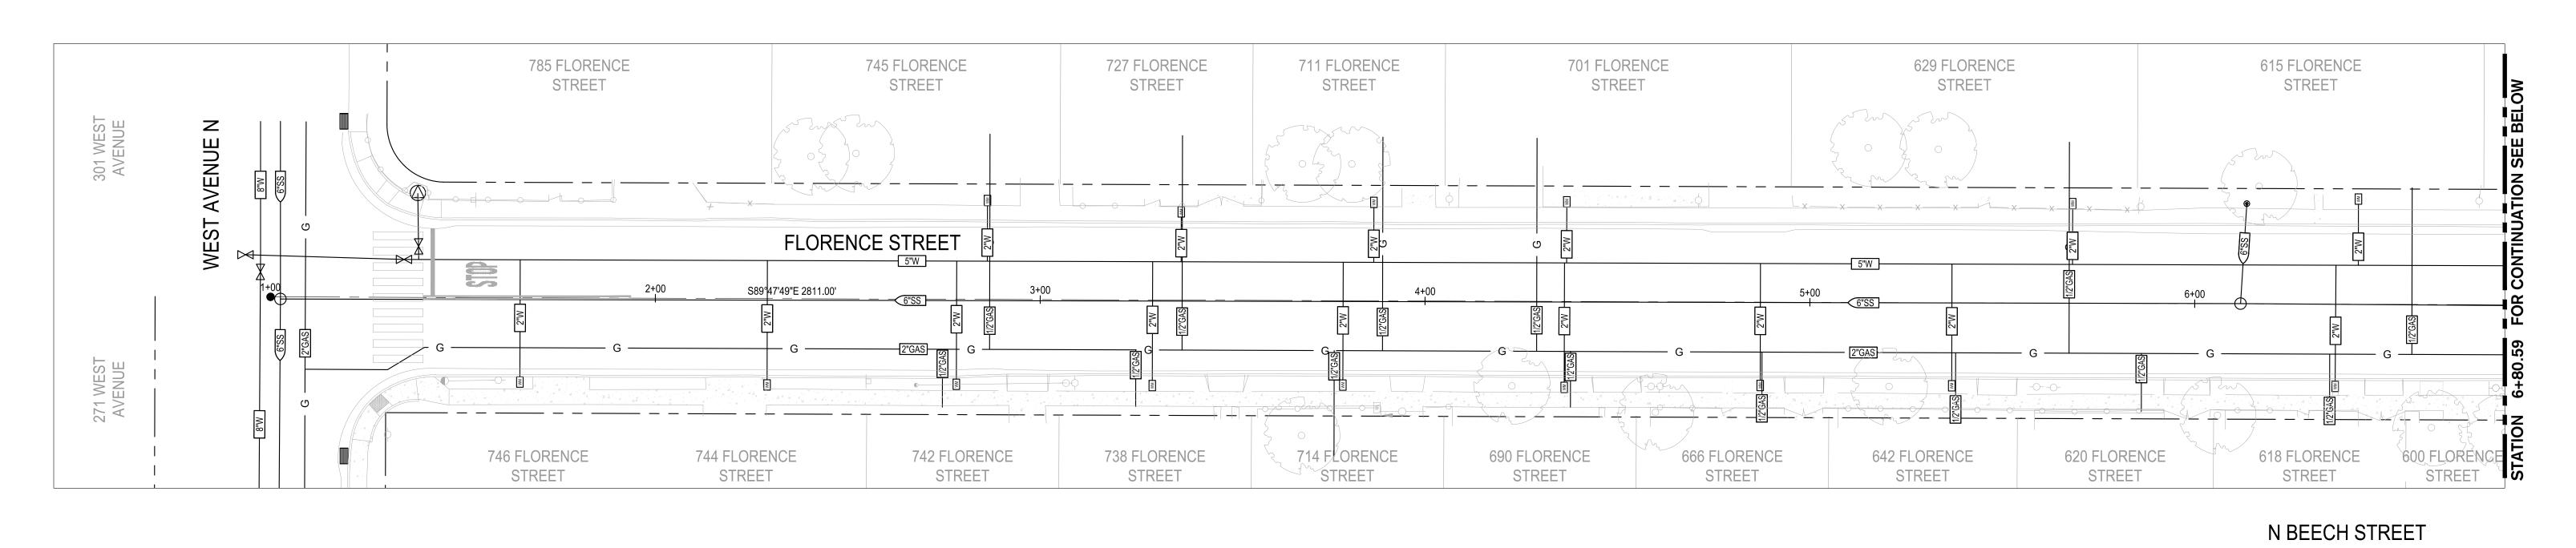


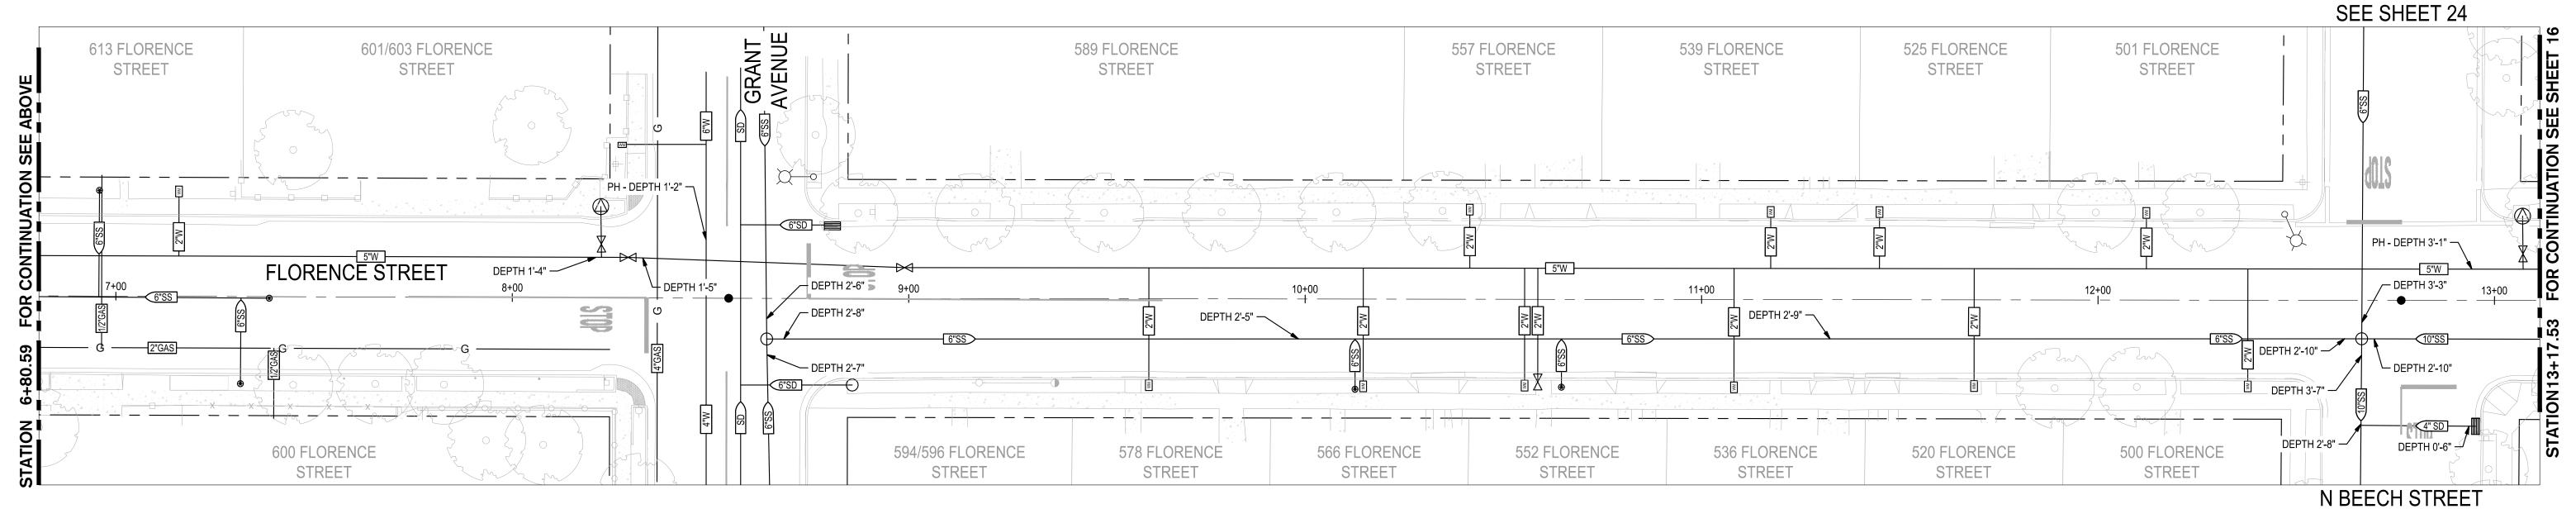

NOTES:

1. EXISTING UTILITIES ARE SHOWN AS THEY ARE BELIEVED TO EXIST. THE OWNER AND THE ENGINEER DO NOT ACCEPT RESPONSIBILITY FOR THEIR ACCURACY. PRIOR TO COMMENCING ANY WORK, THE CONTRACTOR SHALL HAVE EACH UTILITY COMPANY ACCURATELY LOCATE IN THE FIELD THEIR MAINS AND SERVICE LINES. IT SHALL BE THE CONTRACTOR'S RESPONSIBILITY TO PROTECT ALL EXISTING UTILITIES. THE CONTRACTOR SHALL NOTIFY MEMBERS OF THE UNDERGROUND SERVICE ALERT (U.S.A.) 48 HOURS IN ADVANCE OF PERFORMING EXCAVATION WORK BY CALLING THE TOLL-FREE NUMBER (800-227-2600).


- 2. THE CONTRACTOR SHALL BE RESPONSIBLE FOR COORDINATION OF THE REMOVAL OR RELOCATION OF ALL EXISTING UTILITIES WITH RESPECTIVE UTILITY COMPANIES.
- 3. FOR CLARITY, OVERHEAD UTILITIES ARE NOT SHOWN ON EXISTING UTILITIES SHEETS. OVERHEAD UTILITY INFORMATION CAN BE FOUND ON IMPROVEMENT PLANS.
- 4. DEPTHS SHOWN WERE OBTAINED WITH POTHOLE REPORTING OR MANHOLE DIPS AND ARE PROVIDED AS GENERAL REFERENCE. POTHOLE DEPTHS PROVIDED AT APPROXIMATE LOCATION. MANHOLE DIPS USED TO EXTRAPOLATE PIPELINE DEPTHS WERE APPLICABLE. **DEPTHS GIVEN** SHALL NOT BE USED FOR CONSTRUCTION REFERENCE.

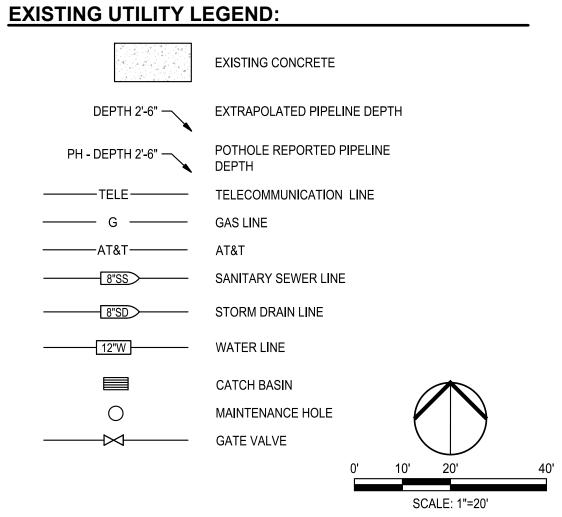


SEE SHEET 24



ALL REFERENCES AND WRITTEN DIMENSIONS SHALL SUPERCEDE ALL SCALED DISTANCES AND SHALL BE VERIFIED IN THE FIELD. ANY DISCREPANCY SHALL BE BROUGHT TO THE ATTENTION OF THE ENGINEER PRIOR TO THE COMMENCEMENT OF WORK

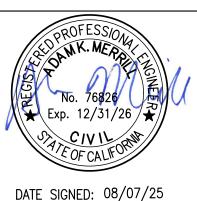




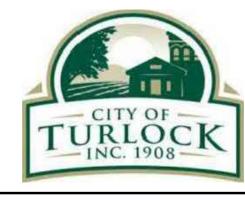

CITY OF TURLOCK MUNICIPAL SERVICES DEPARTMENT 156 S. BROADWAY, SUITE 150 (209) 668 - 5520


EXISTING UTILITIES - FLORENCE STREET I

VERIFY SCALE	DRAWN BY: JR	drawing no.
0 1"	REV. BY: AKM	
	CH. BY: AKM	15
	DATE: 8/7/2025	
	SCALE: SEE SHEET	SHEET:
	SEI PROJ NO: 22157	15 OF 117
		•

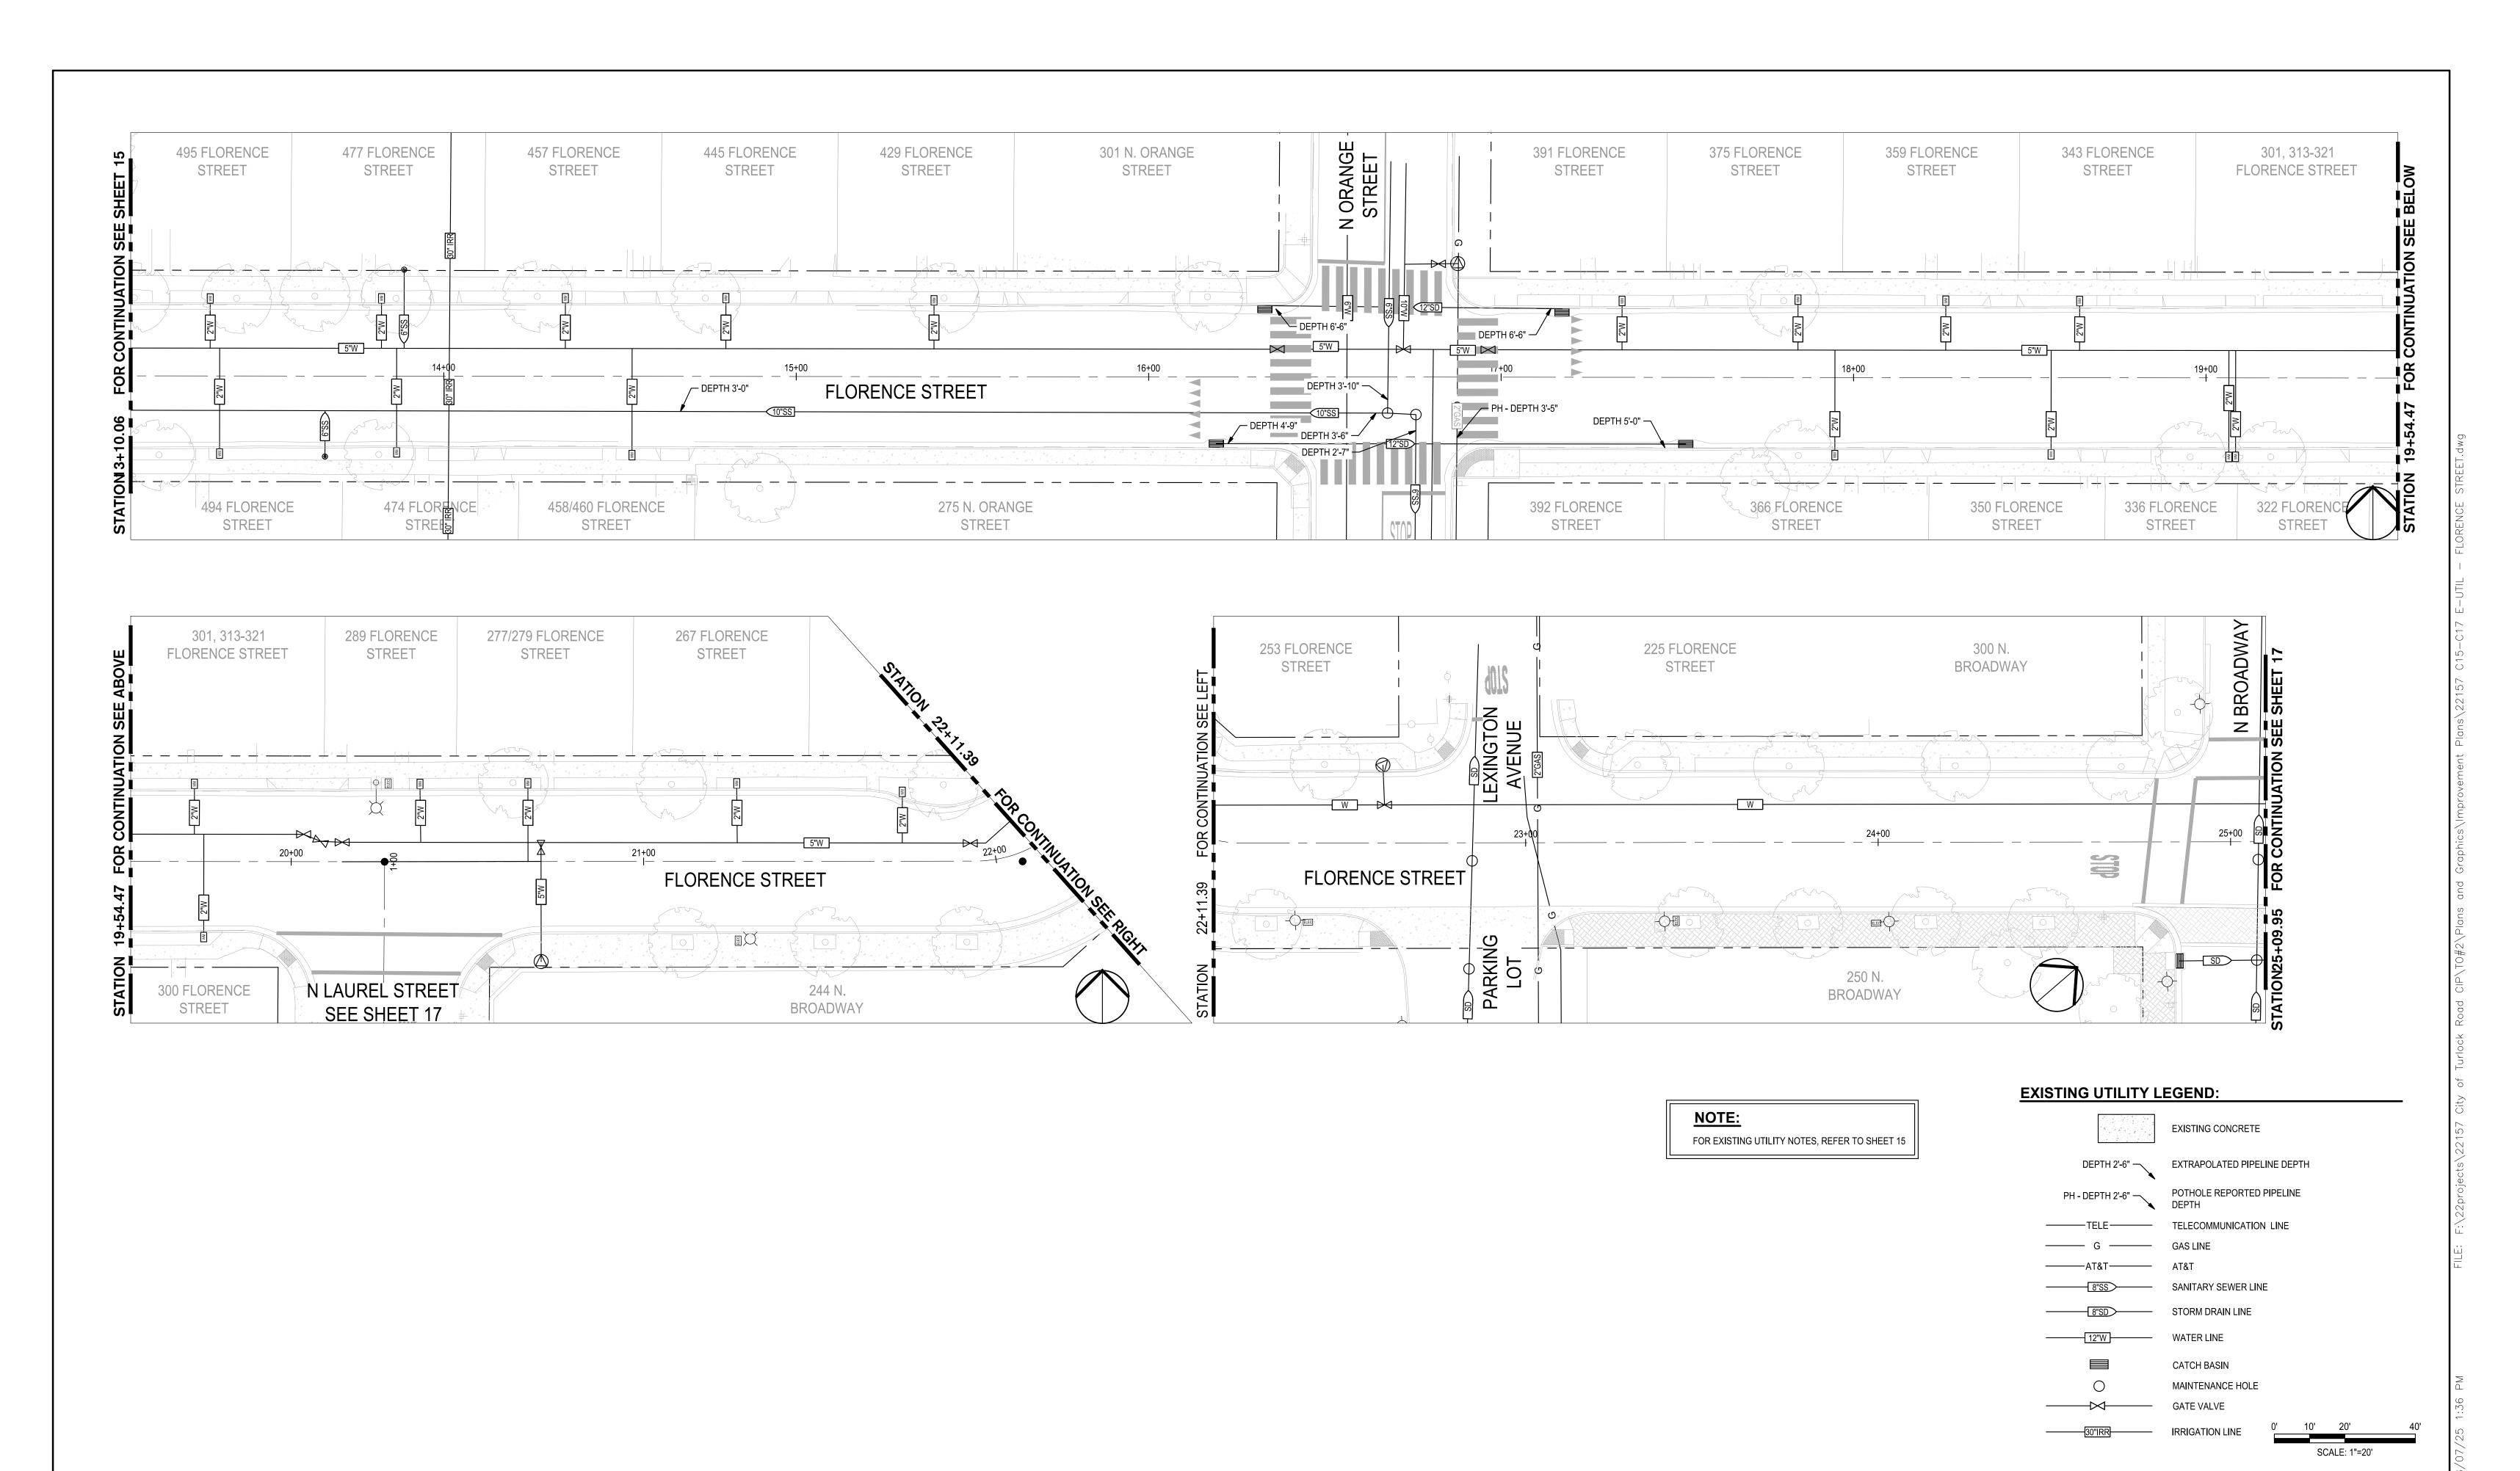




NOTE:
ALL REFERENCES AND WRITTEN
DIMENSIONS SHALL SUPERCEDE
ALL SCALED DISTANCES AND
SHALL BE VERIFIED IN THE
FIELD. ANY DISCREPANCY
SHALL BE BROUGHT TO THE
ATTENTION OF THE ENGINEER
PRIOR TO THE COMMENCEMENT
OF WORK

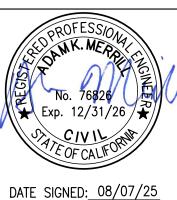



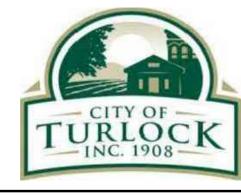



CITY OF TURLOCK
MUNICIPAL SERVICES DEPARTMENT
156 S. BROADWAY,
SUITE 150
(209) 668-5520

EXISTING UTILITIES - FLORENCE STREET II
PROJECT NO. 23-069


CITY OF TURLOCK ROADS PROGRAM

ERIFY SCALE	DRAWN BY: JR	drawing no.
1 "	REV. BY: AKM	
	CH. BY: AKM	16
	DATE: 8/7/2025	10
	SCALE: SEE SHEET	SHEET:
	SEI PROJ NO: 22157	16 OF 117

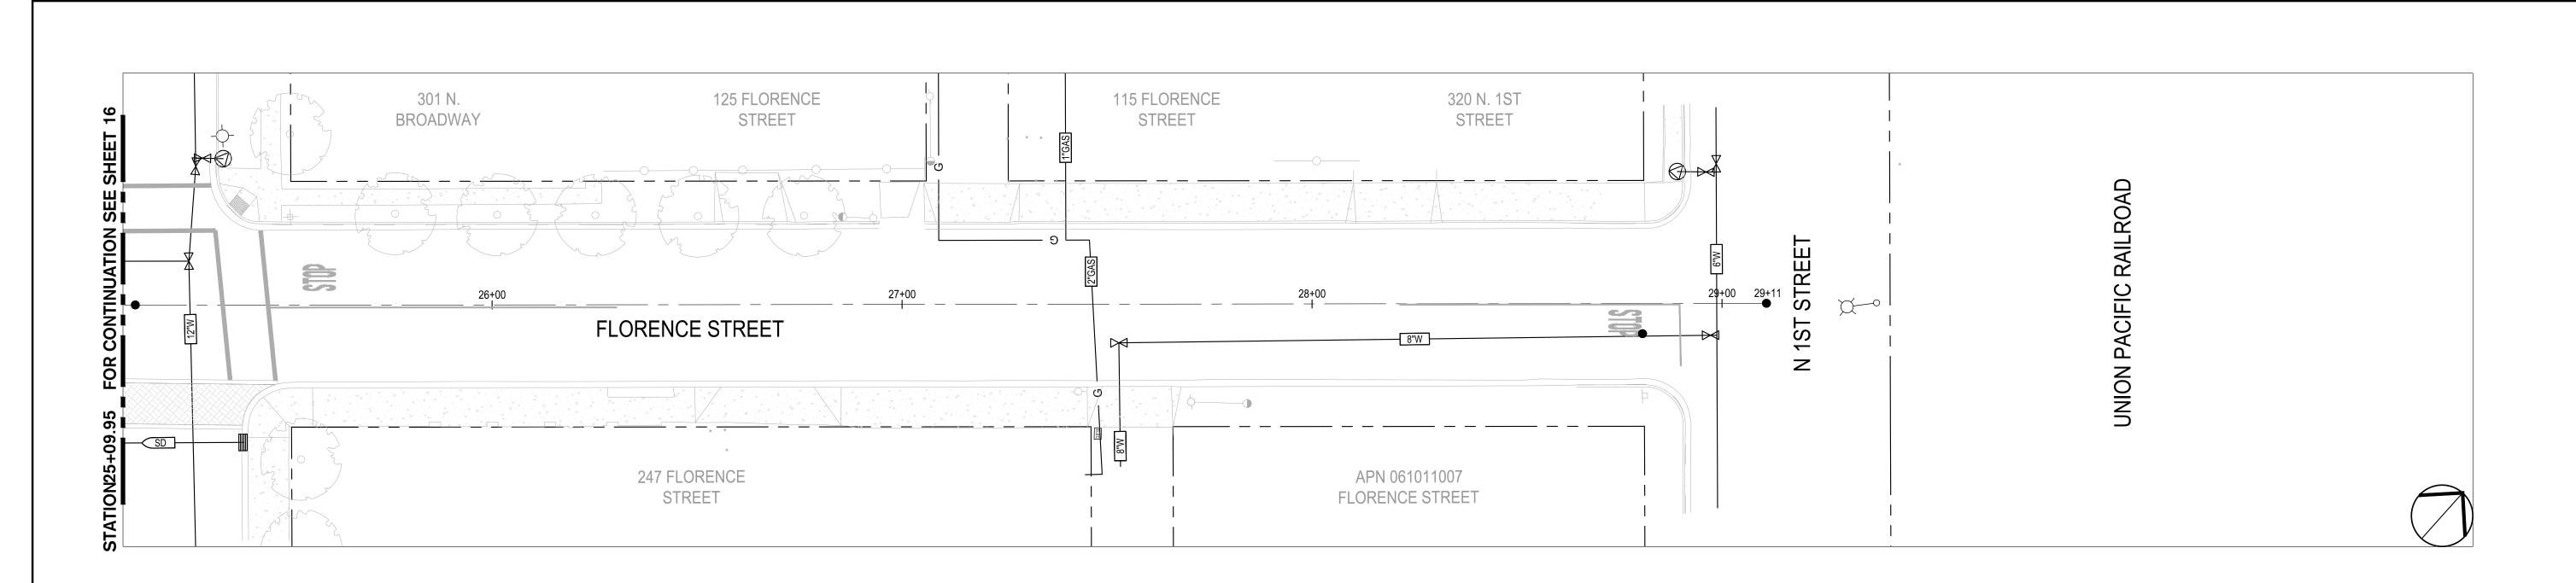

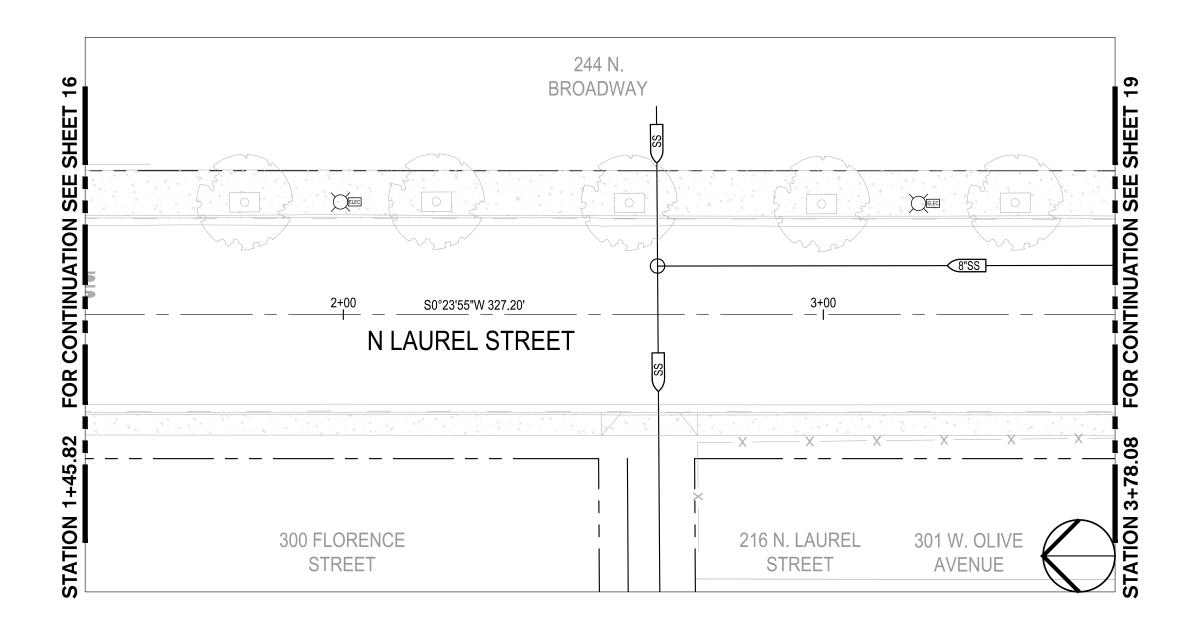


NOTE:
FOR EXISTING UTILITY NOTES, REFER TO SHEET 15

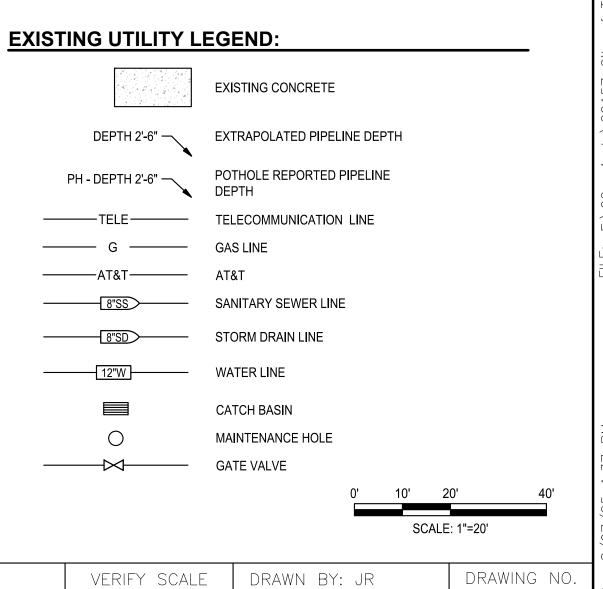



NOTE:
ALL REFERENCES AND WRITTEN
DIMENSIONS SHALL SUPERCEDE
ALL SCALED DISTANCES AND
SHALL BE VERIFIED IN THE
FIELD. ANY DISCREPANCY
SHALL BE BROUGHT TO THE
ATTENTION OF THE ENGINEER
PRIOR TO THE COMMENCEMENT
OF WORK

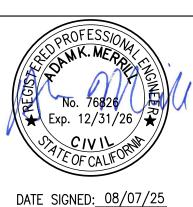








CITY OF TURLOCK MUNICIPAL SERVICES DEPARTMENT 156 S. BROADWAY, SUITE 150 (209) 668-5520

RIFY SCALE	DRAWN BY: JR	DRAWING NO.
1 "	REV. BY: AKM	
	CH. BY: AKM	17
	DATE: 8/7/2025	1 /
	SCALE: SEE SHEET	SHEET:
	SEI PROJ NO: 22157	17 OF 117

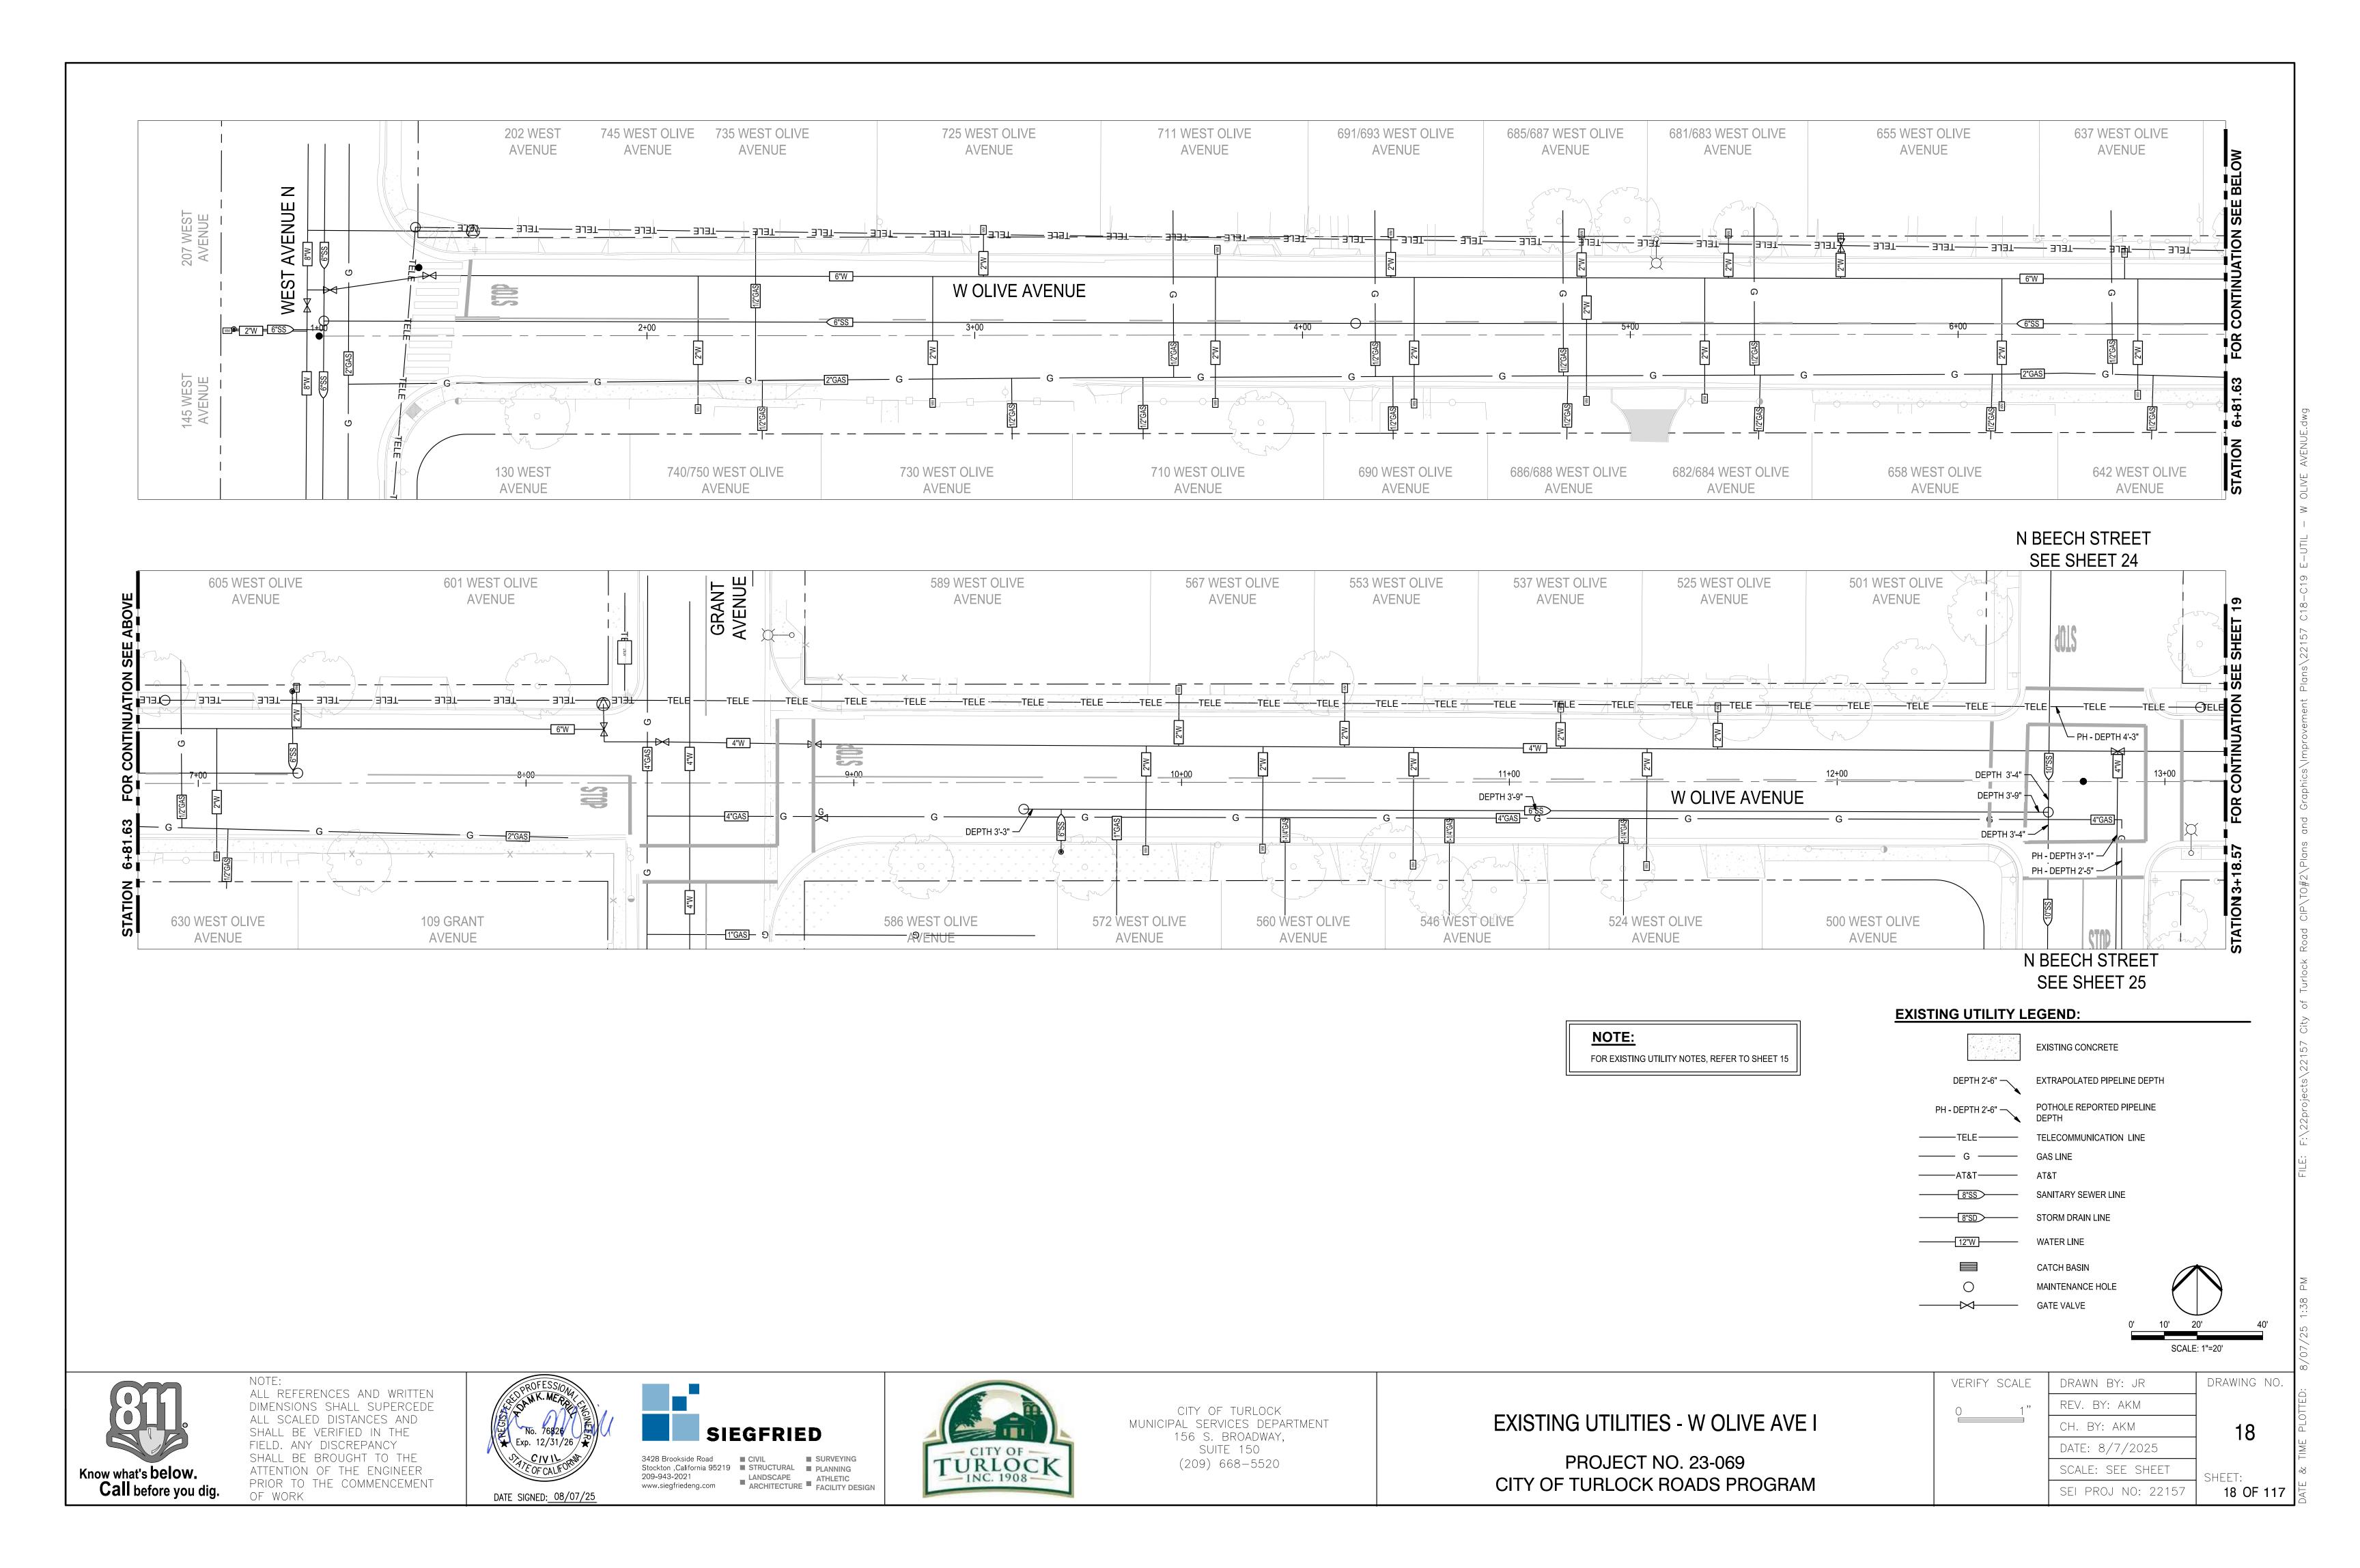


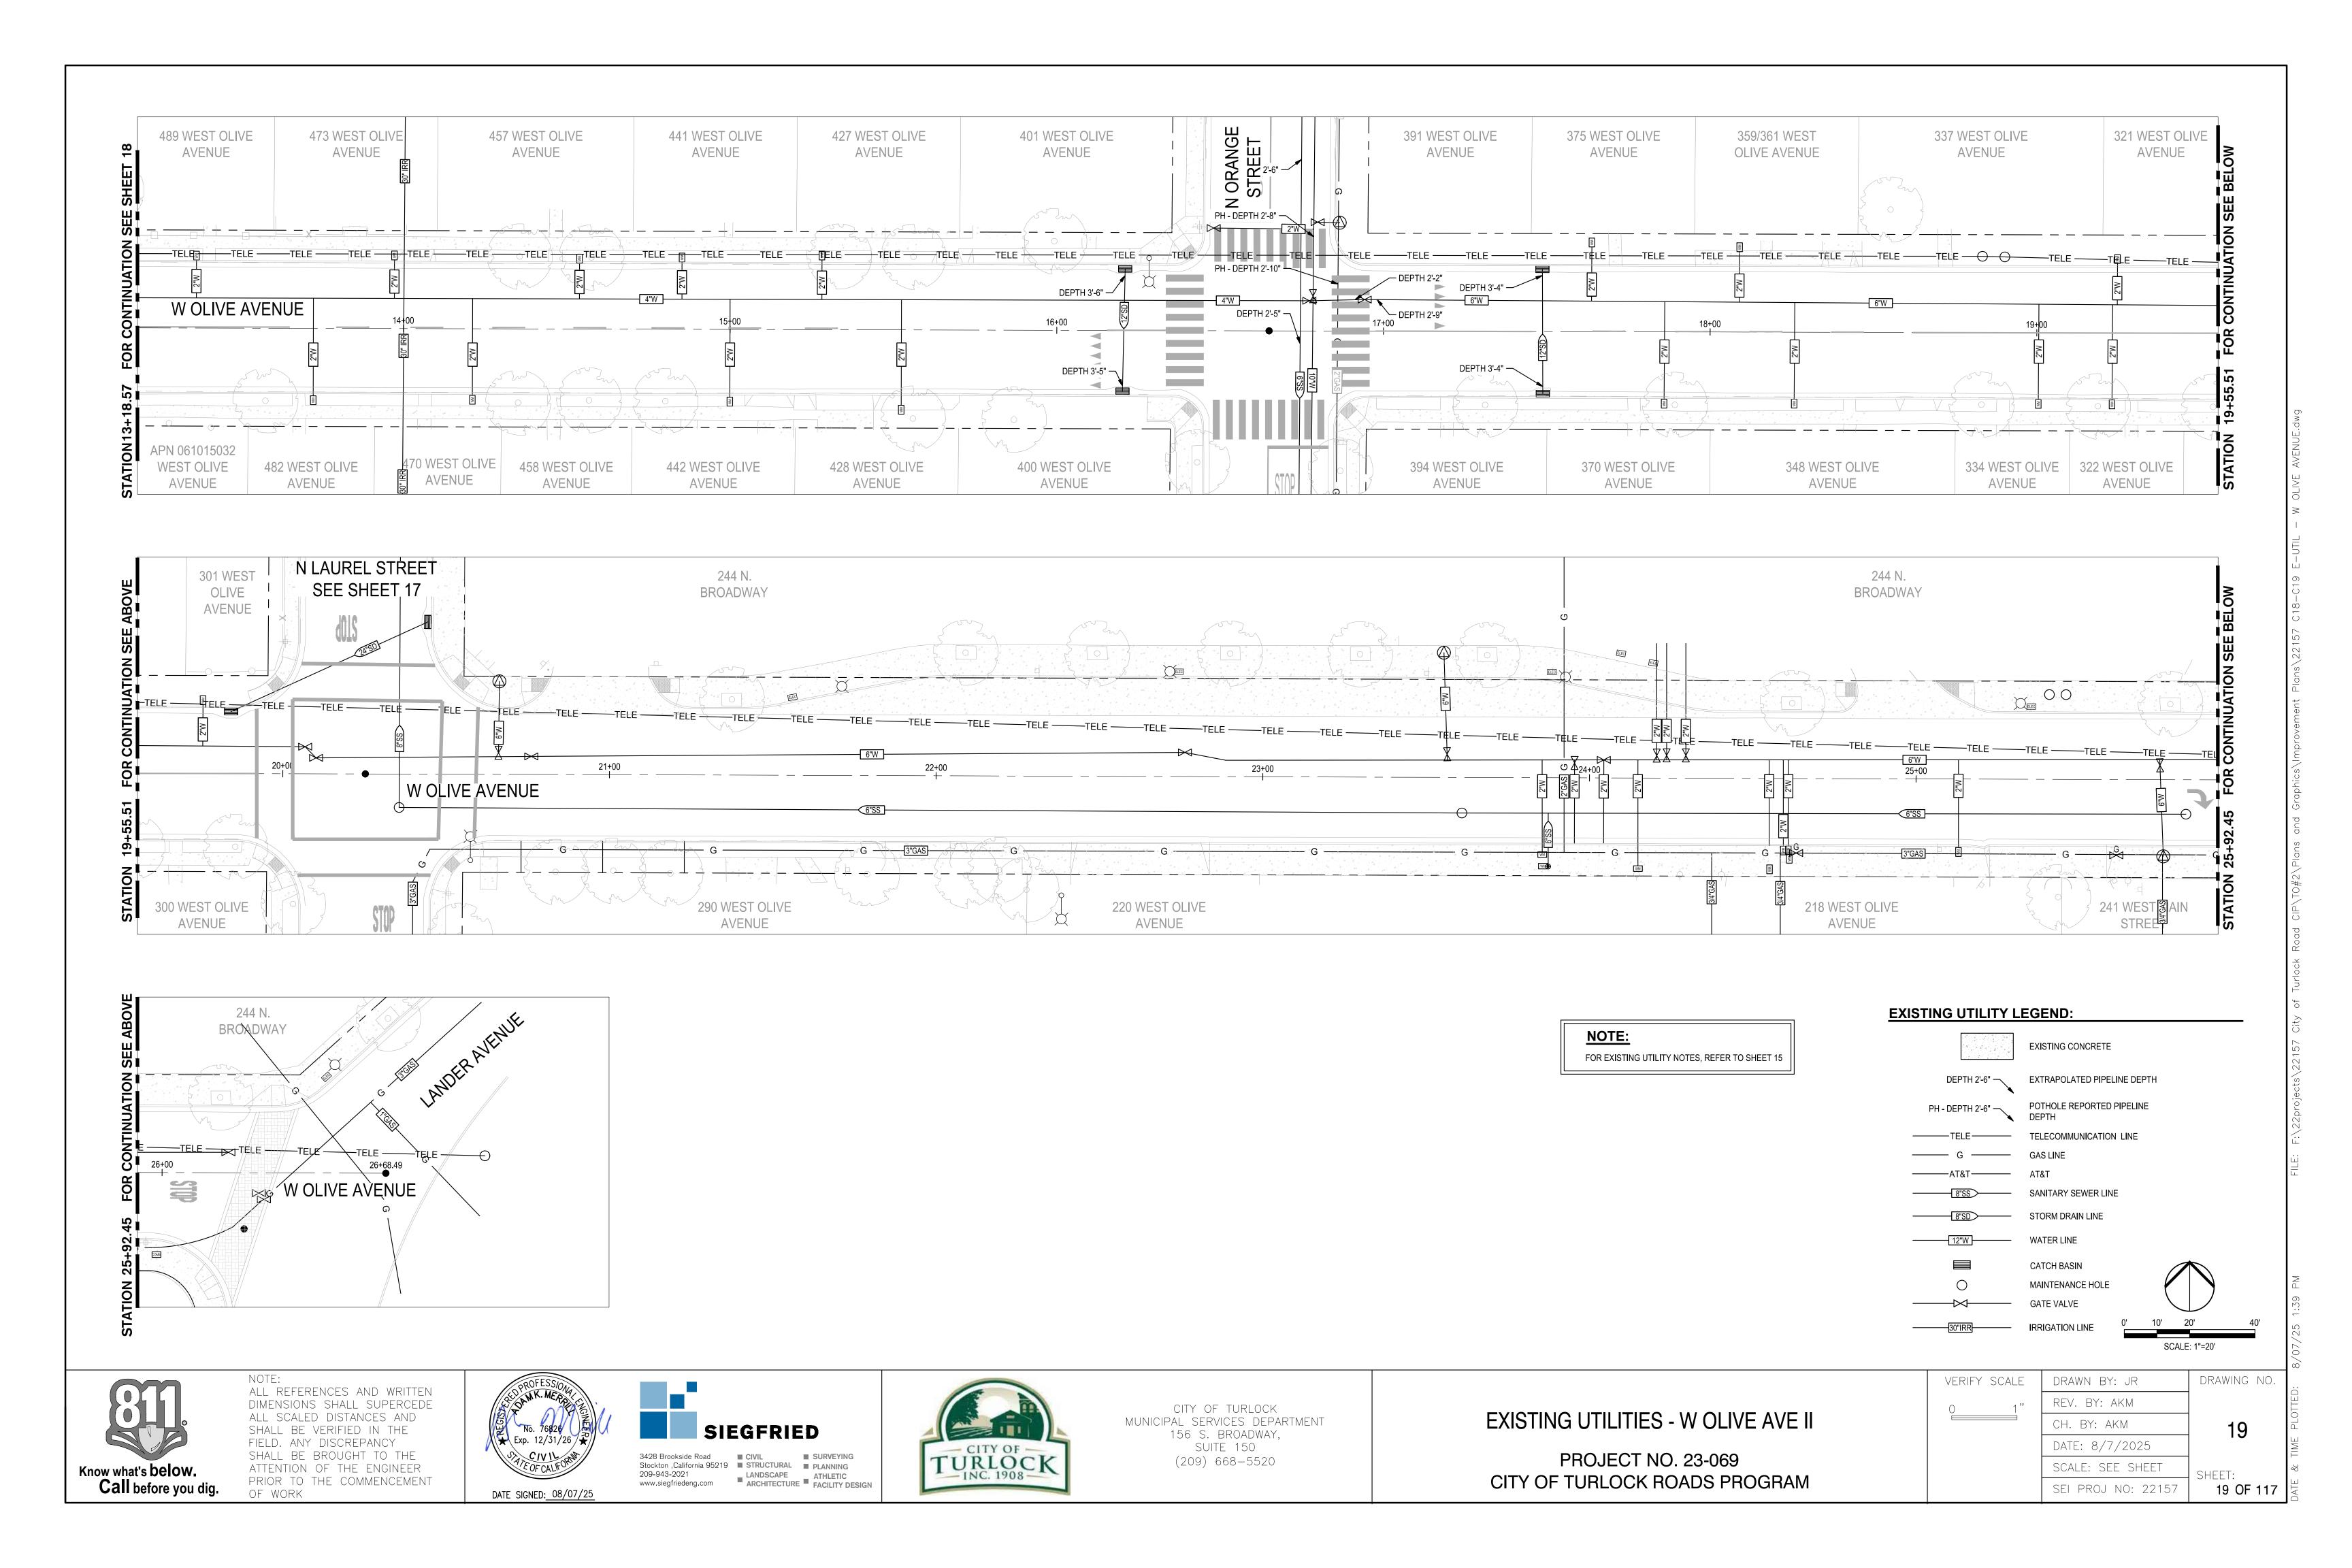

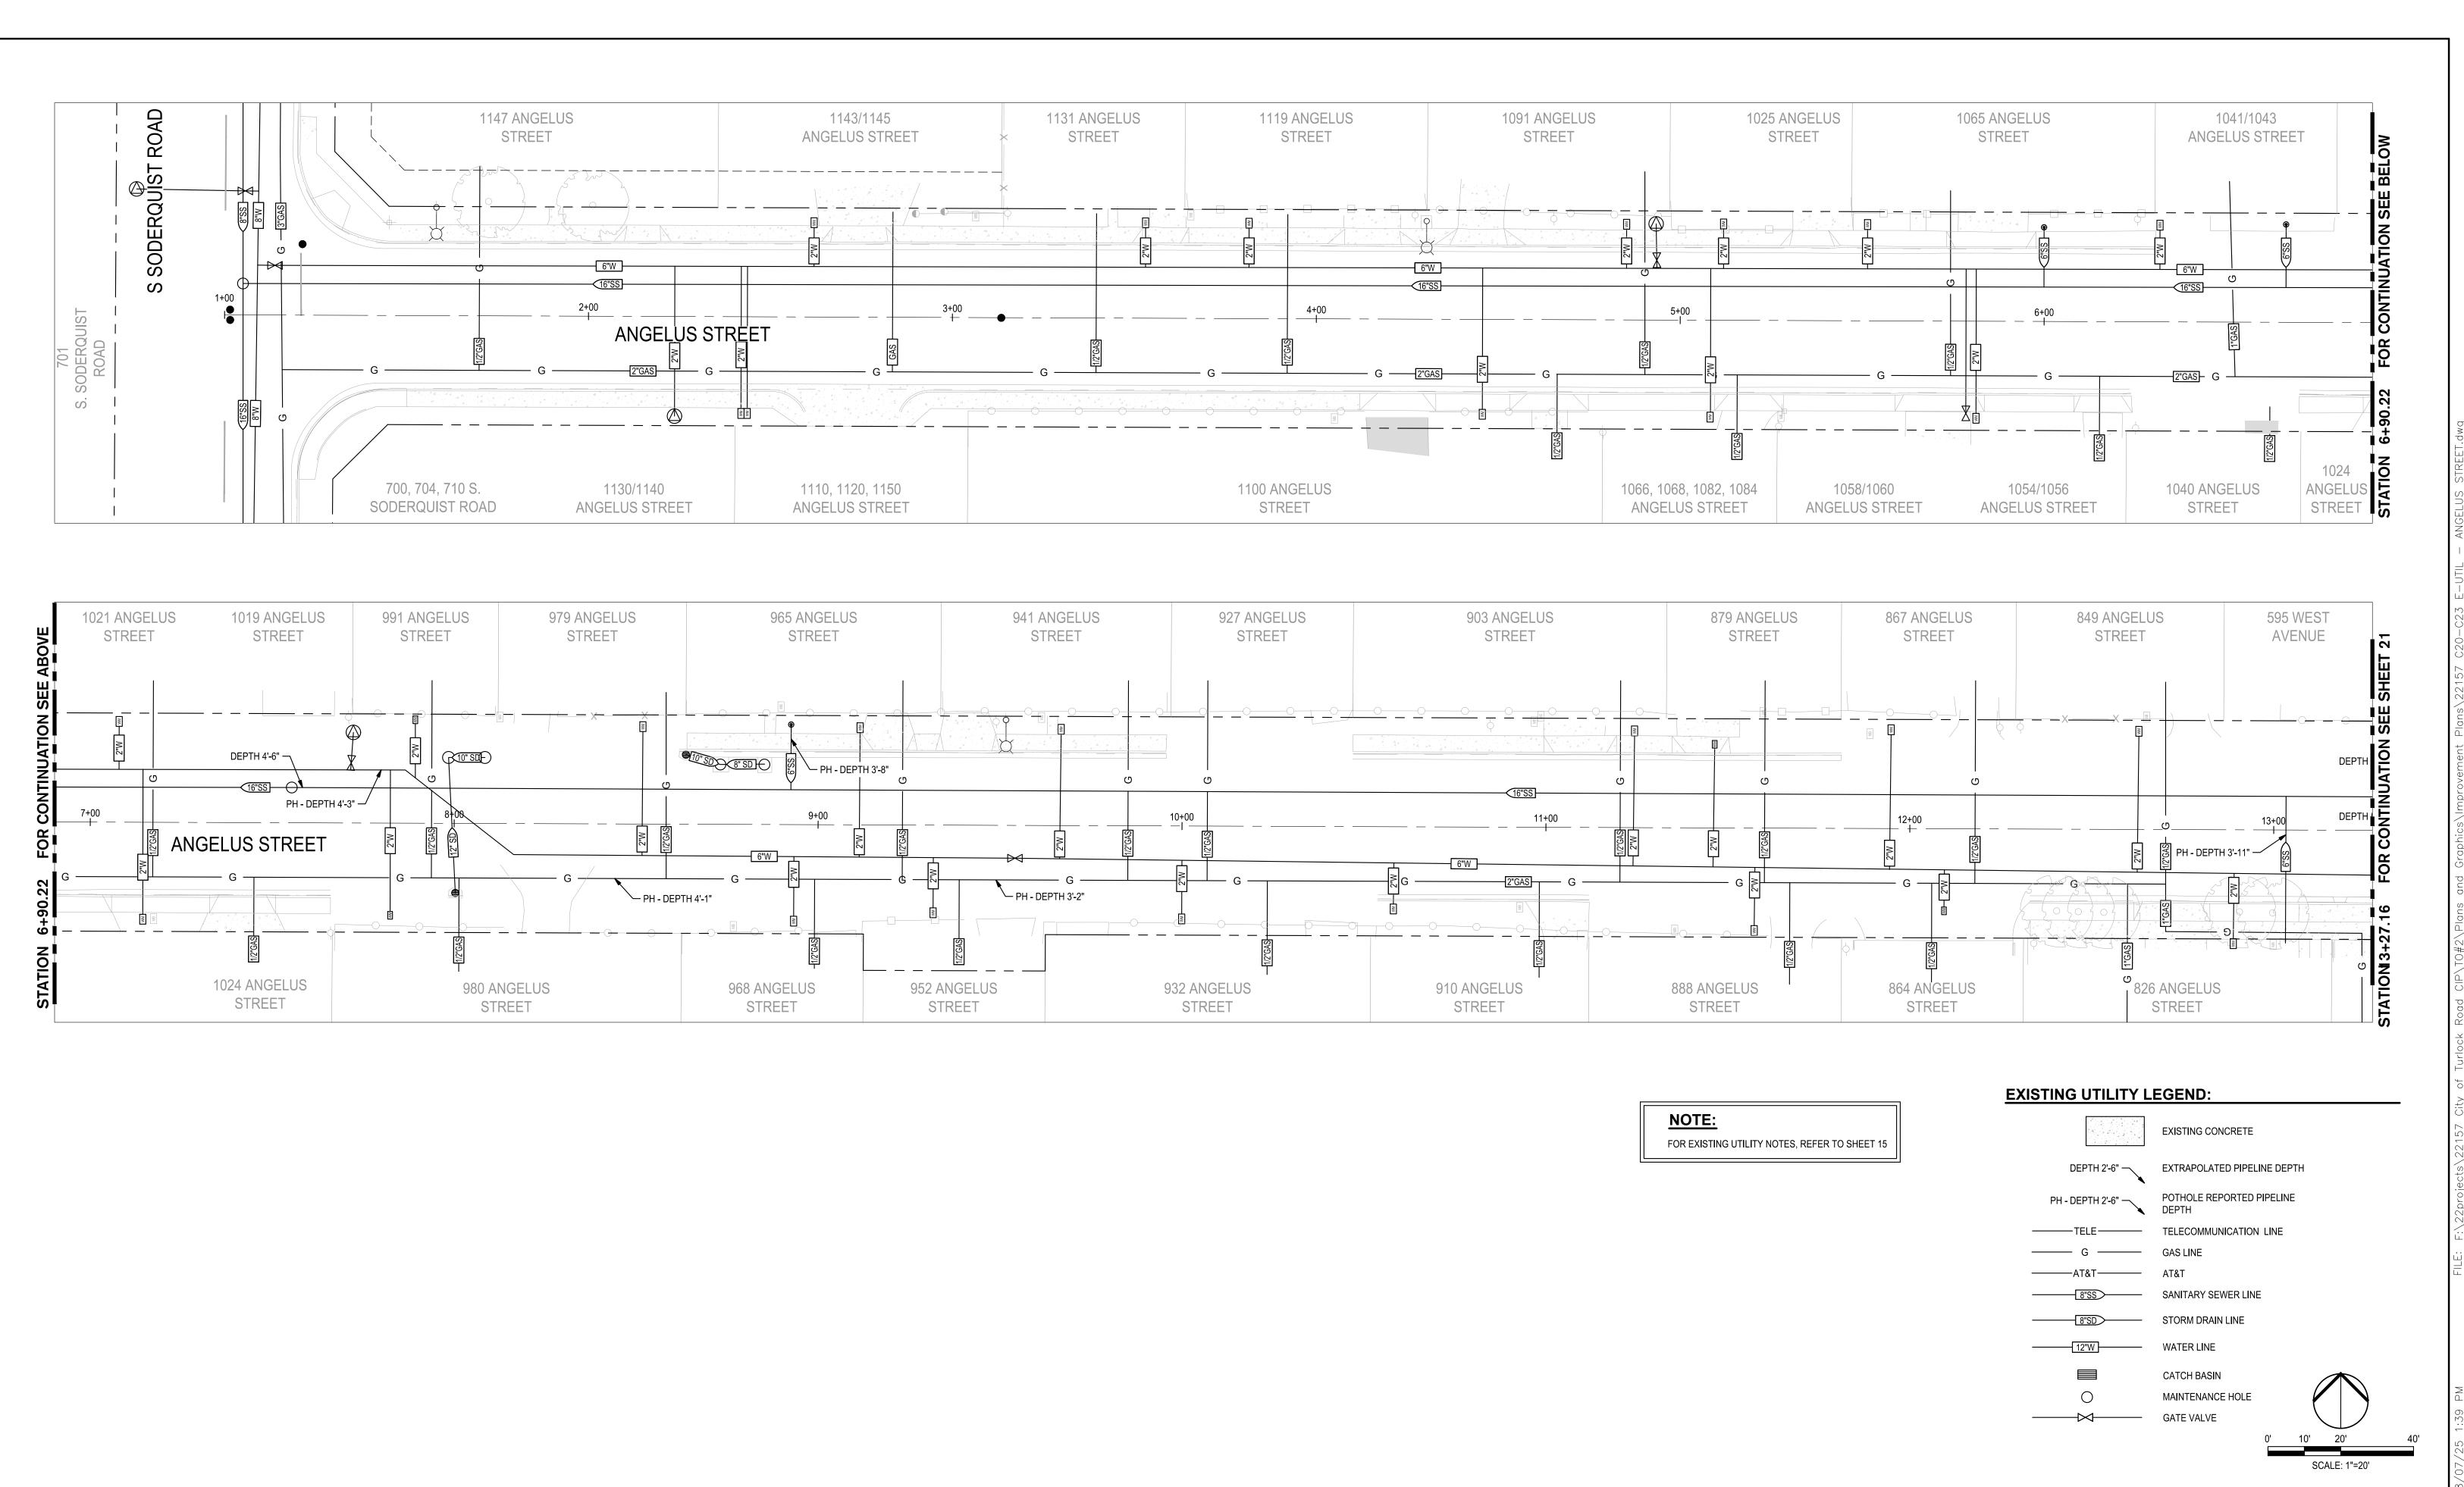


Know what's below. Call before you dig.

ALL REFERENCES AND WRITTEN DIMENSIONS SHALL SUPERCEDE ALL SCALED DISTANCES AND SHALL BE VERIFIED IN THE FIELD. ANY DISCREPANCY SHALL BE BROUGHT TO THE ATTENTION OF THE ENGINEER PRIOR TO THE COMMENCEMENT OF WORK

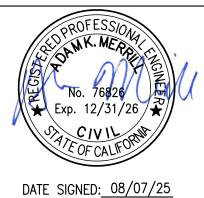



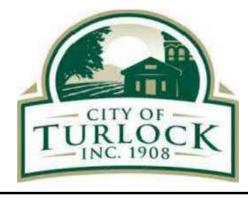



CITY OF TURLOCK MUNICIPAL SERVICES DEPARTMENT 156 S. BROADWAY, SUITE 150 (209) 668 - 5520


EXISTING UTILITIES - ANGELUS STREET I


DRAWING 1	DRAWN BY: JR	verify scale
	REV. BY: AKM	0 1"
20	CH. BY: AKM	
	DATE: 8/7/2025	
SHFFT:	SCALE: SEE SHEET	
20 OF 1	SEI PROJ NO: 22157	

PROJECT NO. 23-069 CITY OF TURLOCK ROADS PROGRAM NO. 117

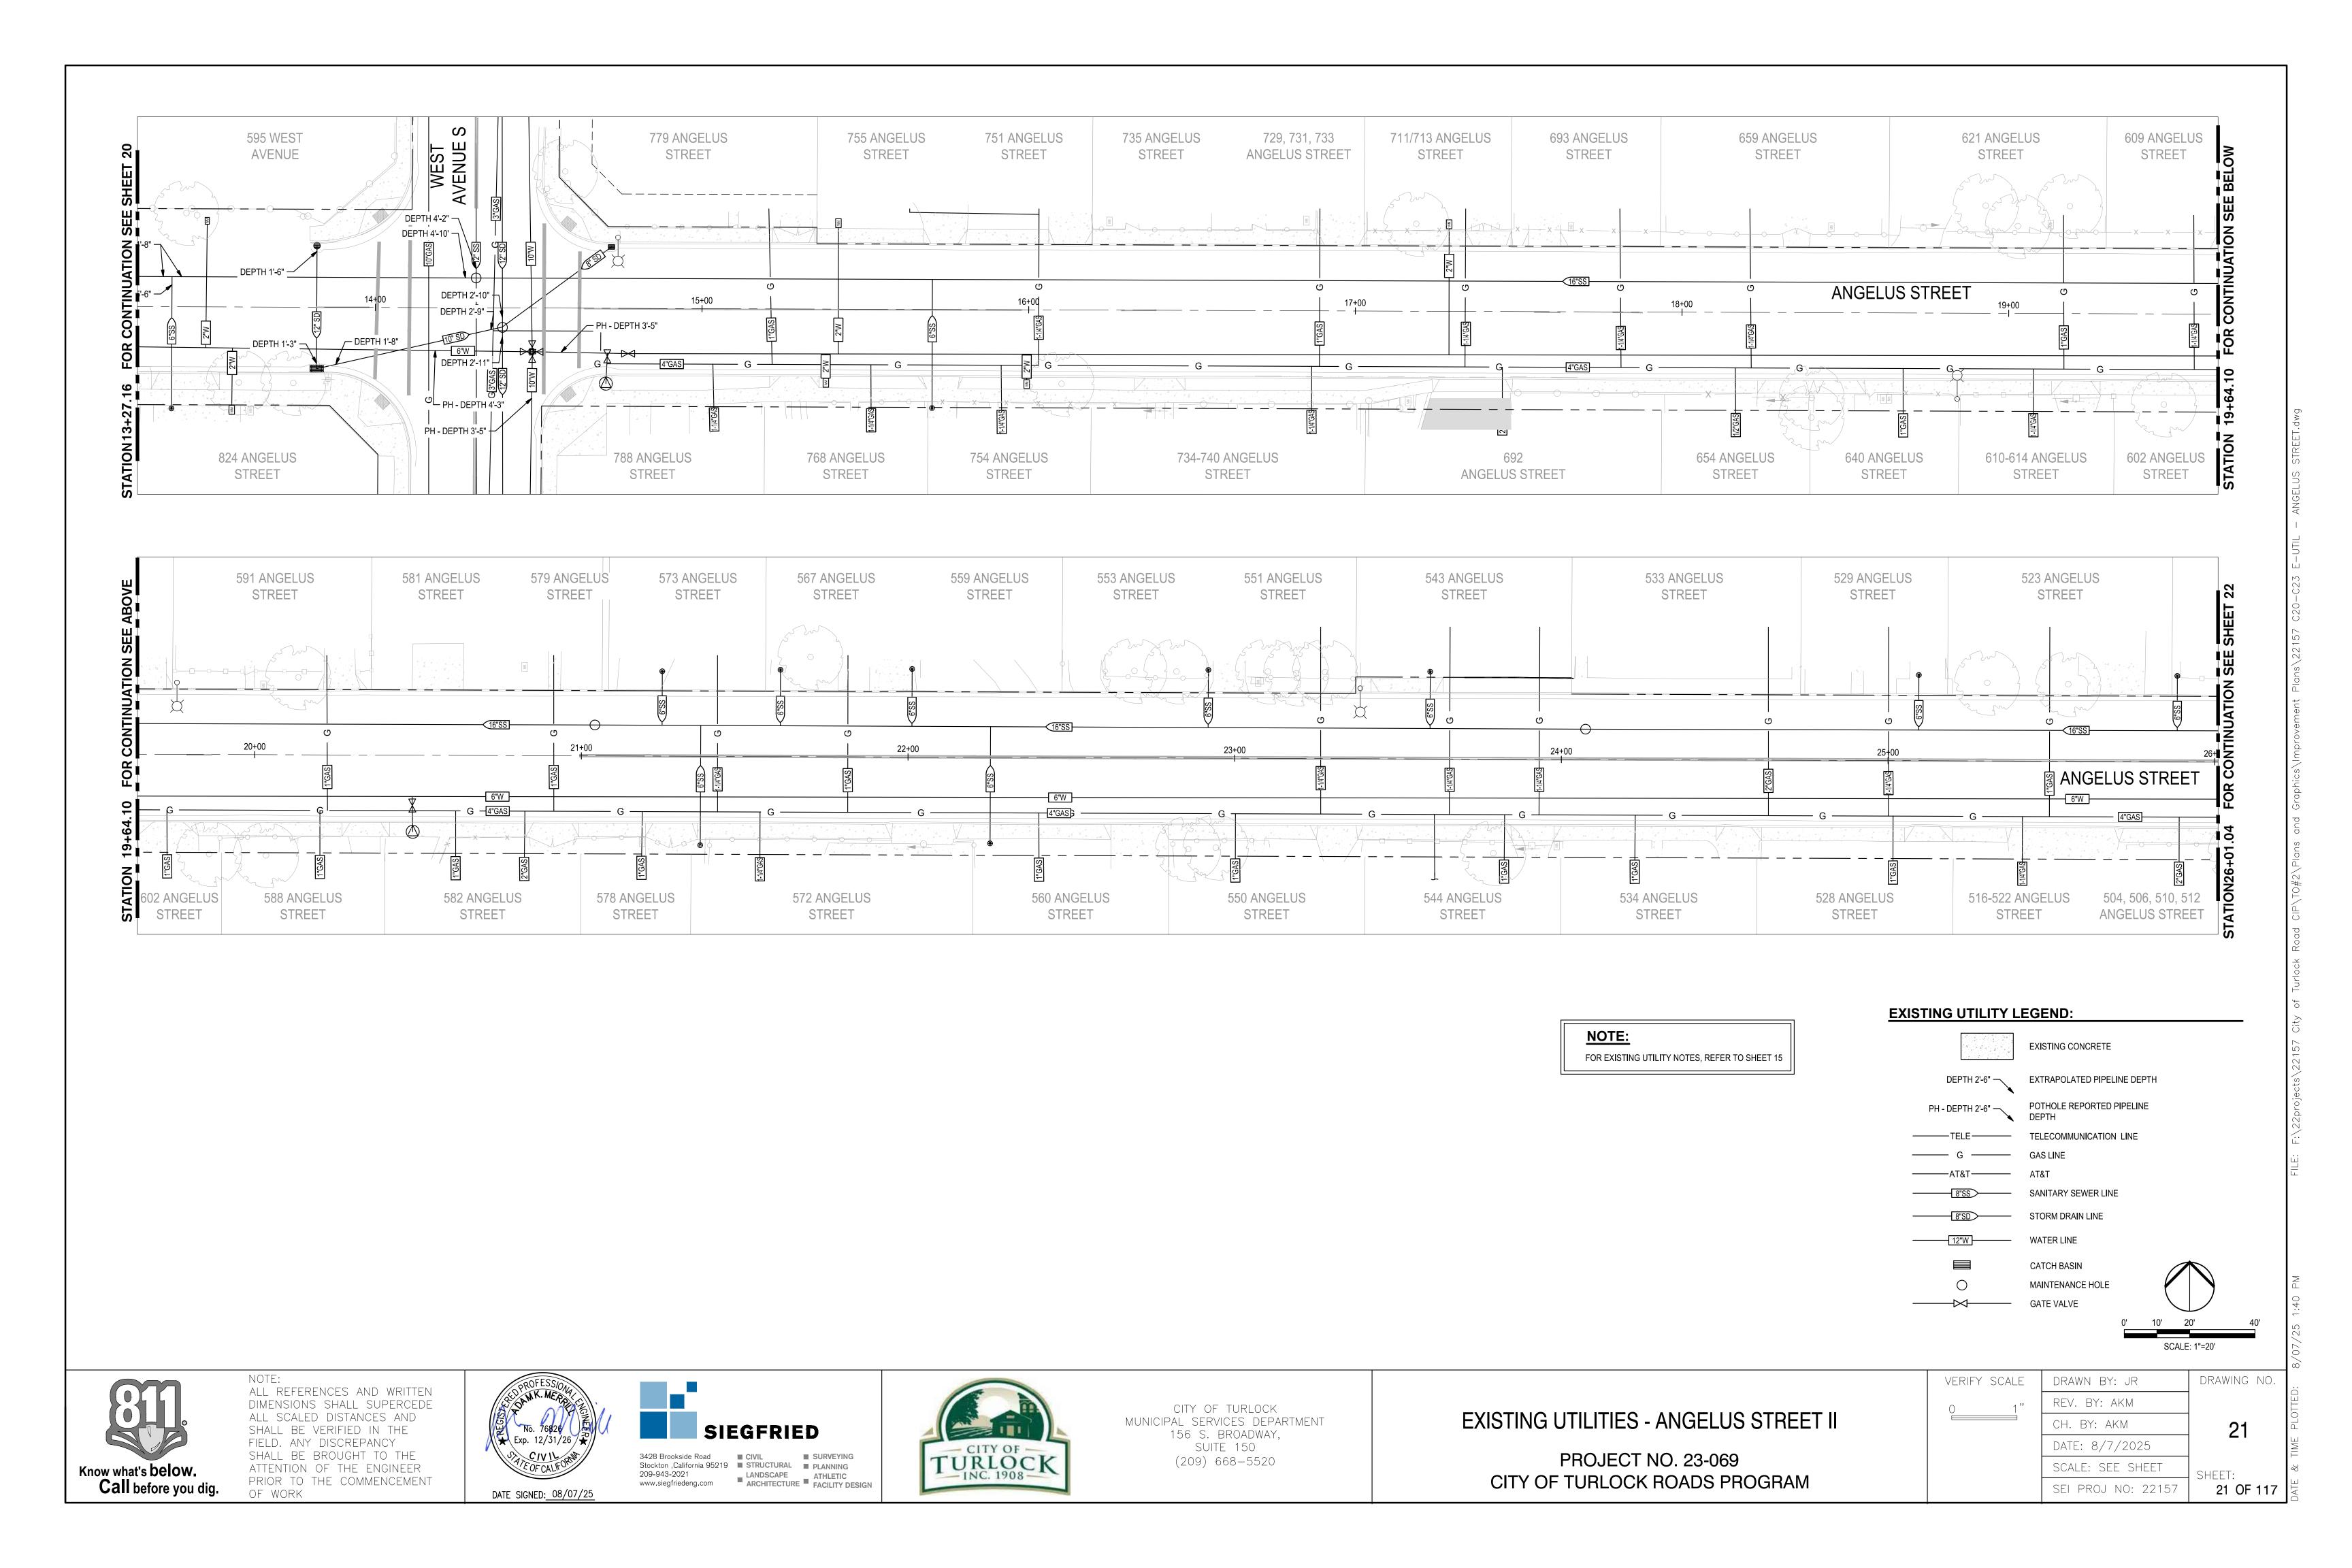

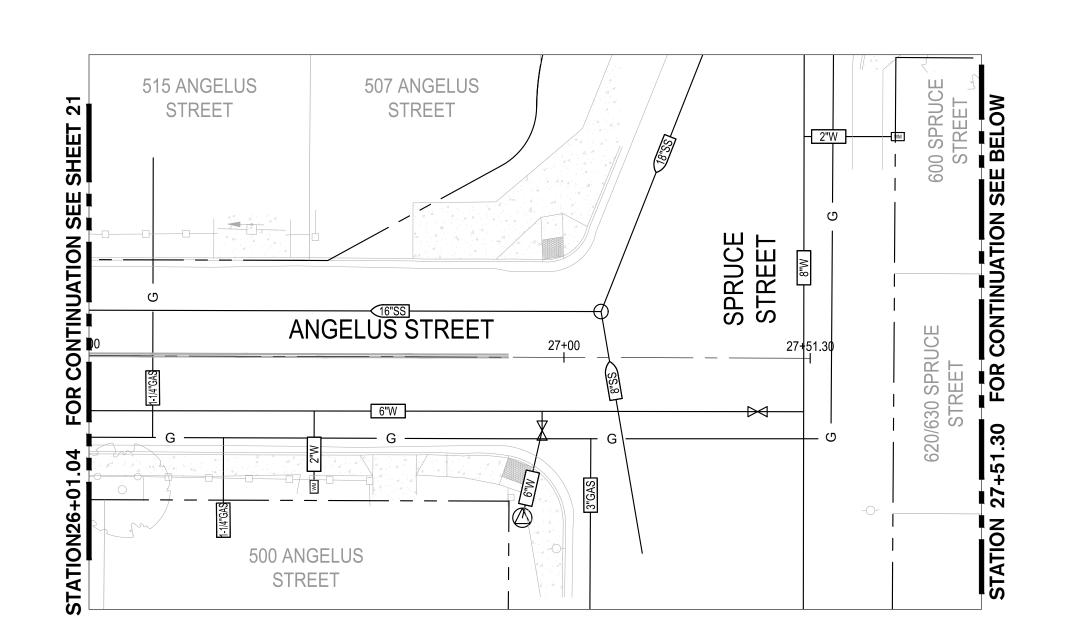


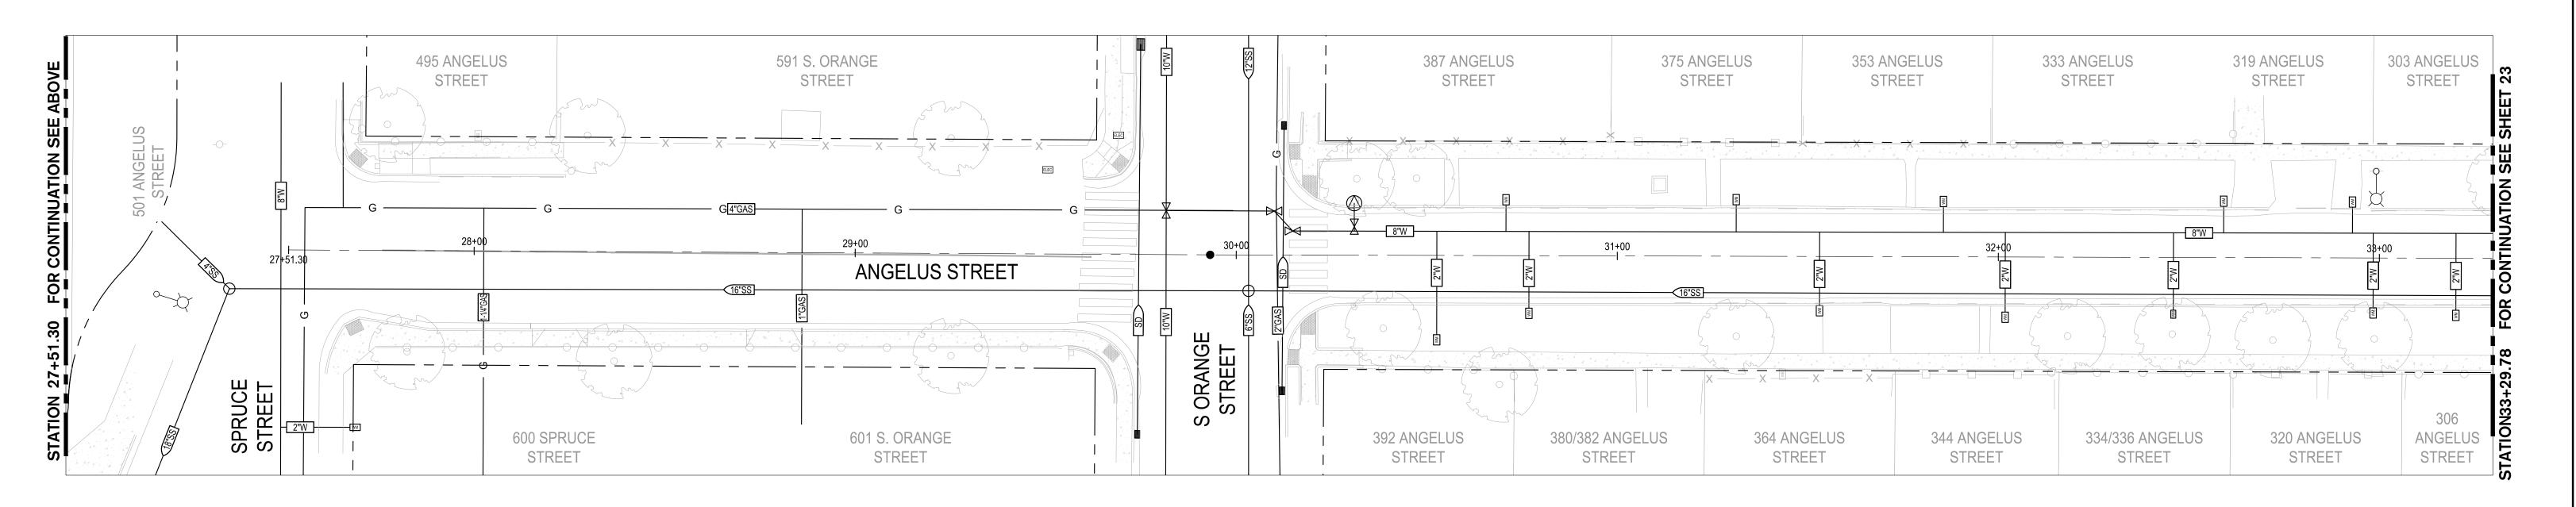

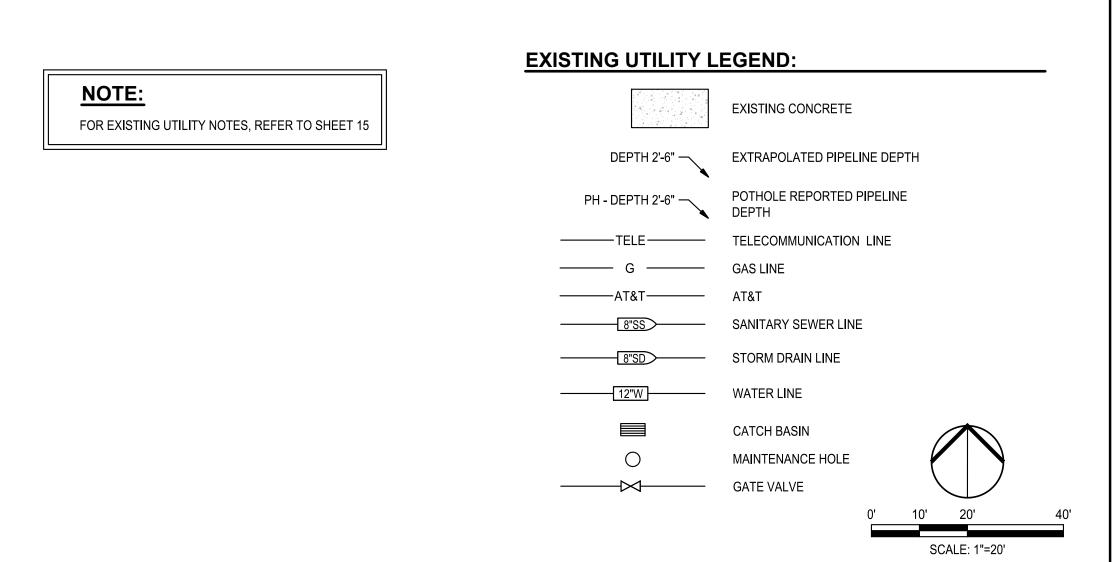



NOTE:
ALL REFERENCES AND WRITTEN
DIMENSIONS SHALL SUPERCEDE
ALL SCALED DISTANCES AND
SHALL BE VERIFIED IN THE
FIELD. ANY DISCREPANCY
SHALL BE BROUGHT TO THE
ATTENTION OF THE ENGINEER
PRIOR TO THE COMMENCEMENT
OF WORK

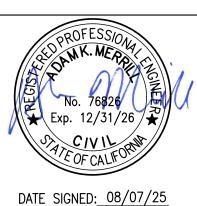








CITY OF TURLOCK
MUNICIPAL SERVICES DEPARTMENT
156 S. BROADWAY,
SUITE 150
(209) 668-5520

VERIFY SCALE	DRAWN BY: JR	drawing no.
0 1"	REV. BY: AKM	
	CH. BY: AKM	22
	DATE: 8/7/2025	
	SCALE: SEE SHEET	SHEET:
	SEI PROJ NO: 22157	22 OF 117

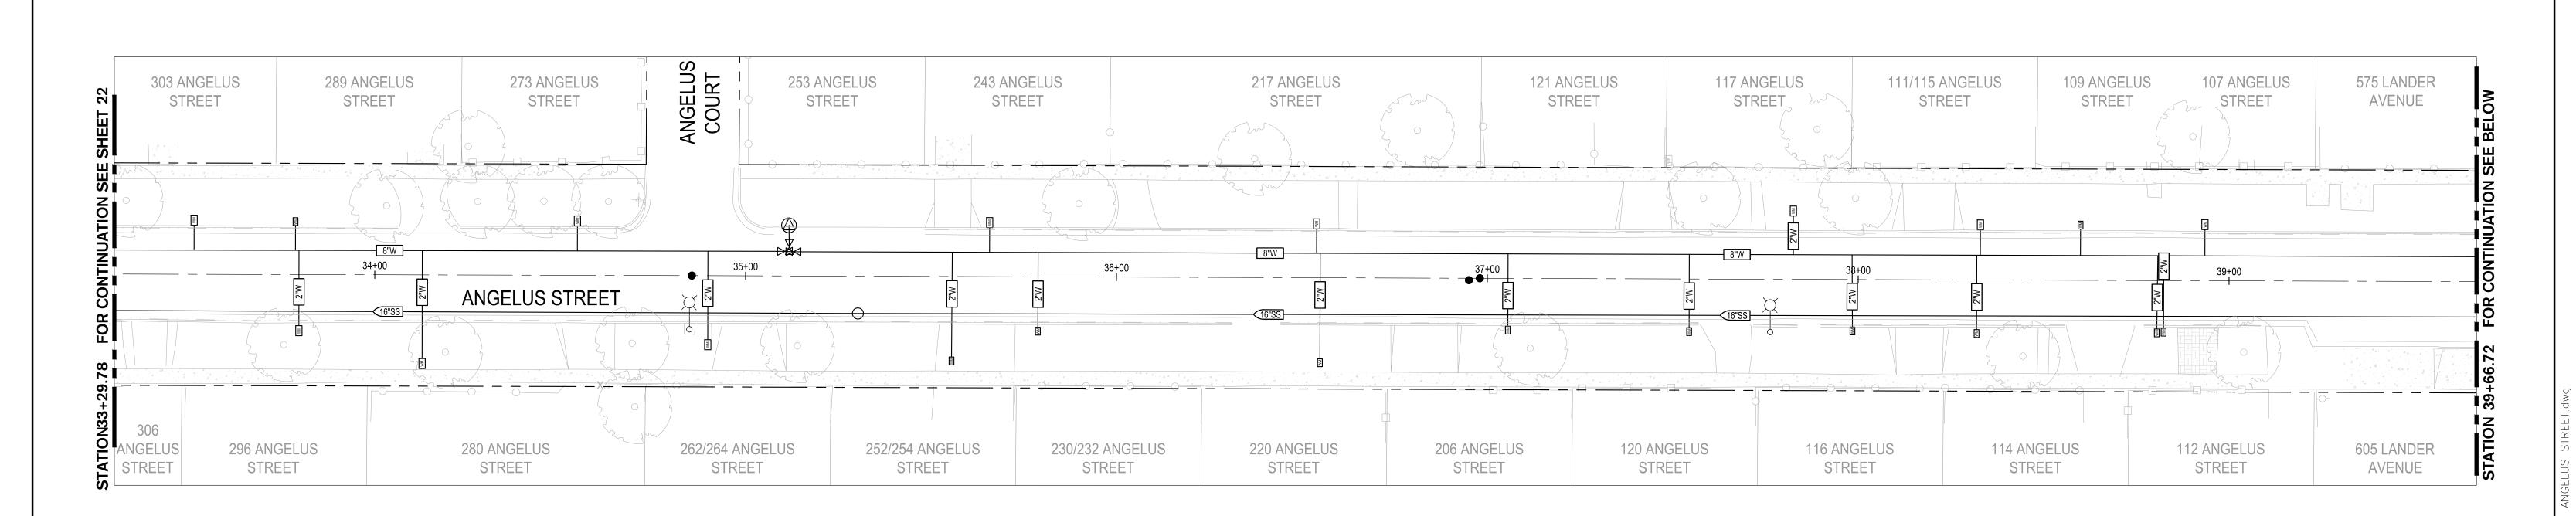


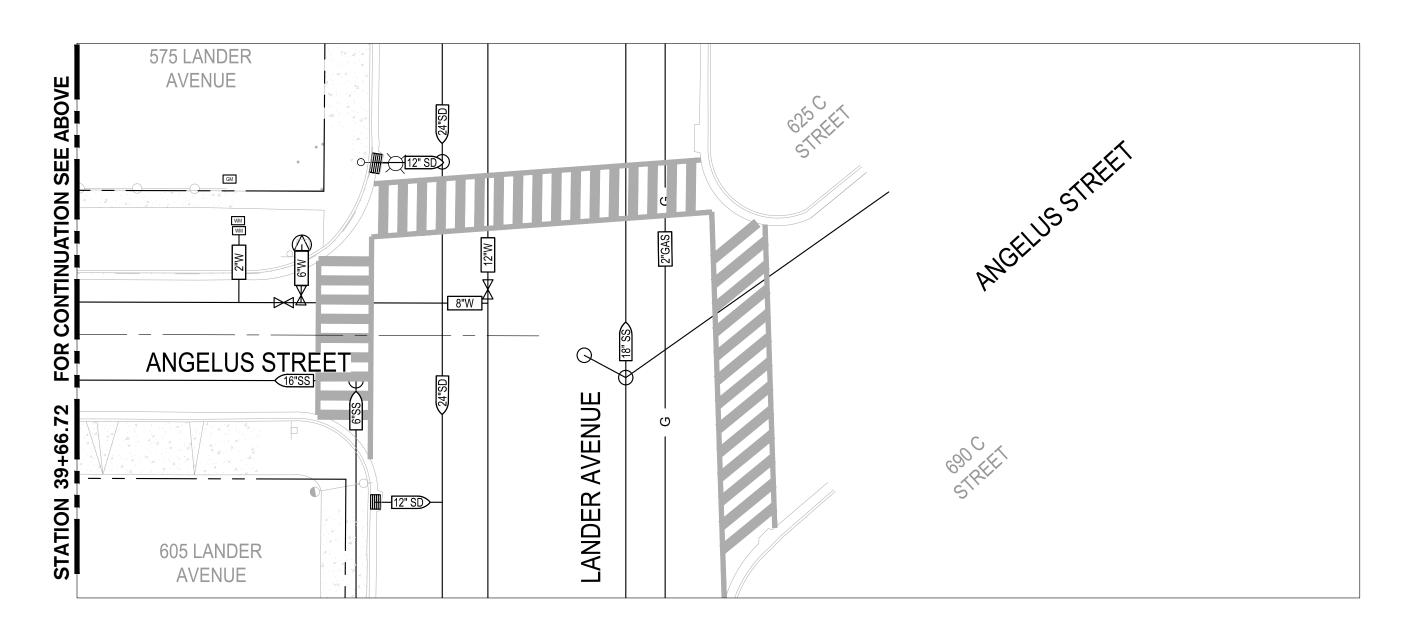


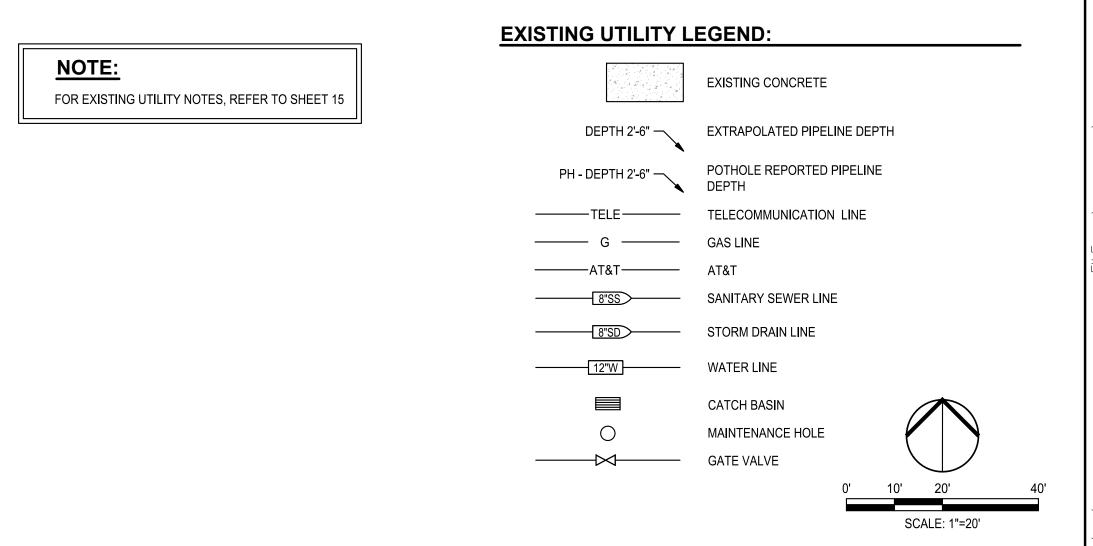




NOTE:
ALL REFERENCES AND WRITTEN
DIMENSIONS SHALL SUPERCEDE
ALL SCALED DISTANCES AND
SHALL BE VERIFIED IN THE
FIELD. ANY DISCREPANCY
SHALL BE BROUGHT TO THE
ATTENTION OF THE ENGINEER
PRIOR TO THE COMMENCEMENT
OF WORK

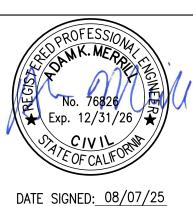

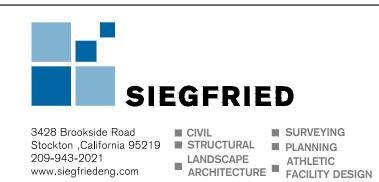

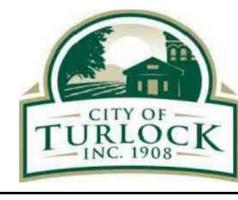



CITY OF TURLOCK
MUNICIPAL SERVICES DEPARTMENT
156 S. BROADWAY,
SUITE 150
(209) 668-5520

EXISTING UTILITIES - ANGELUS STREET IV
PROJECT NO. 23-069


CITY OF TURLOCK ROADS PROGRAM


DRAWN BY: JR	DRAWING NO.
REV. BY: AKM	
CH. BY: AKM	23
DATE: 8/7/2025	
SCALE: SEE SHEET	SHEET:
SEI PROJ NO: 22157	23 OF 117
	REV. BY: AKM CH. BY: AKM DATE: 8/7/2025 SCALE: SEE SHEET

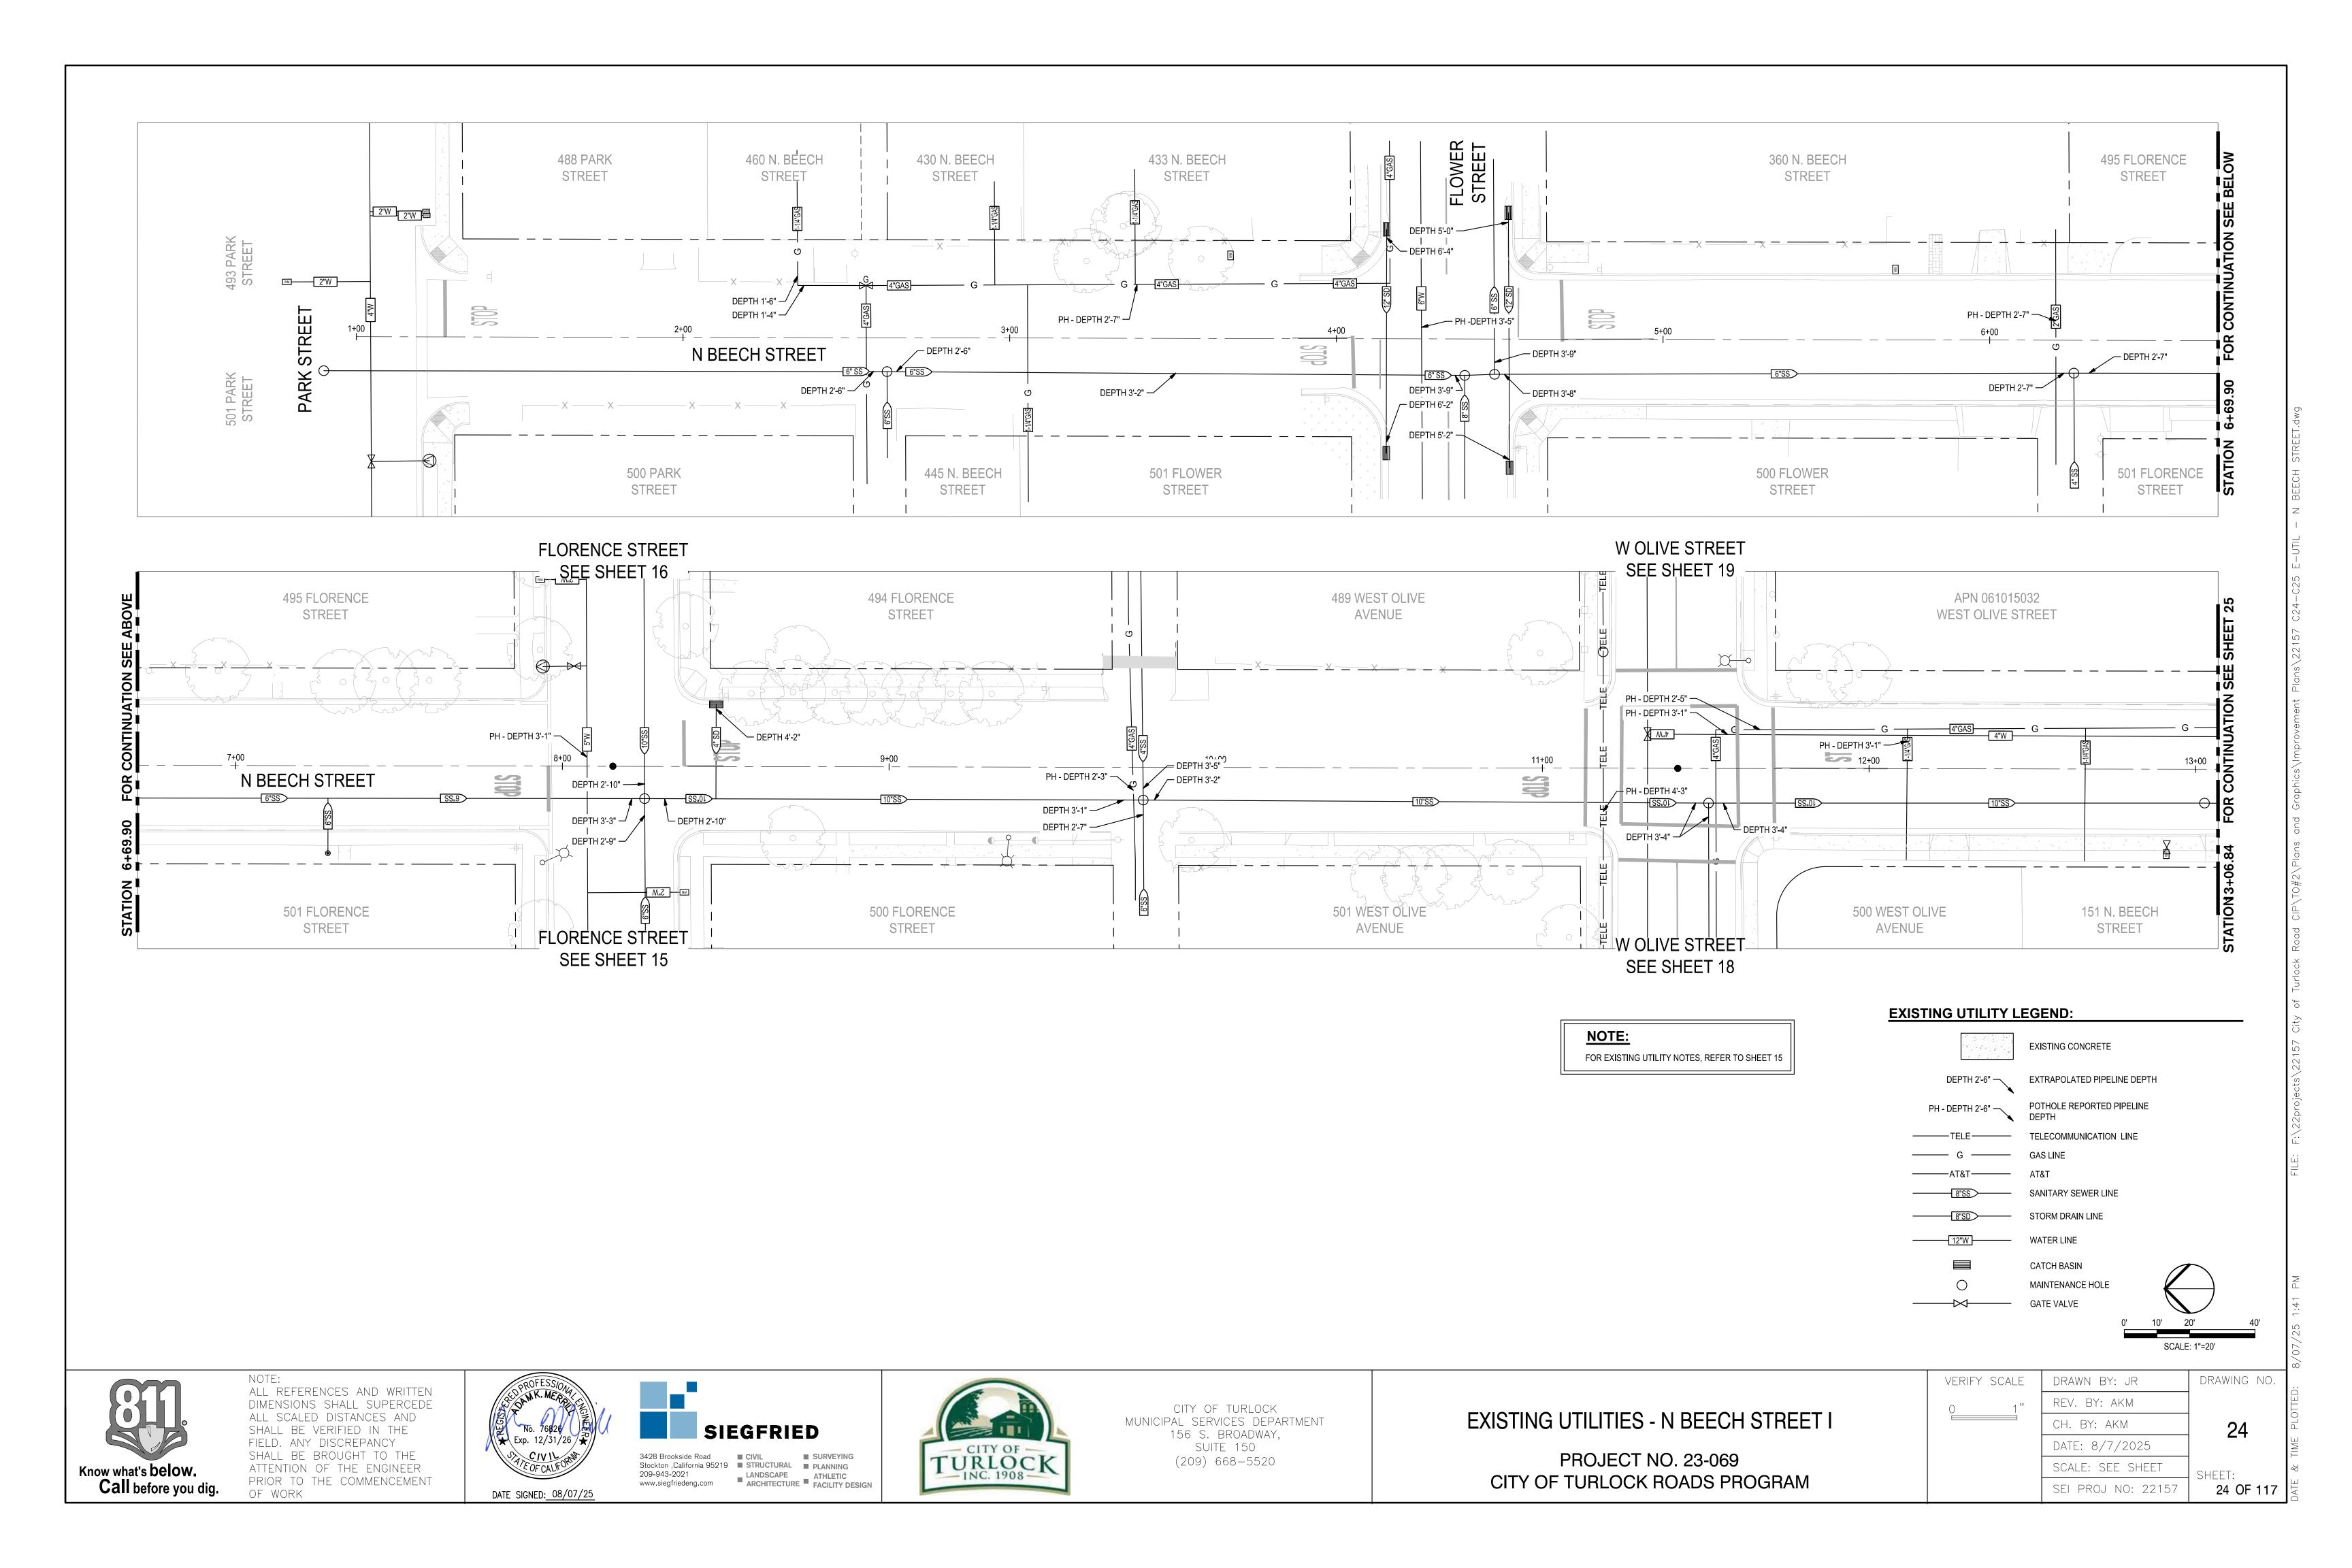

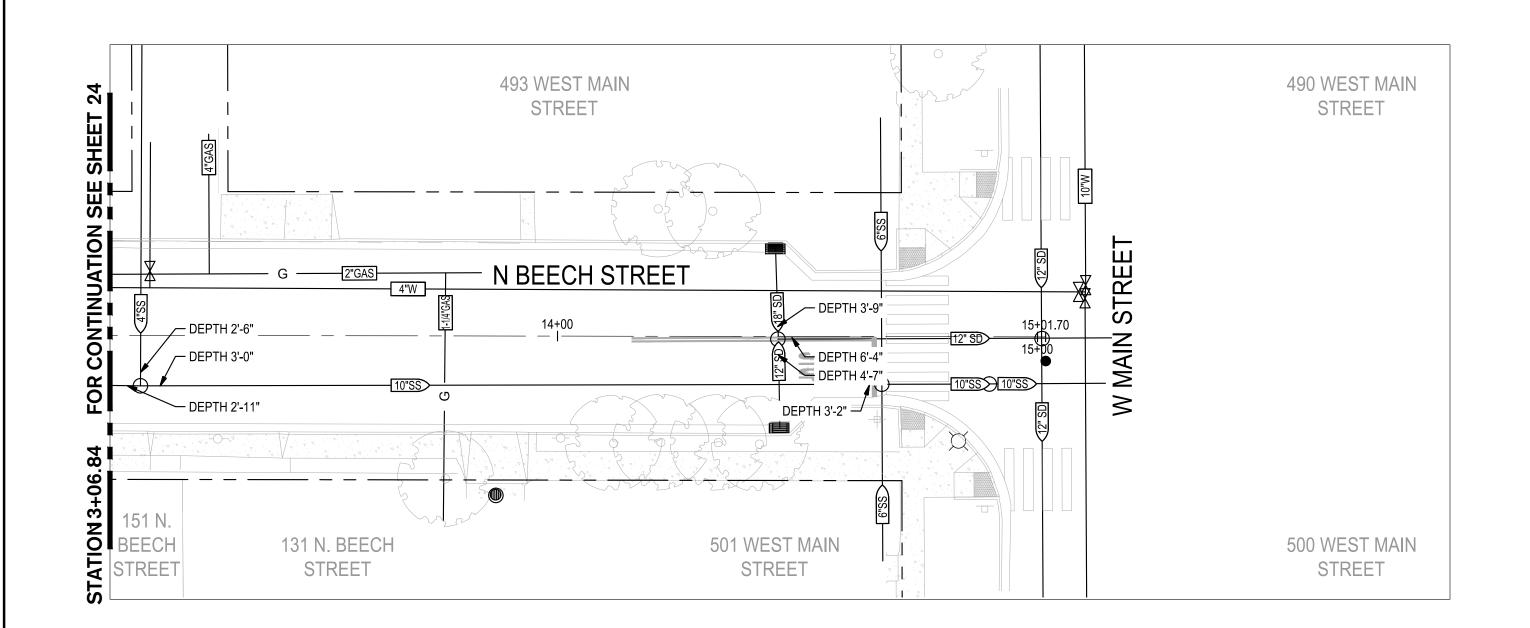


NOTE:
FOR EXISTING UTILITY NOTES, REFER TO SHEET 15

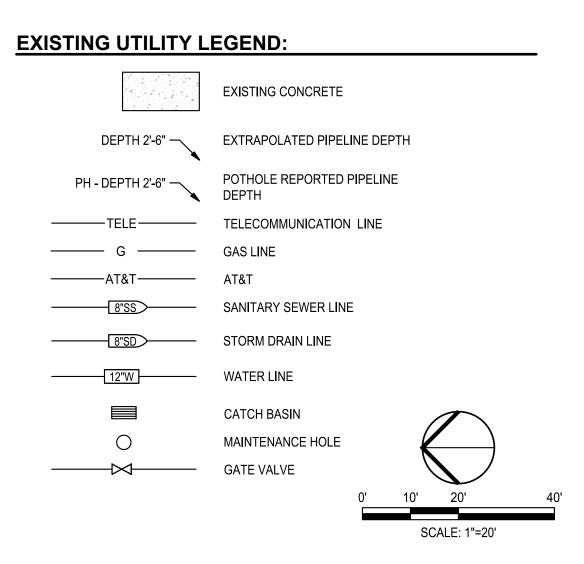


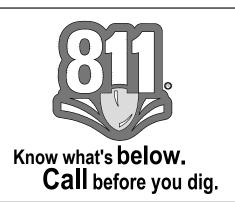

NOTE:
ALL REFERENCES AND WRITTEN
DIMENSIONS SHALL SUPERCEDE
ALL SCALED DISTANCES AND
SHALL BE VERIFIED IN THE
FIELD. ANY DISCREPANCY
SHALL BE BROUGHT TO THE
ATTENTION OF THE ENGINEER
PRIOR TO THE COMMENCEMENT
OF WORK

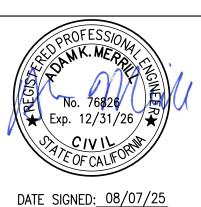




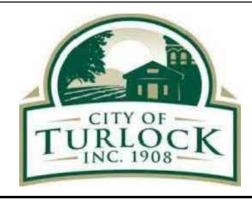

CITY OF TURLOCK MUNICIPAL SERVICES DEPARTMENT 156 S. BROADWAY, SUITE 150 (209) 668-5520

EXISTING UTILITIES - N BEECH STREET II


	SCALE	:: 1"=20"
VERIFY SCALE	DRAWN BY: JR	DRAWING NO.
0 1"	REV. BY: AKM	
	CH. BY: AKM	25
	DATE: 8/7/2025	
	SCALE: SEE SHEET	SHEET:
	SEI PROJ NO: 22157	25 OF 117
•	•	•

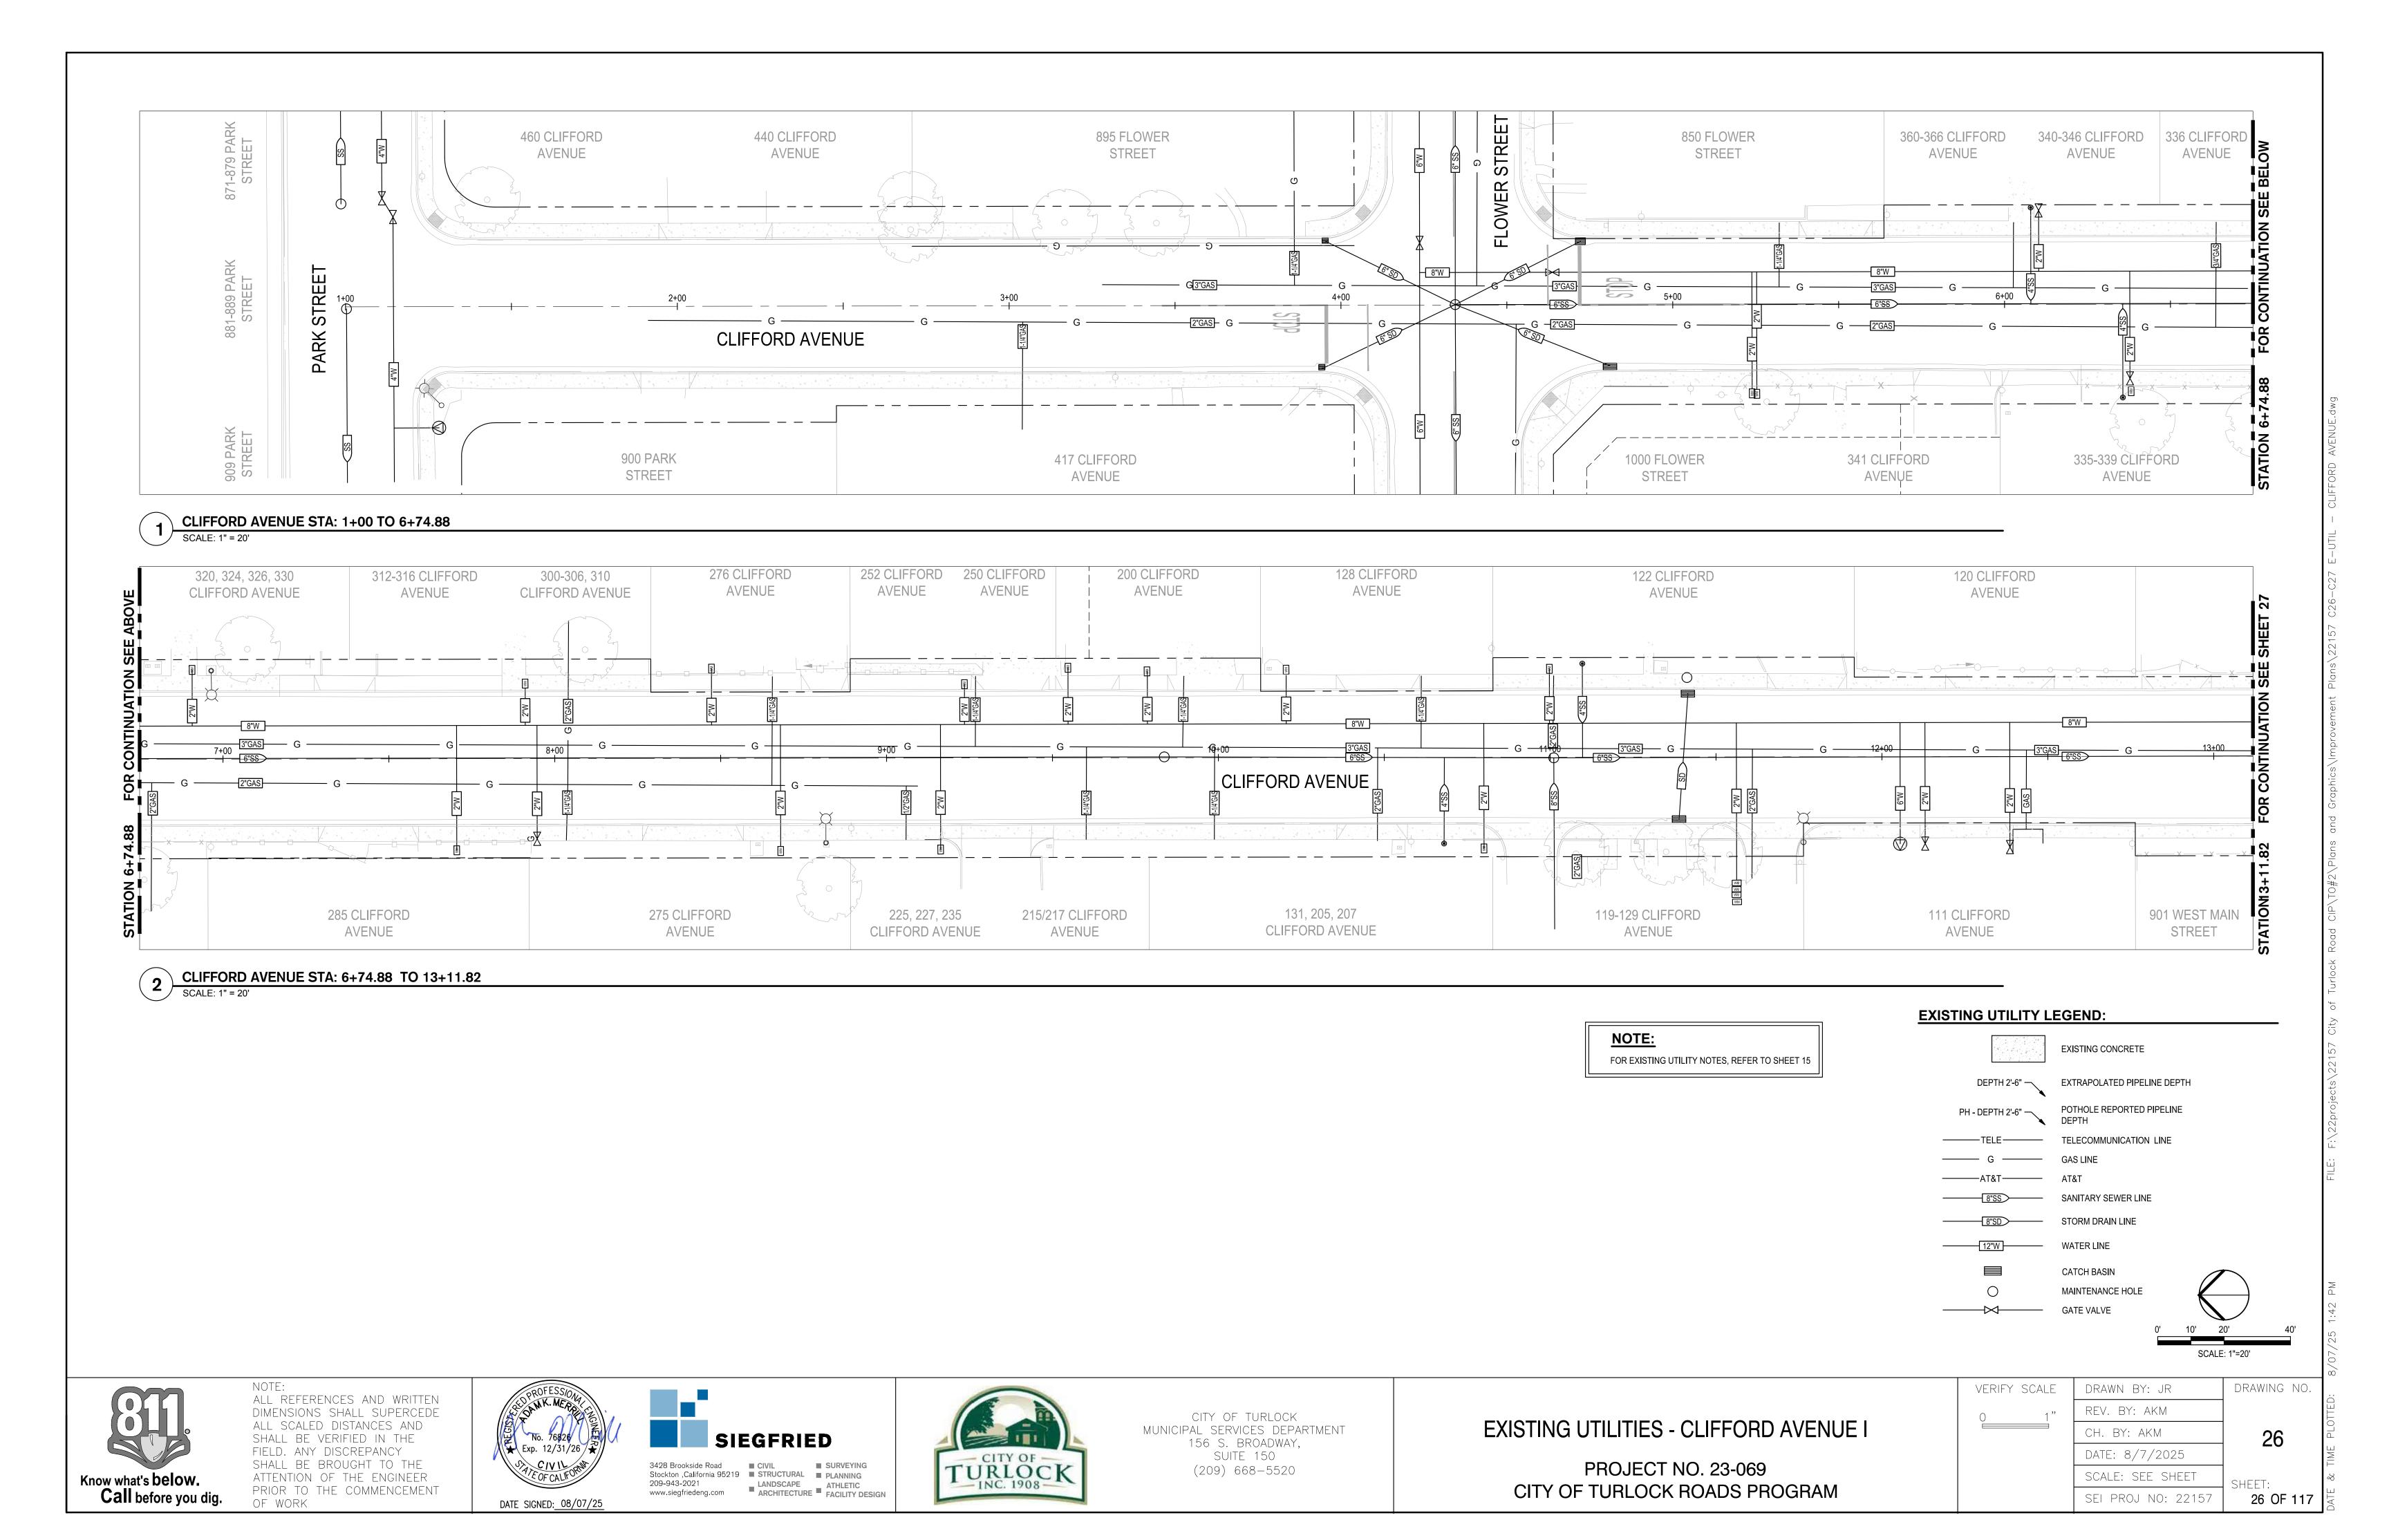

1 CLIFFORD AVENUE STA: 13+11.82 TO END


NOTE:

FOR EXISTING UTILITY NOTES, REFER TO SHEET 15

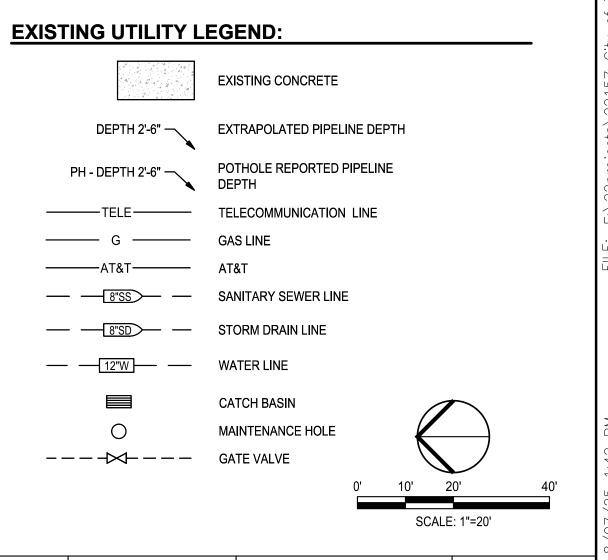




NOTE:
ALL REFERENCES AND WRITTEN
DIMENSIONS SHALL SUPERCEDE
ALL SCALED DISTANCES AND
SHALL BE VERIFIED IN THE
FIELD. ANY DISCREPANCY
SHALL BE BROUGHT TO THE
ATTENTION OF THE ENGINEER
PRIOR TO THE COMMENCEMENT
OF WORK

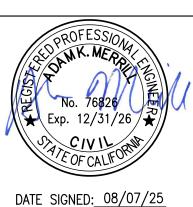



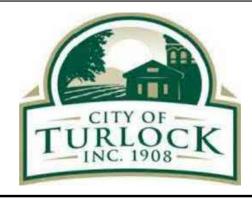



CITY OF TURLOCK MUNICIPAL SERVICES DEPARTMENT 156 S. BROADWAY, SUITE 150 (209) 668-5520

EXISTING UTILITIES - CLIFFORD AVENUE II
PROJECT NO. 23-069


CITY OF TURLOCK ROADS PROGRAM

RIFY SCALE	DRAWN BY: JR	DRAWING NO
1"	REV. BY: AKM	
	CH. BY: AKM	27
	DATE: 8/7/2025	
	SCALE: SEE SHEET	SHEET:
	SEI PROJ NO: 22157	27 OF 11
	l .	

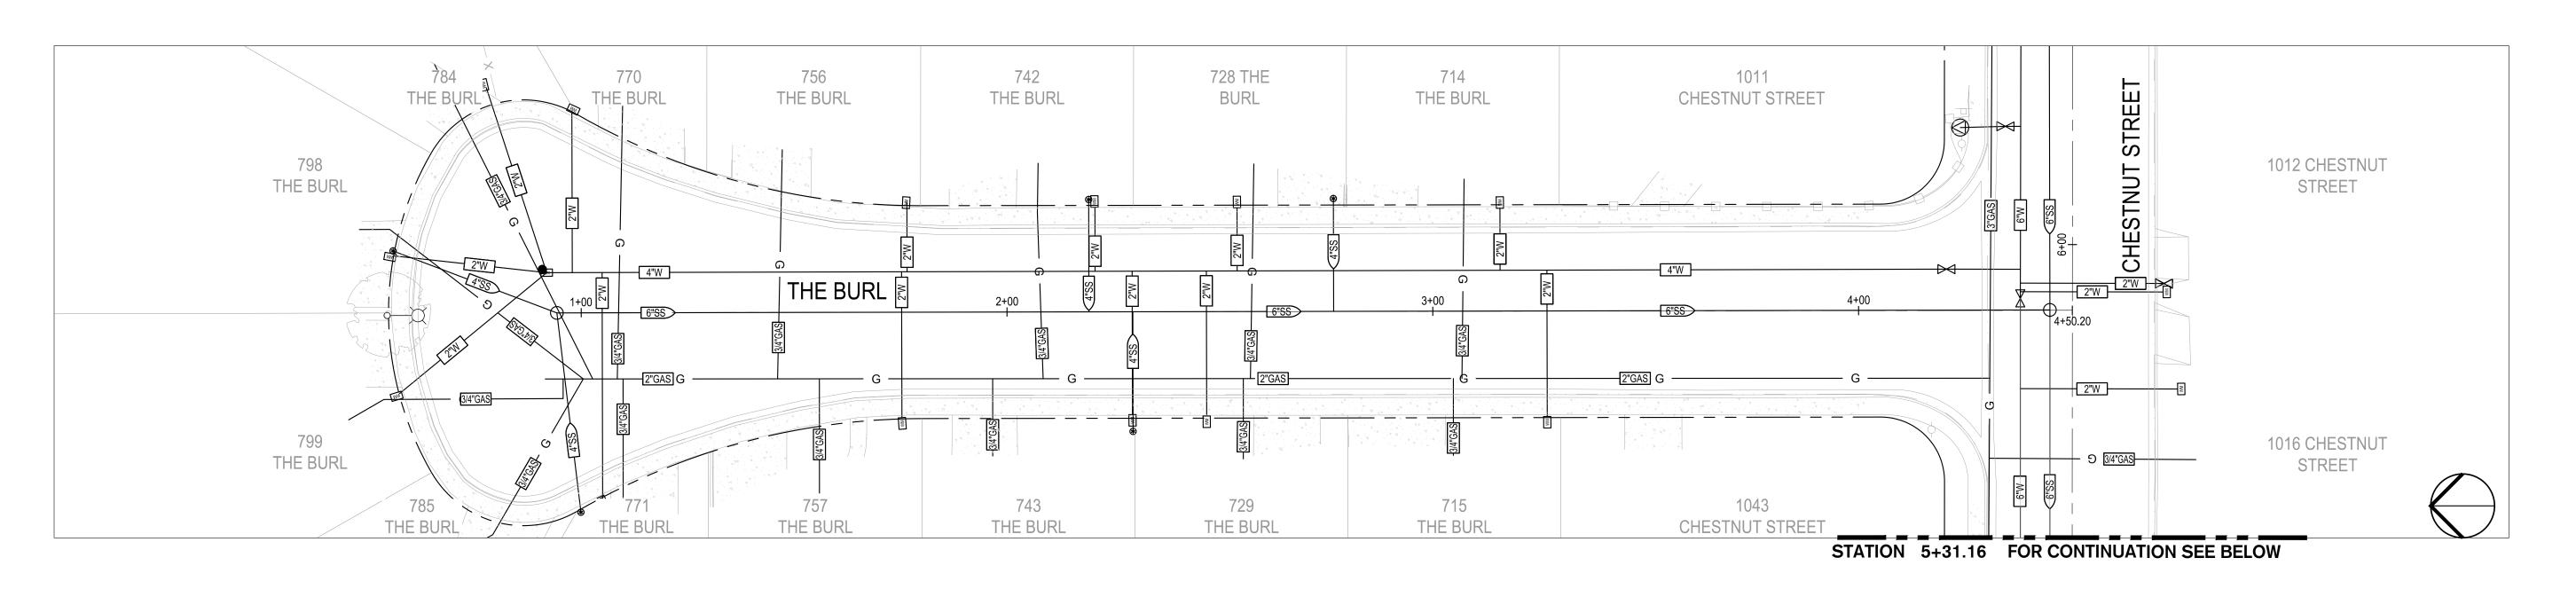

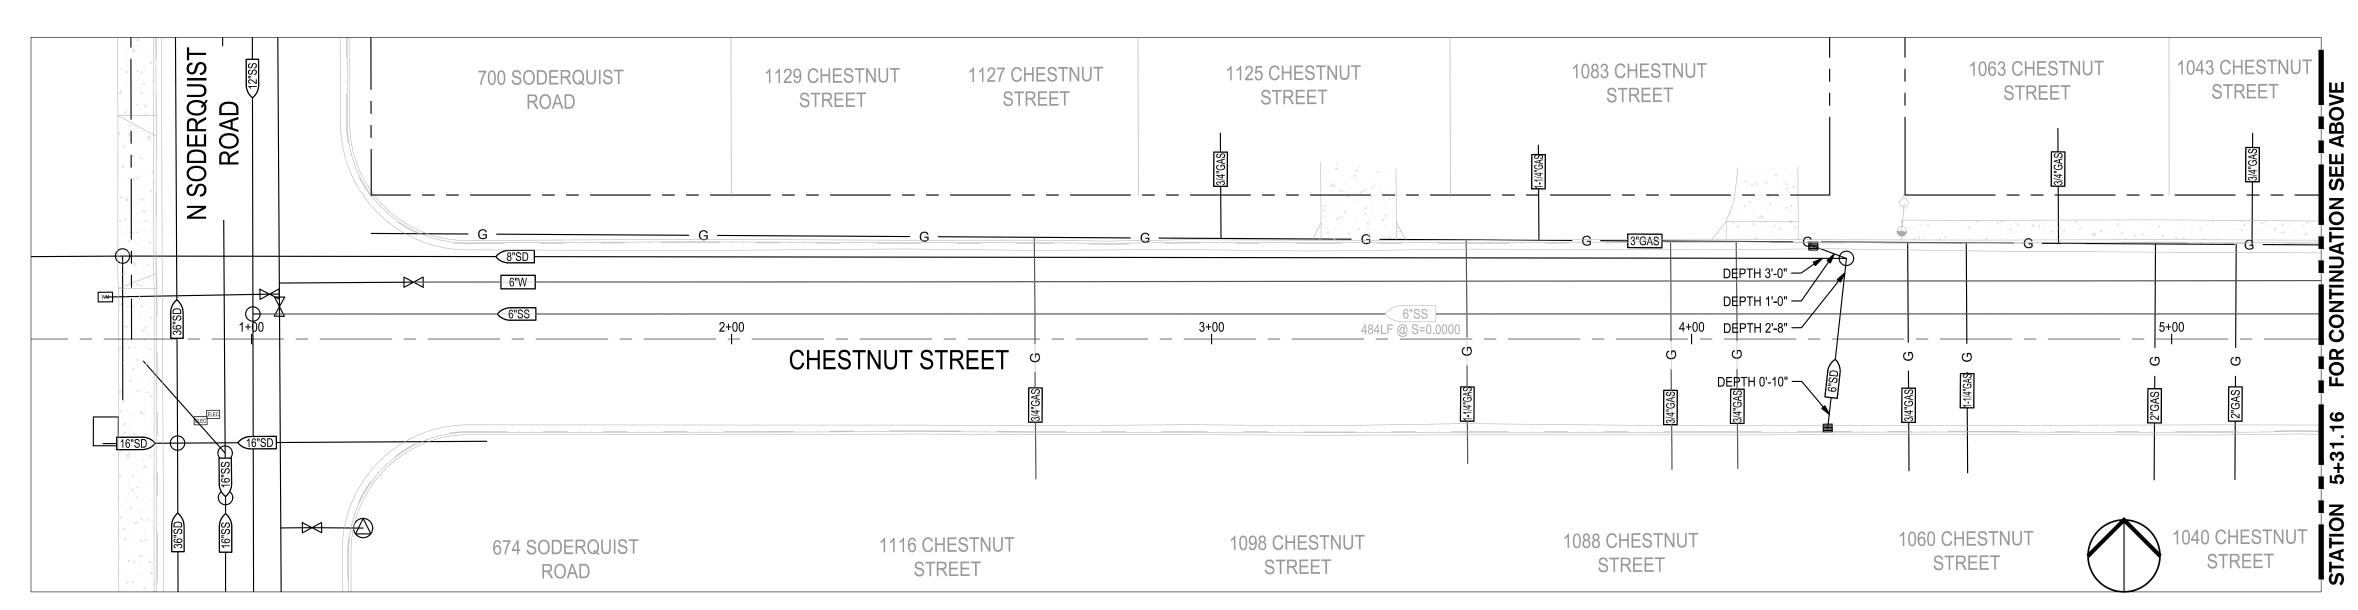




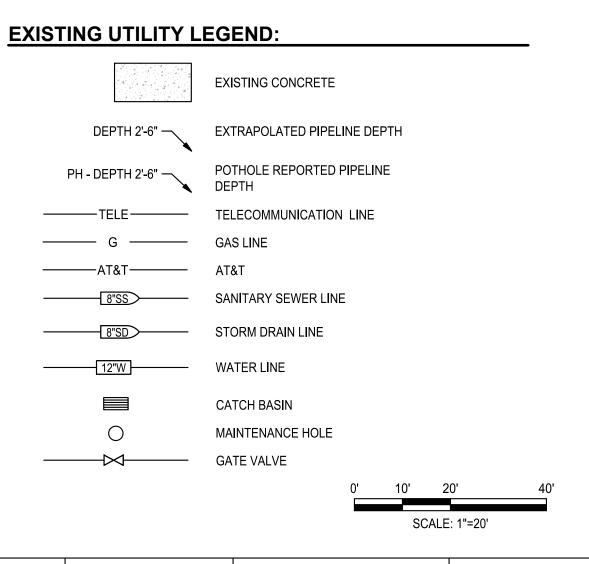




NOTE:
ALL REFERENCES AND WRITTEN
DIMENSIONS SHALL SUPERCEDE
ALL SCALED DISTANCES AND
SHALL BE VERIFIED IN THE
FIELD. ANY DISCREPANCY
SHALL BE BROUGHT TO THE
ATTENTION OF THE ENGINEER
PRIOR TO THE COMMENCEMENT
OF WORK

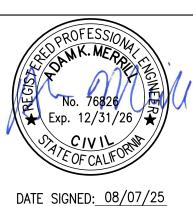



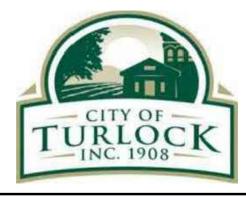



CITY OF TURLOCK
MUNICIPAL SERVICES DEPARTMENT
156 S. BROADWAY,
SUITE 150
(209) 668-5520

EXISTING UTILITIES - THE BURL


PROJECT NO. 23-069	
CITY OF TURLOCK ROADS PROGRA	M

VERIFY SCALE	DRAWN BY: JR	drawing no.
0 1"	REV. BY: AKM	
	CH. BY: AKM	28
	DATE: 8/7/2025	
	SCALE: SEE SHEET	SHEET:
	SEI PROJ NO: 22157	28 OF 117

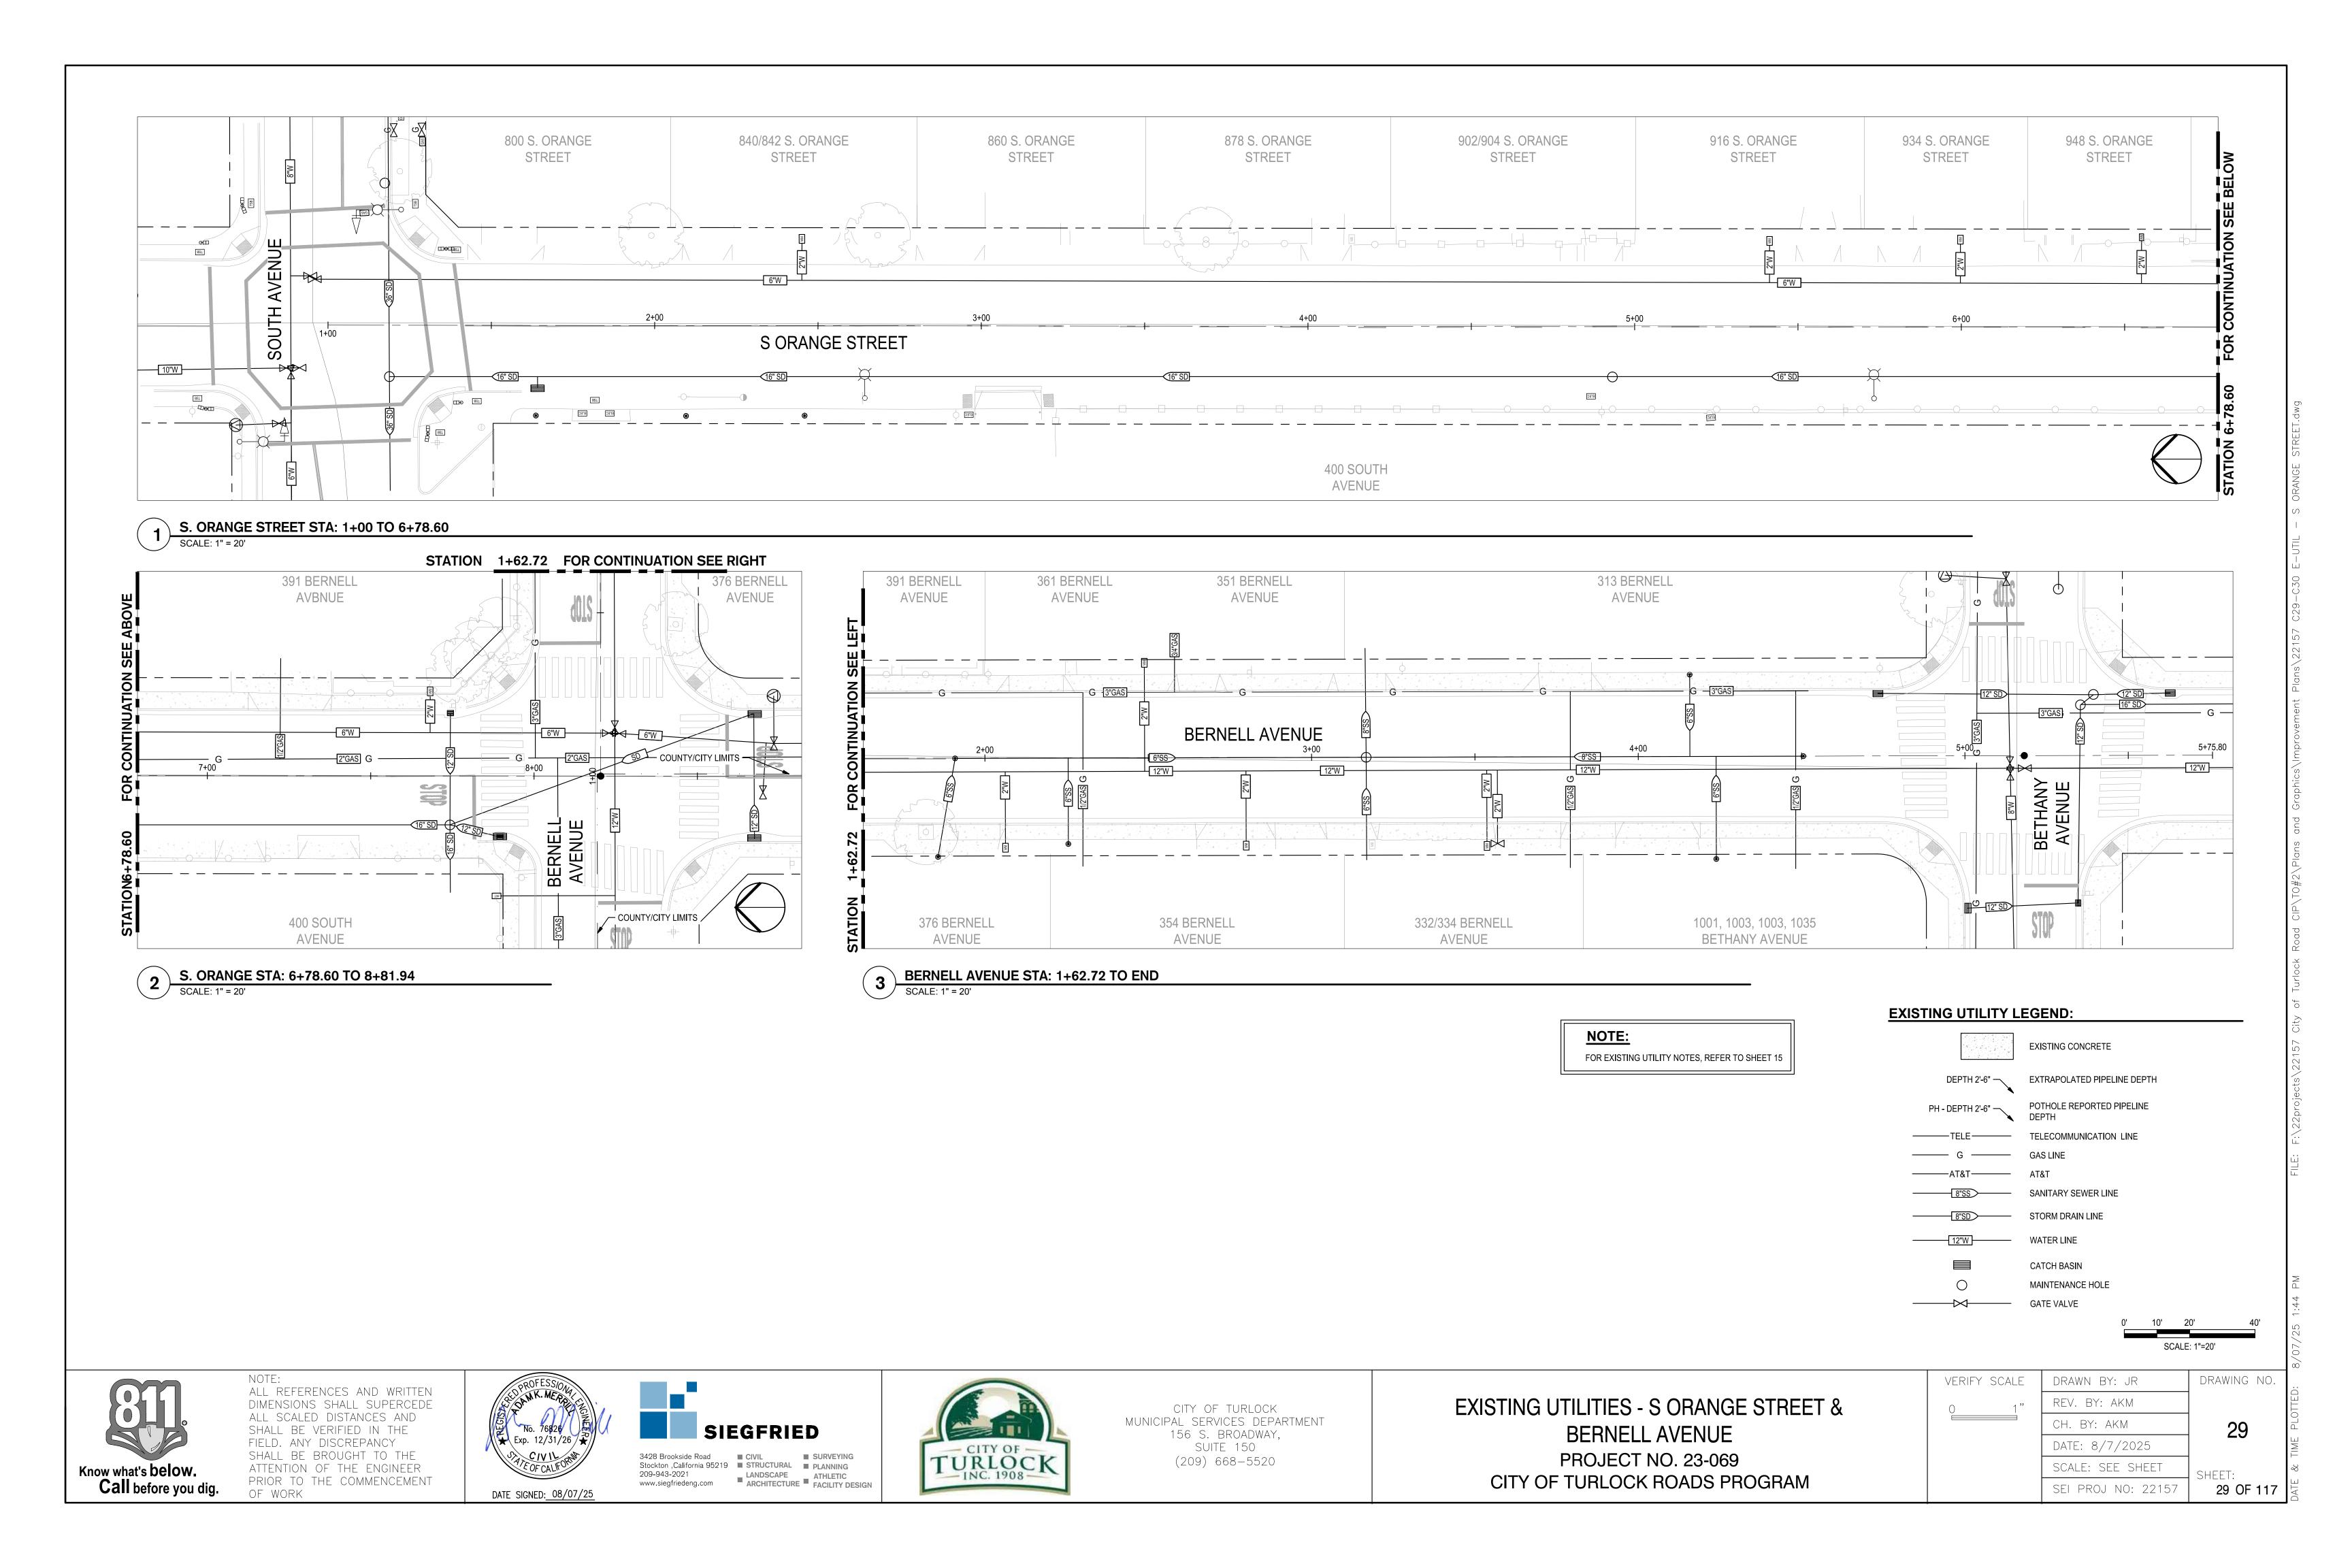

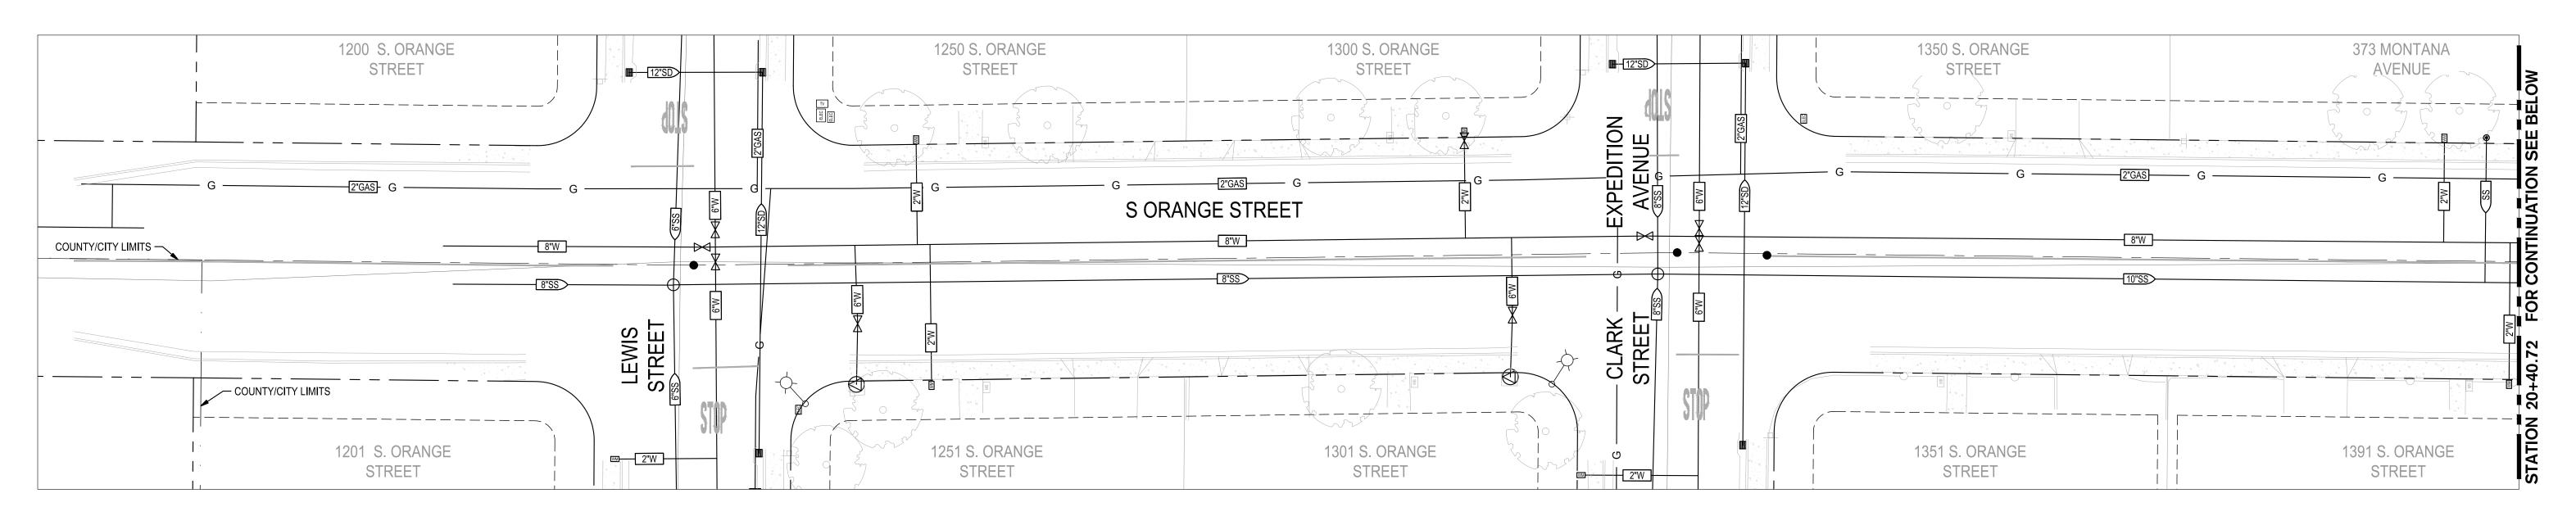



S. ORANGE STREET STA: 14+51.50 TO 20+40.72

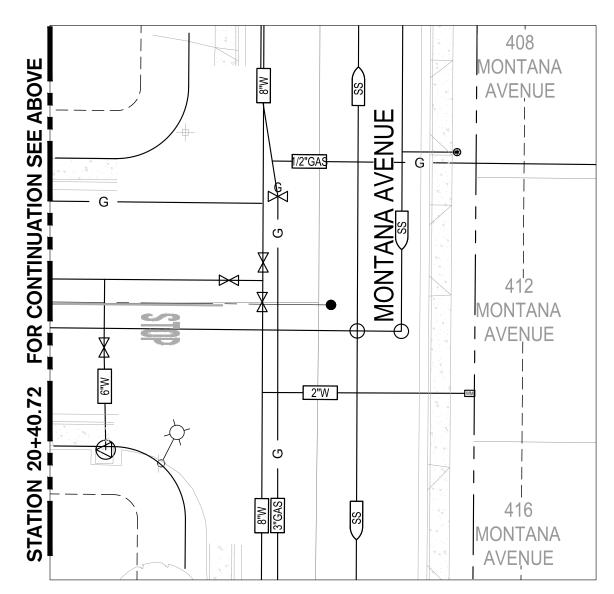

2 S. ORANGE STA: 20+40.72 TO END


SCALE: 1" = 20'

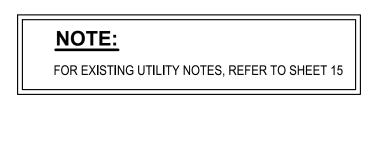

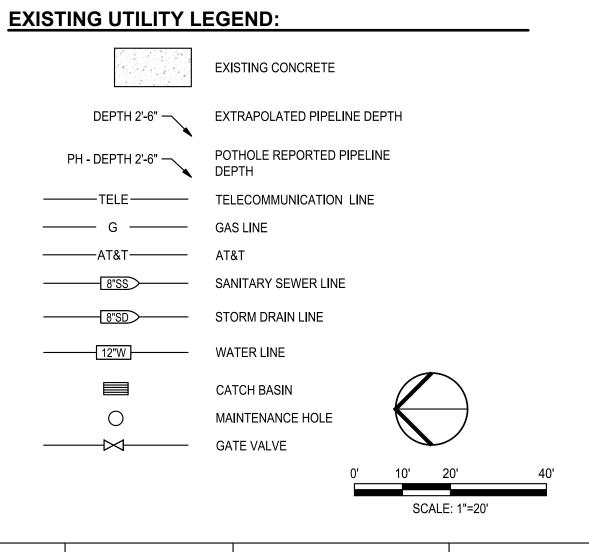



NOTE:
ALL REFERENCES AND WRITTEN
DIMENSIONS SHALL SUPERCEDE
ALL SCALED DISTANCES AND
SHALL BE VERIFIED IN THE
FIELD. ANY DISCREPANCY
SHALL BE BROUGHT TO THE
ATTENTION OF THE ENGINEER
PRIOR TO THE COMMENCEMENT
OF WORK

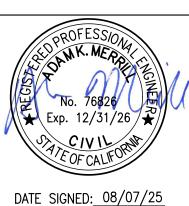





CITY OF TURLOCK MUNICIPAL SERVICES DEPARTMENT 156 S. BROADWAY, SUITE 150 (209) 668-5520

DRAWN BY: JR	DRAWING NO.
REV. BY: AKM	
CH. BY: AKM	30
DATE: 8/7/2025	
SCALE: SEE SHEET	SHFFT:
SEI PROJ NO: 22157	30 OF 117
	REV. BY: AKM CH. BY: AKM DATE: 8/7/2025 SCALE: SEE SHEET

FLORENCE STREET STA: 1+00 TO 6+80.59

SEE SHEET 40 601/603 FLORENCE 589 FLORENCE 501 FLORENCE 525 FLORENCE 613 FLORENCE 557 FLORENCE 539 FLORENCE STREET STREET STREET STREET STREET STREET MATCH EX. ±97.81F 98.39FG FLORENCE STREET 0.14% 20 15 日間で 552 FLORENCE 98.37FG 536 FLORENCE 600 FLORENCE STA:8+74.04 520 FLORENCE STREET STREET STREET MATCH EX. ±97.56FL N BEECH STREET

CONSTRUCTION KEYNOTES:

REMOVE AND RECONSTRUCT CONCRETE CURB & GUTTER PER CITY OF TURLOCK STD. C-1

FLORENCE STREET STA: 6+80.59 TO 13+17.53

- REMOVE AND RECONSTRUCT CONCRETE DRIVEWAY APPROACH PER CITY OF TURLOCK STD. C-5
- REMOVE CURB AND CONSTRUCT CONCRETE CURB & GUTTER PER CITY OF TURLOCK STD. C-1
- 4 REMOVE AND RECONSTRUCT SIDEWALK PER CITY OF TURLOCK STD. C-3
- REMAIN IN PLACE EXISTING WATER METER
- ADJUST EXISTING SANITARY SEWER CLEANOUT TO GRADE
- CONFORM TO EXISTING PAVEMENT. SEE DETAIL 2 ON SHEET 115.
- REMOVE CURB RAMP AND CONSTRUCT MODIFIED CASE F CURB RAMP PER CALTRANS STD. A88A
- (9) REMAIN IN PLACE EXISTING ROADSIDE SIGN AND POST
- CONSTRUCT CONCRETE VALLEY GUTTER PER CITY OF TURLOCK STD. C-1
- REMOVE AND REPLACE FIRE HYDRANT PER CITY OF TURLOCK STD. W-1
- REMOVE AND RELOCATE ROADSIDE SIGN AND POST. SEE STRIPING PLAN FOR MORE DETAILS.
- REPLACE EXISTING WATER VALVE BOX. SET TO NEW PAVEMENT GRADE. SEE CITY OF TURLOCK WATER VALVE BOX DETAIL STD. W-6

- REMAIN IN PLACE EXISTING FIRE HYDRANT
- REMAIN IN PLACE EXISTING POWER POLE
- ADJUST EXISTING SANITARY SEWER MANHOLE TO GRADE
- REMAIN IN PLACE EXISTING STREET LIGHT
- REMOVE AND RESET SURVEY MONUMENT. CONTRACTOR SHALL NOTIFY ENGINEER OF ALL MONUMENTS THAT ARE TO BE RESET DUE TO CONSTRUCTION OPERATIONS.
- INSTALL SIGN PANEL AND POST. SEE SIGNING AND STRIPING PLANS FOR MORE DETAILS.
- INSTALL SIGN PANEL ON EXISTING POST/POLE. SEE SIGNING AND STRIPING PLANS FOR MORE DETAILS. REMOVE AND DISPOSE EXISTING STORM DRAIN MANHOLE INLET.
- CONTRACTOR SHALL ABANDON AND PLUG EXISTING STORM PIPE IN PLACE WITH 3 FEET OF CONCRETE AT END. CONTRACTOR SHALL MAKE WATER-TIGHT THE ABANDONED SECTION. FOR PROPOSED STORM DRAIN INLET SEE UTILITY PLANS FOR MORE DETAILS. REMOVAL OF EXISTING INLET AND PIPE SHALL
- REMOVE AND DISPOSE EXISTING STORM DRAIN INLET. INSTALL CATCH BASIN AND FRAME PER CITY OF TURLOCK STD. SD-3 AND SD-5.
- REMOVE AND DISPOSE EXISTING STORM DRAIN LINE. SEE UTILITY PLANS FOR PROPOSED STORM DRAIN PIPE.

ACCOMMODATE PROPOSED IMPROVEMENTS.

- PLUG AND ABANDON EXISTING STORM DRAIN PIPE. CONTRACTOR SHALL ABANDON AND PLUG EXISTING STORM PIPE IN PLACE WITH 3 FEET OF CONCRETE AT END. CONTRACTOR SHALL MAKE WATER-TIGHT THE
- REMOVE COMPLETELY EXISTING TREE PER ARBORIST REVIEW. CONTRACTOR SHALL REMOVE STUMP & ROOTS AND GRIND AS NEEDED PRIOR TO
- REMOVE AND DISPOSE OF EXISTING STORM DRAIN UNDER DRAIN TINHORN.
- REMAIN IN PLACE EXISTING FENCE

ABANDONED SECTION.

- REMOVE ROLLED CURB AND CONSTRUCT CONCRETE
- CURB & GUTTER PER CITY OF TURLOCK STD. C-1 BEGIN ROLLED CURB & GUTTER TRANSITION.
- END ROLLED CURB & GUTTER TRANSITION. SEE DETAIL 1 ON SHEET 115.

SEE DETAIL 1 ON SHEET 115.

- ADJUST EXISTING WATER METER TO GRADE
- 1.5" GRIND AND OVERLAY TO RESTRIPE CROSSWALK
- CONTRACTOR SHALL MODIFY CURB & GUTTER IN FRONT OF TREE PER DETAIL 1 ON SHEET 46

NOTES:

- LIMITS OF PAVEMENT REHABILITATION APPROXIMATE. CONTRACTOR TO VERIFY THE LOCATION OF CONFORM AND RECEIVE FINAL APPROVAL FROM THE ENGINEER.
- EXISTING CURB, CURB AND GUTTER, DRIVEWAYS, AND SIDEWALK TO BE PROTECTED IN PLACE **UNLESS NOTED ON PLANS**
- LOCATIONS OF CONCRETE REPLACEMENT ARE APPROXIMATE. FOR CURB AND GUTTER REPLACEMENT, CONTRACTOR SHALL SLOPE FLOW LINE TO MAINTAIN POSITIVE DRAINAGE BETWEEN CONFORM POINTS.
- CONTRACTOR SHALL DOCUMENT ALL MANHOLE COVER AND BOX LOCATIONS PRIOR TO BEGINNING PAVING WORK, ALL COVERS MUST BE ADJACENT TO GRADE FOLLOWING PAVING.
- 5. UTILITY INFORMATION SHOWN ON PLANS IS BASED ON AVAILABLE RECORDS, INCLUDING THE CITY'S GIS DATA. UTILITY LOCATIONS WERE CORRELATED WITH VISIBLE UTILITY FEATURES. IT SHALL BE THE CONTRACTORS RESPONSIBILITY TO POSITIVELY LOCATE (POTHOLE) AND EXPOSE UNDERGROUND UTILITIES PRIOR TO CONSTRUCTION AND PROTECT THEM FROM DAMAGE.
- CONTRACTOR SHALL REPLACE LANDSCAPING IN KIND AND REESTABLISH IRRIGATION THAT IS DAMAGE DURING CONSTRUCTION.
- 7. PRESERVATION OF EXISTING MONUMENTS SHALL BE CONTRACTORS RESPONSIBILITY. CONTRACTOR SHALL NOTIFY ENGINEER OF ALL MONUMENTS THAT ARE DISTURBED BY CONSTRUCTION OPERATIONS. EXISTING MONUMENT COVERS SHALL BE ADJUSTED TO GRADE. MONUMENT WELLS INSTALLED BY THE CONTRACTOR SHALL CONFORM TO STD M-1.
- EXISTING WALKWAYS ADJACENT TO PROPOSED SIDEWALK OR CURB AND GUTTER IMPROVEMENTS SHALL BE RESET OR REPAVED TO CONFORM TO THE NEW CONSTRUCTION BY THE CONTRACTOR WHERE REQUESTED BY THE ENGINEER.

- UNLESS OTHERWISE SHOWN ON THE PLANS. PROPOSED SIDEWALK SHALL BE 5 FEET WIDE. MEASURED FROM FACE OF CURB AND SIDEWALK WIDTH TRANSITIONS SHALL OCCUR OVER 4 FEET
- TREES INDICATED FOR REMOVAL SHALL BE INSPECTED BY THE CITY DURING CONSTRUCTION TO DETERMINE IF PORTIONS OF THE ROOT SYSTEM CAN BE REMOVED TO ACCOMMODATE THE IMPROVEMENTS OR IF THE WHOLE TREE NEEDS TO BE REMOVED AND REPLACED.
- 11. PROPOSED CURB AND GUTTER SHALL CONFORM TO EXISTING AT LIMITS.
- 12. HOT MIX ASPHALT (HMA) SHALL CONFORM TO THE PROVISIONS IN SECTION 39, "HOT MIX ASPHALT," OF THE CALTRANS STANDARD SPECIFICATIONS. UNLESS STATED IN THE PROJECT SPECIFICATIONS OTHERWISE, THE HMA CONSTRUCTION SHALL BE STANDARD. THE BASE LAYER SHALL CONSIST OF A 3/4" AGGREGATE GRADATION AND THE SURFACE LAYER SHALL BE 1/2" AND THE HMA TYPE SHALL BE TYPE A. THE BINDER SHALL BE PG 64-10. CONTRACTOR SHALL TACK COAT ALL SURFACES TO RECEIVE HMA AND SHALL CONFORM TO THE CALTRANS. STANDARD SPECIFICATIONS SECTION 39, "HOT MIX ASPHALT".
- 13. SUBGRADE TO RECEIVE BASE, SUB-BASE OR ASPHALT CONCRETE SHALL HAVE THE VEGETATION REMOVED AND SHALL BE BLADED OR DISCED TO A DEPTH OF 6 INCHES. ALL ROCKS, HARD PAN OR OTHER UNSUITABLE SOLID MATERIAL OVER 2.5 INCHES IN DIMENSIONS SHALL BE REMOVED FROM THE JOB SITE. THE MATERIAL THAT HAS BEEN BLADED OR DISCED SHALL BE THOROUGHLY MIXED, WATERED AND ROLLED TO RELATIVE COMPACTION OF 95%. THE SURFACE OF THE COMPLETED SUBGRADE SHALL NOT VARY MORE THAN 0.05 FEET ABOVE OR BELOW THE PLANNED GRADE AT ANY POINT. NO AGGREGATE SUB-BASE, BASE OR ASPHALT CONCRETE SHALL BE PLACED ON THE SUBGRADE UNTIL IT HAS BEEN APPROVED BY THE ENGINEER. SEE CITY OF TURLOCK STANDARD SPECIFICATIONS, SECTION 12-4, TITLED "SUBGRADE".

VERTICAL CURB & GUTTER STATION OFFSET LABEL IS PLACED AT FACE OF CURB. THE FLOWLINE ELEVATION SHOWN SHALL BE THE GRADE 2-INCHES OUT AT FLOWLINE. SEE DETAIL B ON SHEET 117. LEGEND:

SPHALT PAVEMENT (TI=6.0) " HMA. FULL DEPTH AC OVER 8" RECOMPACTED SUBGRADE PREPARED PER SECTION 10.25 EARTHWORK IN THE TECHNICAL SPECIFICATIONS

ASPHALT PAVEMENT (TI=6.0 3.5" HMA OVER 5" CLASS 2 AGGREGATE BASE OVER RECOMPACTED SUBGRADE PREPARED PER SECTION

10.25 EARTHWORK IN THE TECHNICAL SPECIFICATIONS

3.5" PCC OVER 6" NATIVE MATERIAL PREPARED PER SECTION 10.22 EARTHWORK IN THE TECHNICAL SPECIFICATIONS

SEE SHEET 40


N BEECH STREET

5.5" PCC OVER 6" NATIVE MATERIAL PREPARED PER SECTION 10.22 EARTHWORK IN THE TECHNICAL SPECIFICATIONS

.5" GRIND AND OVERLAY TO RESTRIPE CROSSWALK


EXISTING CONCRETE TO REMAIN

TRUNCATED DOMES COMPLYING WITH

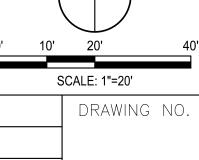




NOTE: ALL REFERENCES AND WRITTEN DIMENSIONS SHALL SUPERCEDE ALL SCALED DISTANCES AND SHALL BE VERIFIED IN THE FIELD. ANY DISCREPANCY SHALL BE BROUGHT TO THE ATTENTION OF THE ENGINEER PRIOR TO THE COMMENCEMENT OF WORK

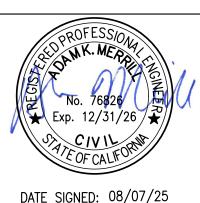



Stockton ,California 95219 STRUCTURAL PLANNING LANDSCAPE ATHLETIC ARCHITECTURE FACILITY DESIGN www.siegfriedeng.com

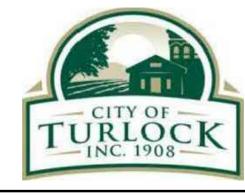


CITY OF TURLOCK MUNICIPAL SERVICES DEPARTMENT 156 S. BROADWAY, SUITE 150 (209) 668 - 5520

IMPROVEMENTS PLAN - FLORENCE STREET I

PROJECT NO. 23-069 CITY OF TURLOCK ROADS PROGRAM

CBC 11B-705. VERIFY SCALE DRAWN BY: JR REV. BY: AKM CH. BY: AKM DATE: 8/7/2025 SCALE: SEE SHEET SHEET SEI PROJ NO: 22157 31 OF 117

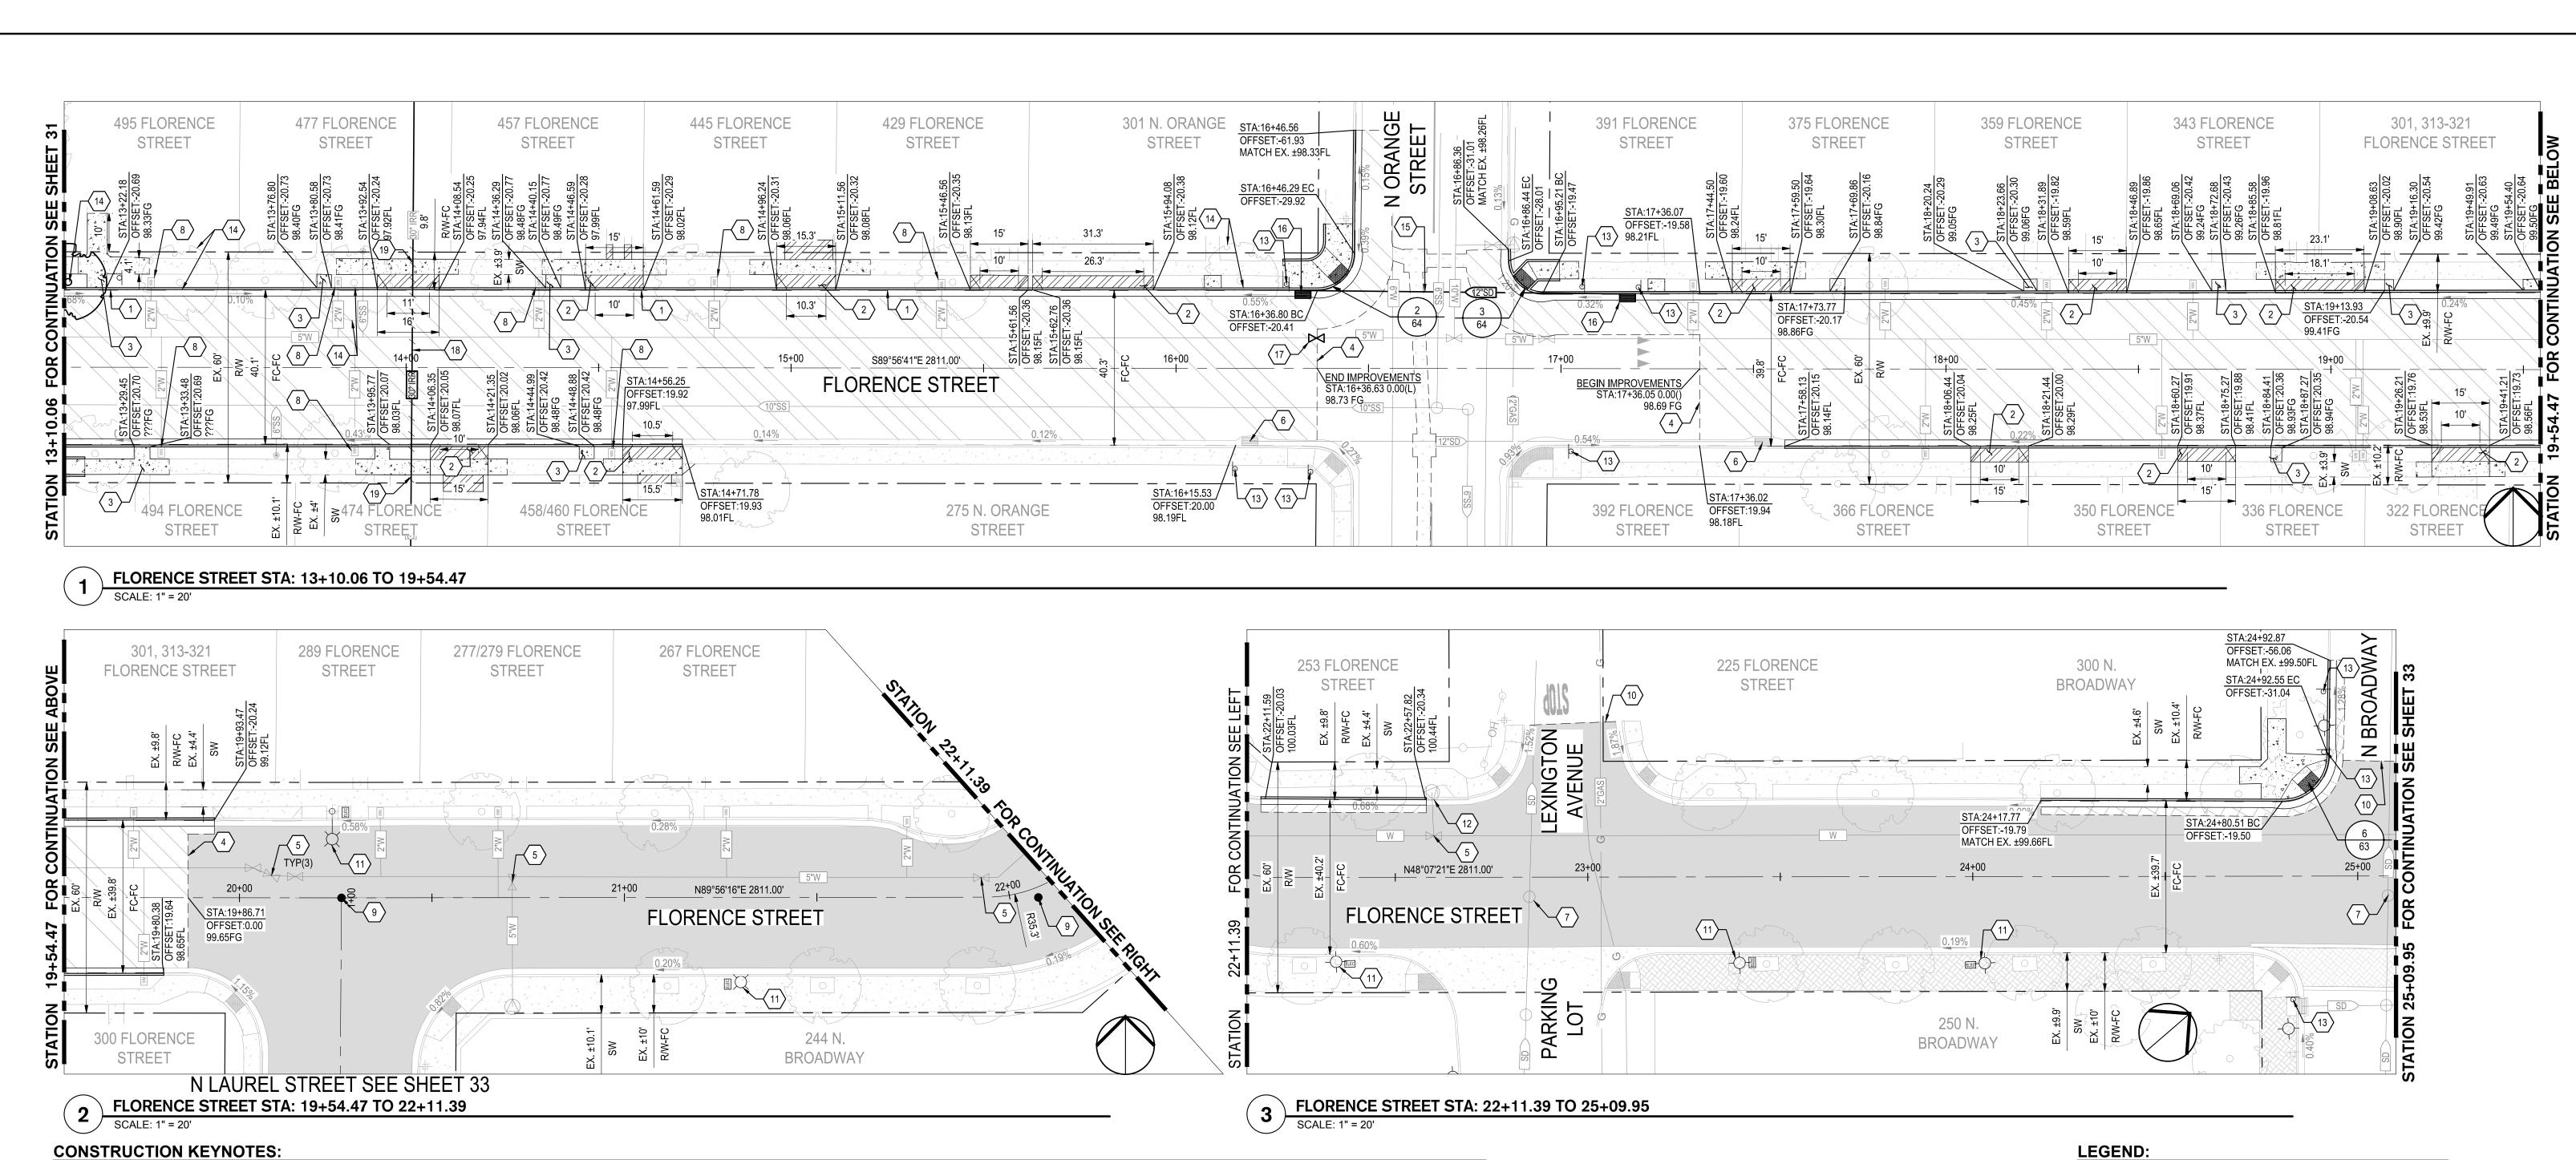

CONSTRUCTION KEYNOTES:

- REMOVE AND RECONSTRUCT CONCRETE CURB & GUTTER PER CITY OF TURLOCK STD. C-1
- REMOVE AND RECONSTRUCT CONCRETE DRIVEWAY APPROACH PER CITY OF TURLOCK STD. C-5
- REMOVE AND RECONSTRUCT SIDEWALK PER CITY OF TURLOCK STD. C-3
- CONFORM TO EXISTING PAVEMENT. SEE DETAIL 2 ON SHEET 115.
- REMAIN IN PLACE EXISTING WATER VALVE
- REMAIN IN PLACE EXISTING STORM DRAIN INLET
- REMAIN IN PLACE EXISTING STORM DRAIN MANHOLE
- REMAIN IN PLACE EXISTING WATER METER
- REMOVE AND RESET SURVEY MONUMENT. CONTRACTOR SHALL NOTIFY ENGINEER OF ALL MONUMENTS THAT ARE TO BE RESET DUE TO CONSTRUCTION OPERATIONS.

- \$\langle 10 \rangle SLURRY SEAL LIMITS
- (11) REMAIN IN PLACE EXISTING STREET LIGHT
- REMAIN IN PLACE EXISTING FIRE HYDRANT
- INSTALL SIGN PANEL AND POST. SEE SIGNING AND STRIPING PLANS FOR MORE DETAILS.
- REMOVE COMPLETELY EXISTING TREE PER ARBORIST REVIEW. CONTRACTOR SHALL REMOVE STUMP & ROOTS AND GRIND AS NEEDED PRIOR TO IMPROVEMENTS.
- PLUG AND ABANDON EXISTING STORM DRAIN PIPE. CONTRACTOR SHALL ABANDON AND PLUG EXISTING STORM PIPE IN PLACE WITH 3 FEET OF CONCRETE AT END. CONTRACTOR SHALL MAKE WATER-TIGHT THE ABANDONED SECTION.
- REMOVE AND DISPOSE EXISTING STORM DRAIN INLET. CONTRACTOR SHALL ABANDON AND PLUG EXISTING STORM PIPE IN PLACE WITH 3 FEET OF
- CONCRETE AT END. CONTRACTOR SHALL MAKE WATER-TIGHT THE ABANDONED SECTION. FOR PROPOSED STORM DRAIN INLET SEE UTILITY PLANS FOR MORE DETAILS. REMOVAL OF EXISTING INLET SHALL ACCOMMODATE PROPOSED IMPROVEMENTS.
- REPLACE EXISTING WATER VALVE BOX. SET TO NEW PAVEMENT GRADE. SEE CITY OF TURLOCK WATER VALVE BOX DETAIL STD. W-6

REMOVE AND DISPOSE ±60 LF OF THE 30" POUR IN PLACE IRRIGATION PIPE. CONTRACTOR SHALL CONCRETE PLUG ENDS AT RIGHT OF WAY AND BACKFILL PER CITY OF TURLOCK STD. T-1.

NOTE:

FOR LAYOUT NOTES, REFER TO SHEET 31

ASPHALT PAVEMENT (TI=6.0) 3.5" HMA OVER 5" CLASS 2 AGGREGATE BASE OVER RECOMPACTED SUBGRADE PREPARED PER SECTION 10.25 EARTHWORK IN THE TECHNICAL SPECIFICATIONS

SLURRY SEAL
CONTRACTOR SHALL CLEAN AND SEAL ALL CRACKS PRIOR TO SLURRY SEAL AND


STORM DRAIN TRENCH EXCAVATION AND BACKFILL PER CITY OF TURLOCK DETAIL T-1.

SIDEWALK CONCRETE
3.5" PCC OVER 6" NATIVE MATERIAL PREPARED PER SECTION 10.22 EARTHWORK IN THE TECHNICAL SPECIFICATIONS

<u>DRIVEWAY CONCRETE</u>
5.5" PCC OVER 6" NATIVE MATERIAL PREPARED PER SECTION 10.22 EARTHWORK IN THE TECHNICAL SPECIFICATIONS


EXISTING CONCRETE TO REMAIN

TRUNCATED DOMES TRUNCATED DOMES COMPLYING WITH CBC 11B-705.

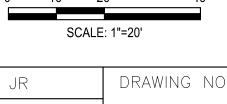




ALL REFERENCES AND WRITTEN DIMENSIONS SHALL SUPERCEDE ALL SCALED DISTANCES AND SHALL BE VERIFIED IN THE FIELD. ANY DISCREPANCY SHALL BE BROUGHT TO THE ATTENTION OF THE ENGINEER PRIOR TO THE COMMENCEMENT OF WORK

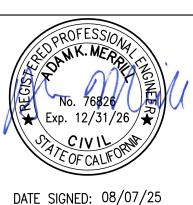




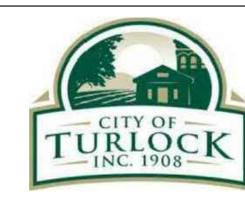


CITY OF TURLOCK MUNICIPAL SERVICES DEPARTMENT 156 S. BROADWAY, SUITE 150 (209) 668 - 5520

IMPROVEMENTS PLAN - FLORENCE STREET II

VERIFY SCALE	DRAWN BY: JR	DRAWING NO.
0 1"	REV. BY: AKM	
	CH. BY: AKM	32
	DATE: 8/7/2025	
	SCALE: SEE SHEET	SHEET:
	SEI PROJ NO: 22157	32 OF 117

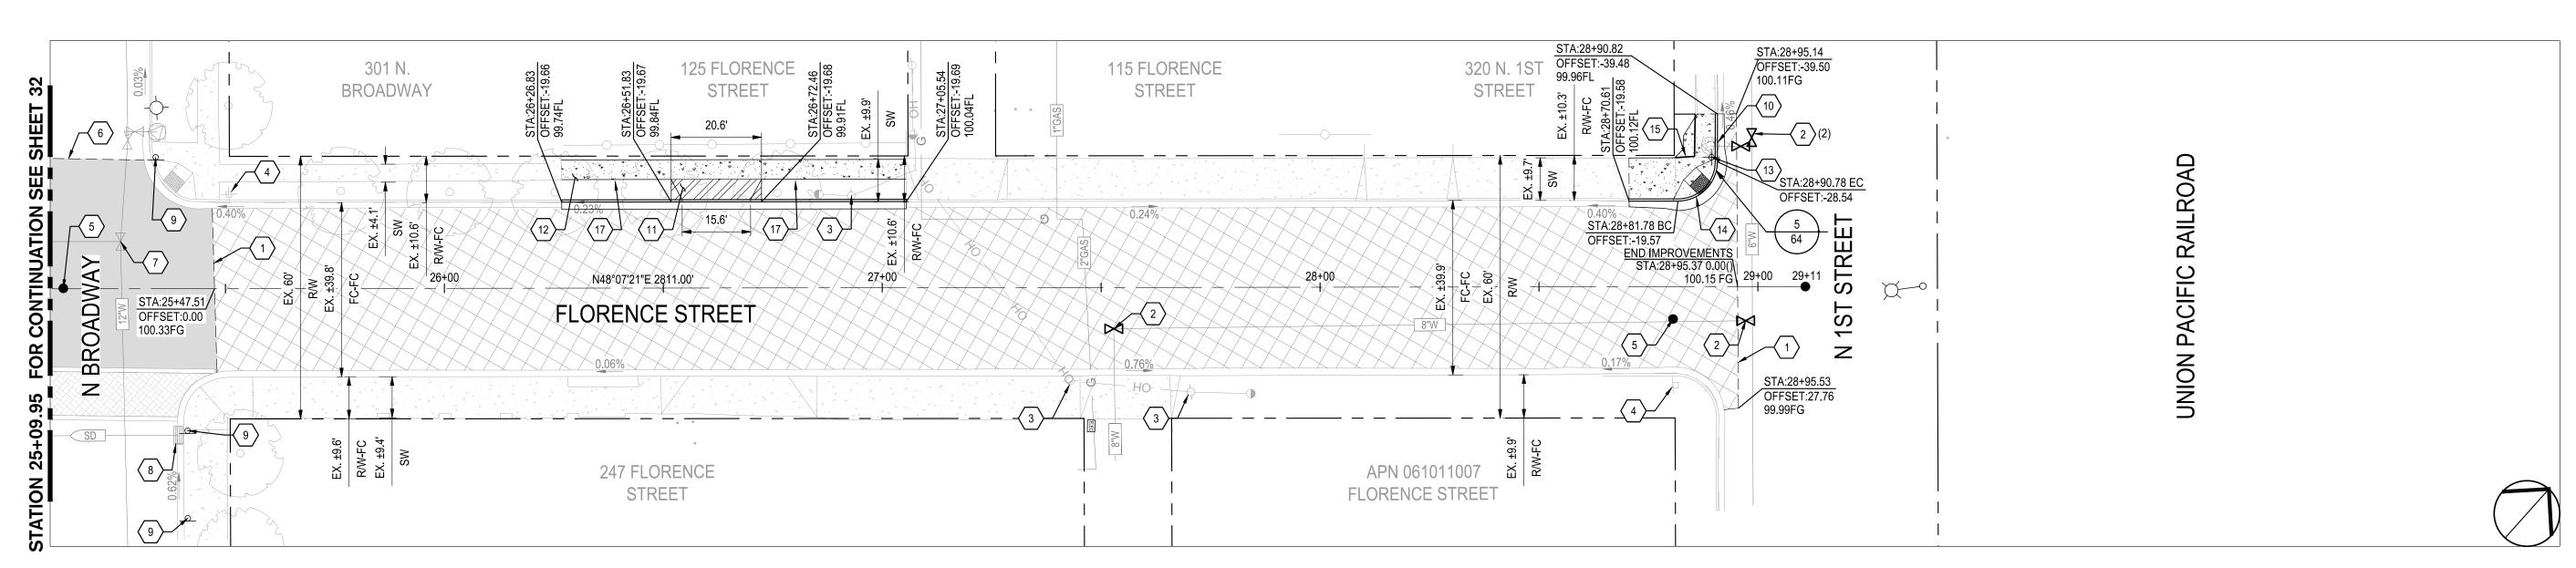

FLORENCE STREET STA: 25+09.95 TO END

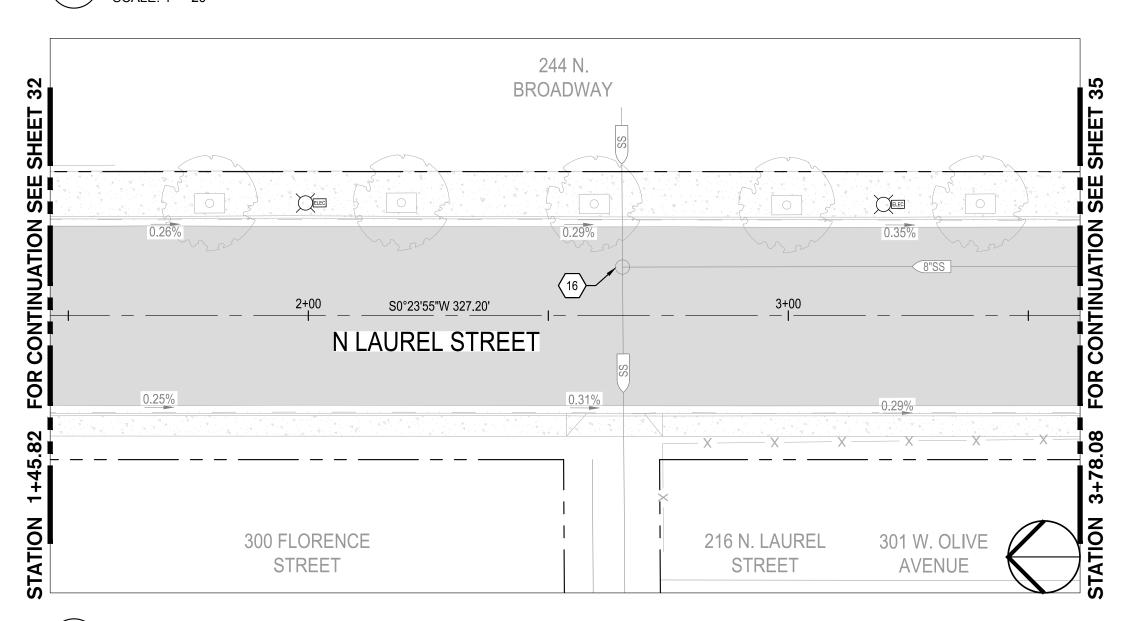

N. LAUREL STREET STA: 1+45.82 TO 3+60.80

SCALE: 1" = 20'

CONSTRUCTION KEYNOTES:

- CONFORM TO EXISTING PAVEMENT. SEE DETAIL 2 ON SHEET 115.
- REPLACE EXISTING WATER VALVE BOX. SET TO NEW PAVEMENT GRADE. SEE CITY OF TURLOCK WATER VALVE BOX DETAIL STD. W-6
- REMAIN IN PLACE EXISTING POWER POLE
- REMAIN IN PLACE EXISTING ROADSIDE SIGN AND POST
- REMOVE AND RESET SURVEY MONUMENT. CONTRACTOR SHALL NOTIFY ENGINEER OF ALL MONUMENTS THAT ARE TO BE RESET DUE TO CONSTRUCTION OPERATIONS.
- SLURRY SEAL LIMITS
- REMAIN IN PLACE EXISTING WATER VALVE
- REMAIN IN PLACE EXISTING STORM DRAIN INLET
- INSTALL SIGN PANEL AND POST. SEE SIGNING AND STRIPING PLANS FOR MORE DETAILS.
- REMAIN IN PLACE EXISTING FIRE HYDRANT


- REMOVE AND RECONSTRUCT CONCRETE DRIVEWAY APPROACH PER CITY OF TURLOCK STD. C-5
- REMOVE AND RECONSTRUCT SIDEWALK PER CITY OF TURLOCK STD. C-3
- RESET EXISTING SIGN PANEL AND POST. SEE SIGNING AND STRIPING PLAN FOR MORE DETAILS.
- REMOVE AND RECONSTRUCT CURB RAMP PER CITY OF TURLOCK STD. C-11
- REMOVE AND RELOCATE EXISTING CHAIN LINK FENCE
- (16) REMAIN IN PLACE EXISTING SANITARY SEWER MANHOLE
- SALVAGE AND RETURN LANDSCAPING AND BRICK TO PROPERTY OWNER.

NOTE:

FOR LAYOUT NOTES, REFER TO SHEET 31

Know what's **below. Call** before you dig.

ALL REFERENCES AND WRITTEN DIMENSIONS SHALL SUPERCEDE ALL SCALED DISTANCES AND SHALL BE VERIFIED IN THE FIELD. ANY DISCREPANCY SHALL BE BROUGHT TO THE ATTENTION OF THE ENGINEER PRIOR TO THE COMMENCEMENT OF WORK

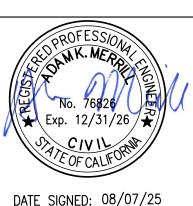





CITY OF TURLOCK MUNICIPAL SERVICES DEPARTMENT 156 S. BROADWAY, SUITE 150 (209) 668 - 5520

IMPROVEMENTS PLAN - FLORENCE STREET III

LEGEND:

PROJECT NO. 23-069 CITY OF TURLOCK ROADS PROGRAM

	SCALE	i: 1"=20'
VERIFY SCALE	DRAWN BY: JR	DRAWING NO
0 1"	REV. BY: AKM	
	CH. BY: AKM	33
	DATE: 8/7/2025	
	SCALE: SEE SHEET	SHEET:
	SEI PROJ NO: 22157	33 OF 11

ASPHALT PAVEMENT (TI=7.0) 6.5" HMA. FULL DEPTH AC OVER 8" RECOMPACTED SUBGRADE PREPARED PER SECTION 10.25 EARTHWORK IN THE TECHNICAL SPECIFICATIONS


IN THE TECHNICAL SPECIFICATIONS


EXISTING CONCRETE TO REMAIN

TRUNCATED DOMES TRUNCATED DOMES COMPLYING WITH CBC 11B-705.

SLURRY SEAL
CONTRACTOR SHALL CLEAN AND SEAL ALL CRACKS PRIOR TO SLURRY SEAL AND

SIDEWALK CONCRETE
3.5" PCC OVER 6" NATIVE MATERIAL PREPARED PER SECTION 10.22 EARTHWORK IN THE TECHNICAL SPECIFICATIONS <u>DRIVEWAY CONCRETE</u>
5.5" PCC OVER 6" NATIVE MATERIAL PREPARED PER SECTION 10.22 EARTHWORK

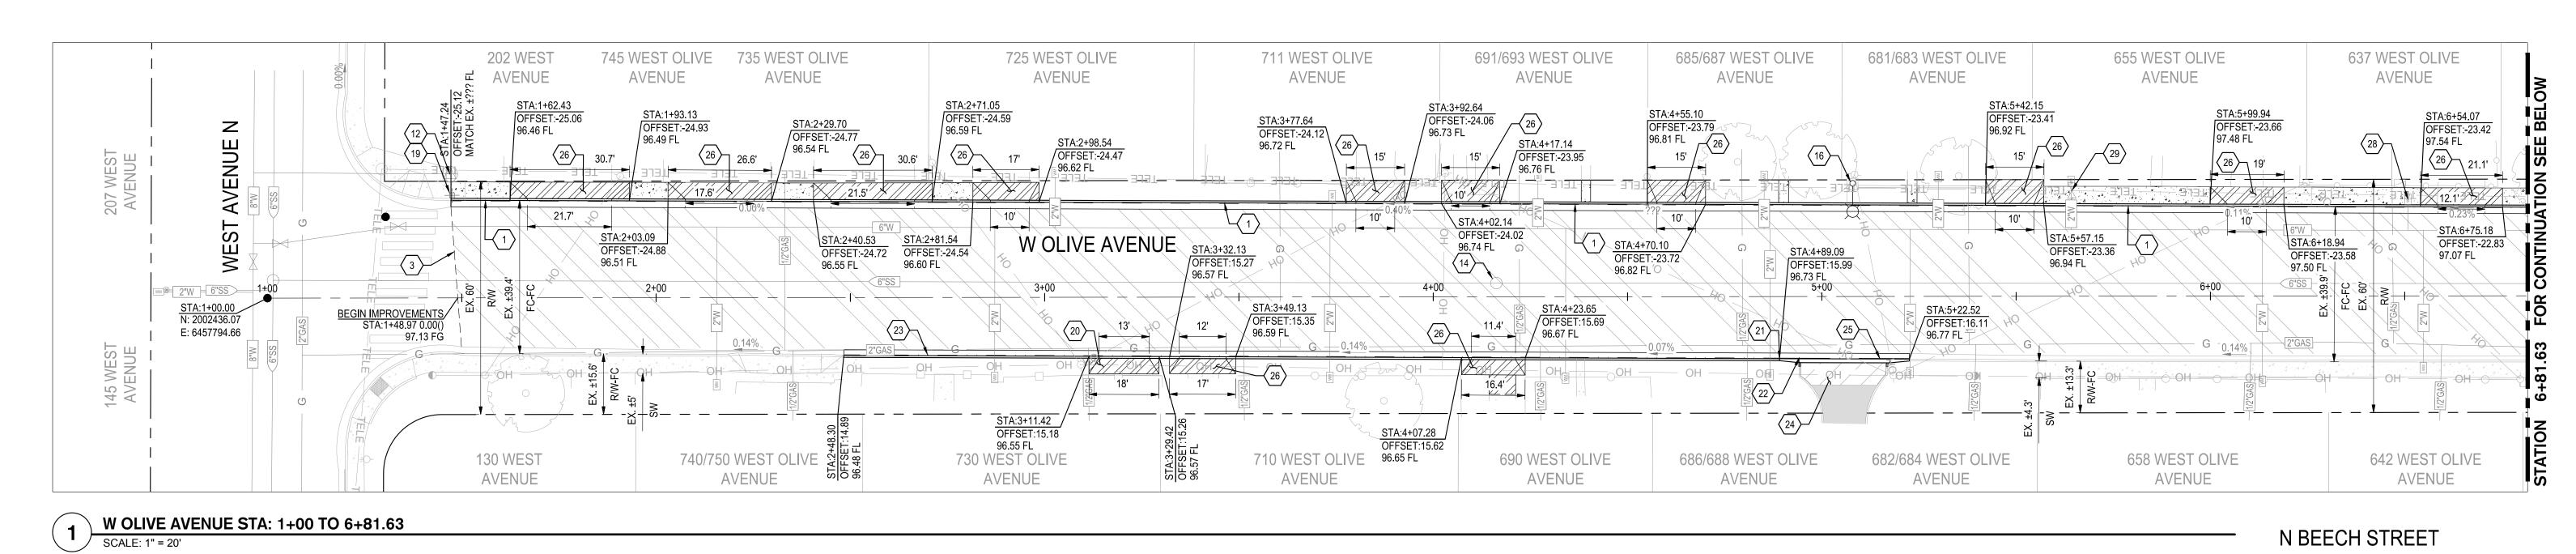

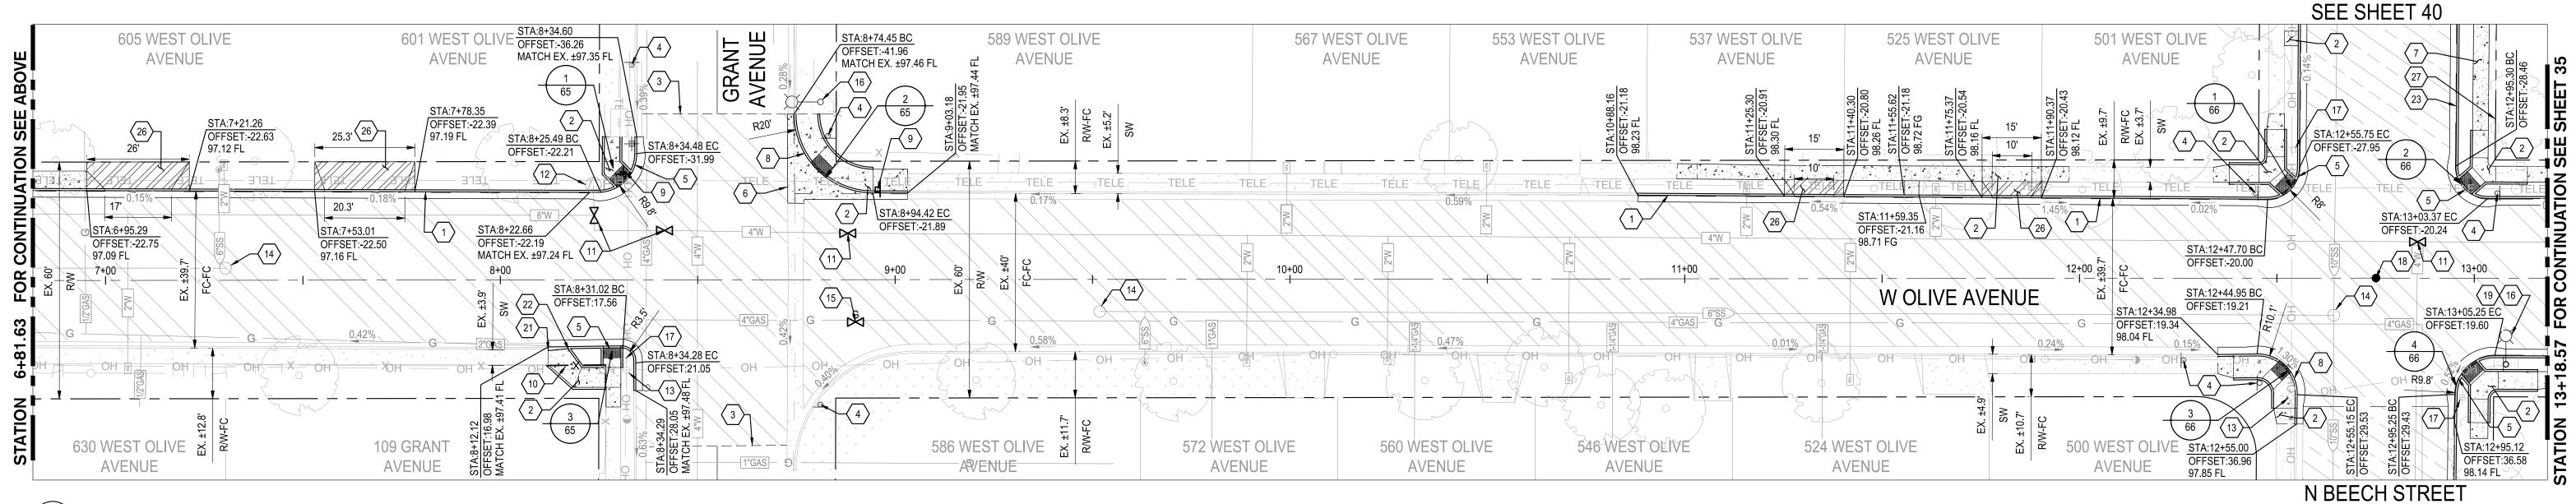

2 W OLIVE AVENUE STA: 6+81.63 TO 13+18.57

CONSTRUCTION KEYNOTES:

- REMOVE AND RECONSTRUCT CONCRETE CURB & GUTTER PER CITY OF TURLOCK STD. C-1
- REMOVE AND RECONSTRUCT SIDEWALK PER CITY OF TURLOCK STD. C-3
- CONFORM TO EXISITING PAVEMENT. SEE DETAIL 2 ON SHEET 115
- INSTALL SIGN PANEL AND POST. SEE SIGNING AND STRIPING PLANS FOR MORE
- REMOVE EXISTING CONCRETE AND CONSTRUCT MODIFIED CASE F CURB RAMP PER CALTRANS STD. A88A.
- 6 REMOVE AND RECONSTRUCT VALLEY GUTTER PER CITY OF TURLOCK STD. C-1
- 7 CONSTRUCT SIDEWALK PER CITY OF TURLOCK STD. C-3
- 8 REMOVE AND RECONSTRUCT CURB RAMP PER CITY OF TURLOCK STD. C-12
- REMOVE AND RELOCATE ROADSIDE SIGN AND POST. SEE STRIPING PLAN FOR MORE
- (10) REMOVE AND RELOCATE ± 22 LF OF EXISTING WOOD FENCE OUTSIDE OF IMPROVEMENTS
- REPLACE EXISTING WATER VALVE BOX. SET TO NEW PAVEMENT GRADE.
 SEE CITY OF TURLOCK WATER VALVE BOX DETAIL STD. W-6
- 12 REMAIN IN PLACE EXISTING FIRE HYDRANT
- TIS REMAIN IN PLACE EXISTING POWER POLE

- (14) ADJUST EXISTING SANITARY SEWER MANHOLE TO GRADE
- 15 ADJUST EXISTING NATURAL GAS VALVE TO GRADE
- (16) REMAIN IN PLACE EXISTING STREET LIGHT
- 17 REMAIN IN PLACE EXISTING ROADSIDE SIGN AND POST
- REMOVE AND RESET SURVEY MONUMENT.
 CONTRACTOR SHALL NOTIFY ENGINEER OF ALL MONUMENTS THAT ARE TO BE RESET DUE TO CONSTRUCTION OPERATIONS.
- INSTALL SIGN PANEL ON EXISTING STREET LIGHT. SEE STRIPING PLANS FOR MORE
- (20) CONSTRUCT CONCRETE DRIVEWAY APPROACH PER CITY OF TURLOCK STD. C-5
- 21 BEGIN TRANSITION FOR CONCRETE ROLLED CURB PER DETAIL 5 ON SHEET 115
- (22) END TRANSITION FOR CONCRETE ROLLED CURB PER DETAIL 5 ON SHEET 115
- CONSTRUCT CURB & GUTTER PER CITY OF TURLOCK STD. C-1
- REMOVE AND REINSTALL ASPHALT CONCRETE PER LEGEND, THIS SHEET

LANDSCAPE ATHLETIC FACILITY DESIGN

- REMOVE CURB & GUTTER AND CONSTRUCT ROLLED CURB & GUTTER PER DETAIL 1
 ON SHEET 115
- REMOVE AND RECONSTRUCT CONCRETE DRIVEWAY APPROACH PER CITY OF TURLOCK STD. C-5
- 27 REMAIN IN PLACE WROUGHT IRON FENCE
- 28 ADJUST EXISTING WATER METER TO GRADE
- ADJUST EXISTING WATER VALVE TO GRADE

NOTE:FOR LAYOUT NOTES, REFER TO SHEET 31

LEGEND:

ASPHALT PAVEMENT (TI=6.0)
3.5" HMA OVER 5" CLASS 2 AGGREGATE BASE OVER
RECOMPACTED SUBGRADE PREPARED PER SECTION
10.25 EARTHWORK IN THE TECHNICAL SPECIFICATIONS

SIDEWALK CONCRETE

3.5" PCC OVER 6" NATIVE MATERIAL PREPARED PER SECTION 10.22 EARTHWORK IN THE TECHNICAL SPECIFICATIONS


DRIVEWAY CONCRETE

5.5" PCC OVER 6" NATIVE MATERIAL PREPARED PER SECTION 10.22 EARTHWORK
IN THE TECHNICAL SPECIFICATIONS

SEE SHEET 40


EXISTING CONCRETE TO REMAIN

TRUNCATED DOMES
TRUNCATED DOMES COMPLYING WITH CBC 11B-705.

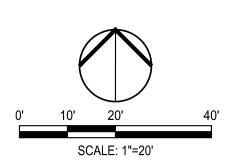



NOTE:
ALL REFERENCES AND WRITTEN
DIMENSIONS SHALL SUPERCEDE
ALL SCALED DISTANCES AND
SHALL BE VERIFIED IN THE
FIELD. ANY DISCREPANCY
SHALL BE BROUGHT TO THE
ATTENTION OF THE ENGINEER
PRIOR TO THE COMMENCEMENT
OF WORK

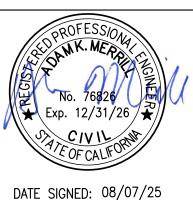




www.siegfriedeng.com




CITY OF TURLOCK
MUNICIPAL SERVICES DEPARTMENT
156 S. BROADWAY,
SUITE 150
(209) 668-5520

IMPROVEMENTS PLAN - W OLIVE AVE I

VERIFY SCALE	DRAWN BY: JR	DRAWING NO.
0 1"	REV. BY: AKM	
	CH. BY: AKM	34
	DATE: 8/7/2025	
	SCALE: SEE SHEET	SHEET:
	SEI PROJ NO: 22157	34 OF 117

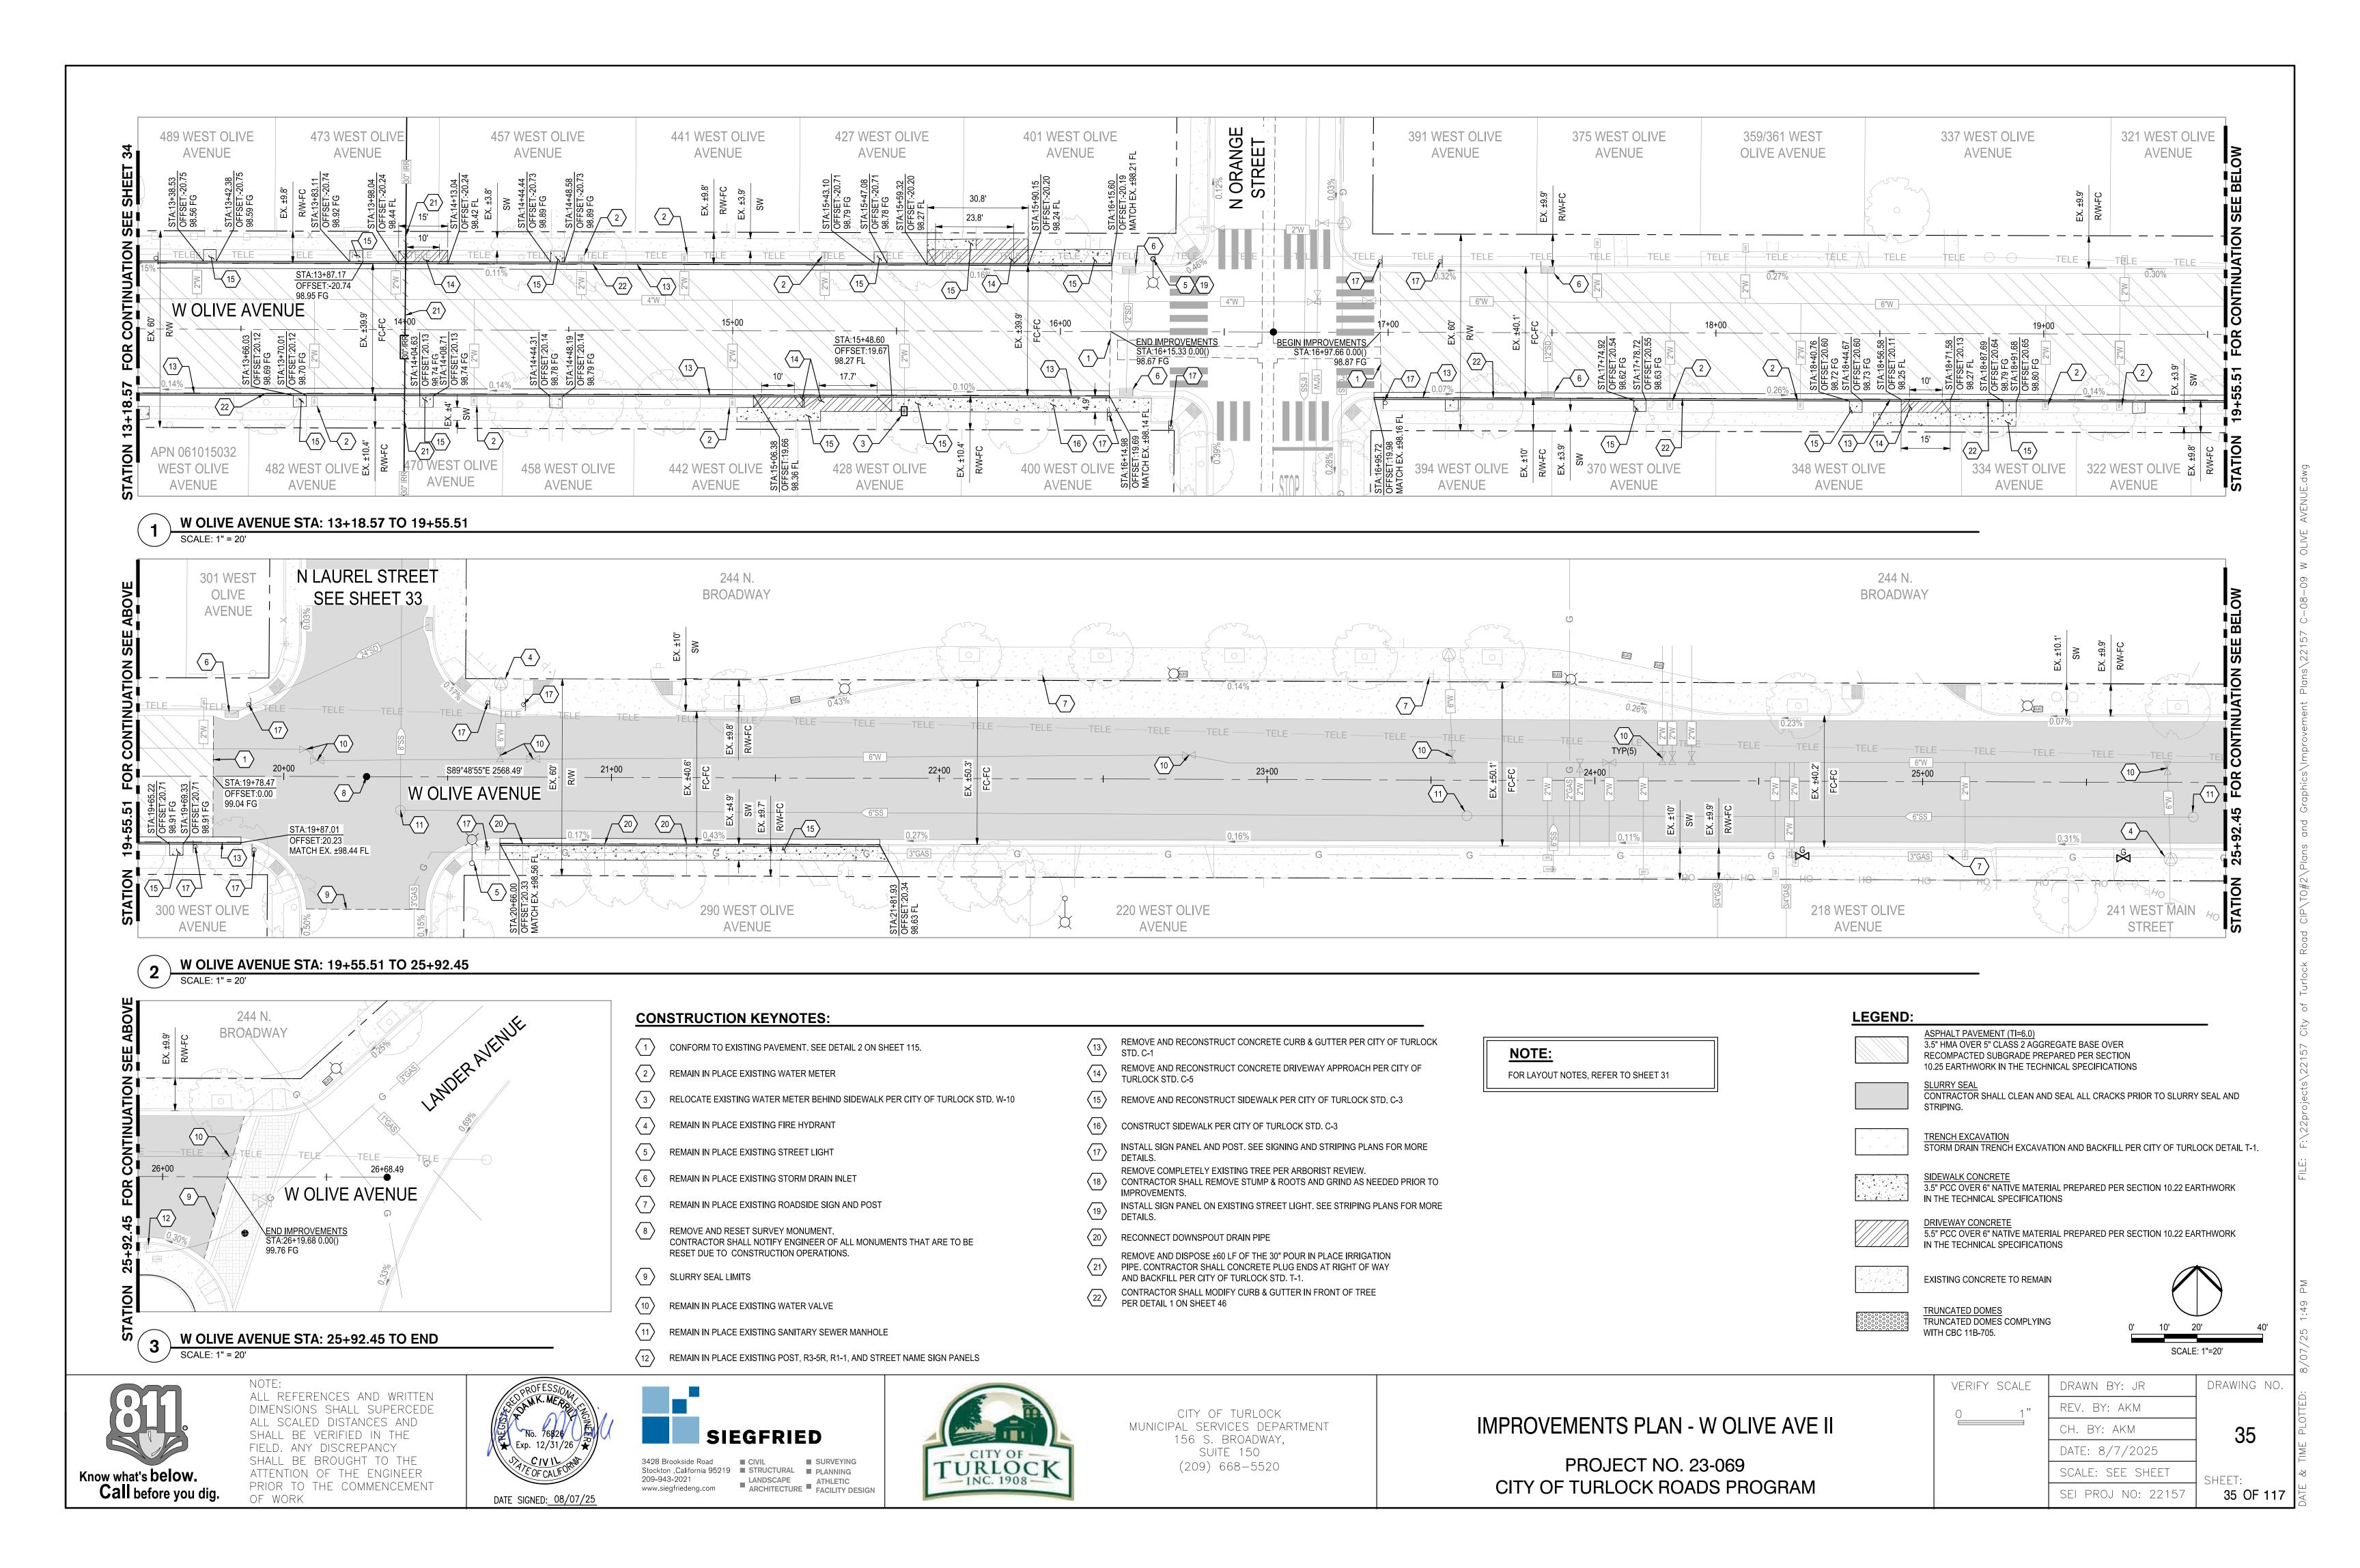

ANGELUS STREET STA: 1+00 TO 6+90.22

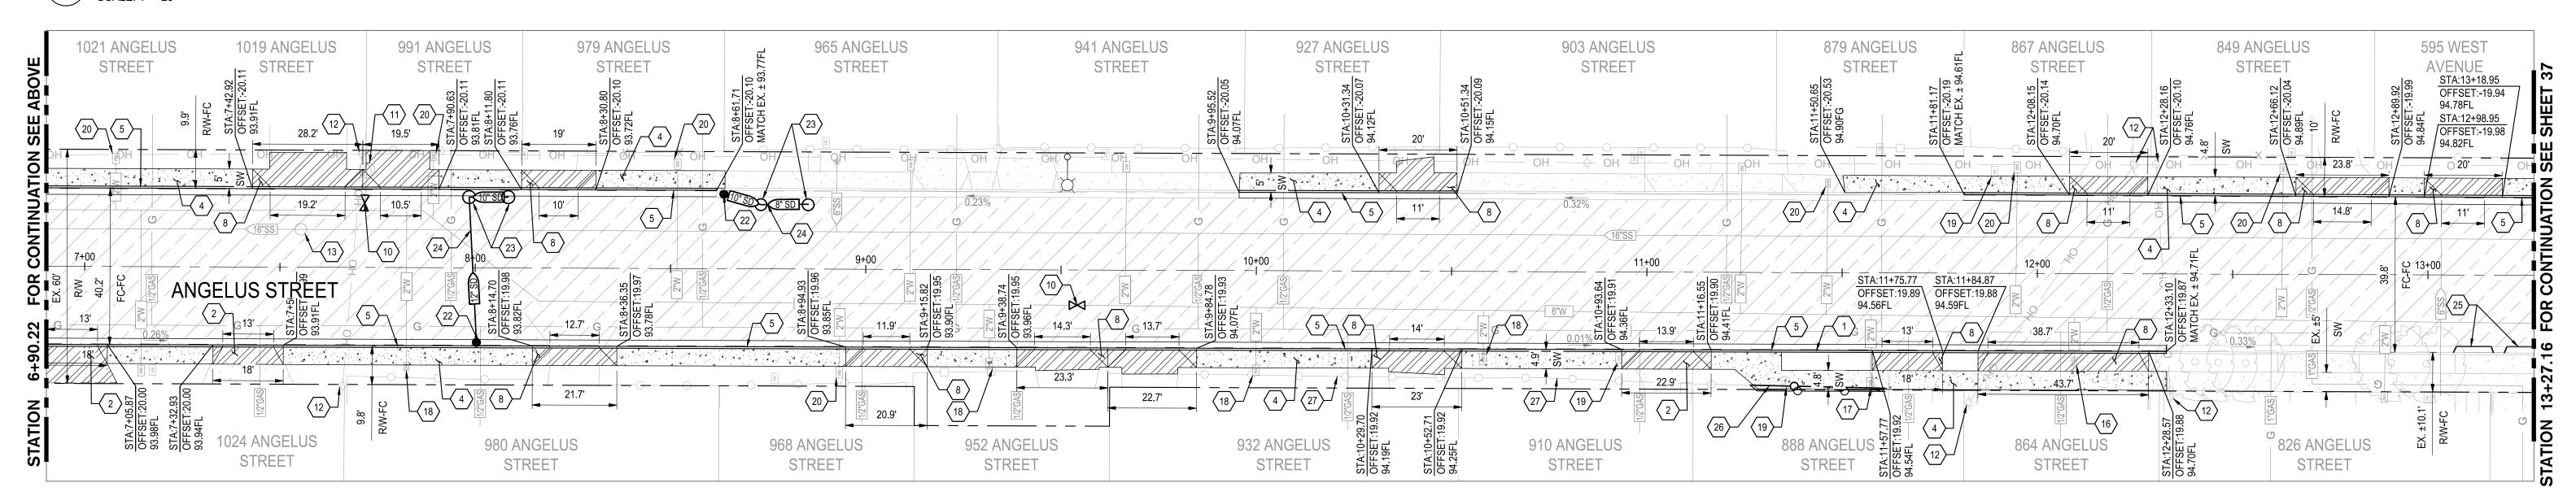

ANGELUS STREET STA: 6+90.22 TO 13+27.16 SCALE: 1" = 20'

CONSTRUCTION KEYNOTES:

- REMOVE AND RECONSTRUCT CONCRETE CURB & GUTTER PER CITY OF TURLOCK STD. C-1
- REMOVE AND RECONSTRUCT CONCRETE DRIVEWAY APPROACH PER CITY OF TURLOCK STD. C-5
- REMOVE AND RECONSTRUCT SIDEWALK PER CITY OF TURLOCK STD. C-3
- CONSTRUCT SIDEWALK PER CITY OF TURLOCK STD. C-3
- CONSTRUCT CURB AND GUTTER PER CITY OF TURLOCK STD. C-1
- CONFORM TO EXISTING PAVEMENT. SEE DETAIL 2 ON SHEET 115.
- REMOVE AND RECONSTRUCT CURB RAMP PER CITY OF TURLOCK STD. C-10
- CONSTRUCT CONCRETE DRIVEWAY APPROACH PER CITY OF TURLOCK STD. C-5
- REMOVE AND RECONSTRUCT CURB RAMP PER CITY OF TURLOCK STD. C-12
- REPLACE EXISTING WATER VALVE BOX. SET TO NEW GRADE. SEE CITY OF TURLOCK WATER VALVE BOX DETAIL STD. W-6.
- REMOVE AND REPLACE FIRE HYDRANT PER CITY OF TURLOCK STD. W-1
- REMAIN IN PLACE EXISTING POWER POLE
- ADJUST EXISTING SANITARY SEWER MANHOLE TO GRADE

- (14) REMAIN IN PLACE EXISTING STREET LIGHT
- (15) REMAIN IN PLACE EXISTING ROADSIDE SIGN AND POST
- REPLACE EXISTING WATER METER BOX AND LID WITH H-20 TRAFFIC RATED BOX AND
- RELOCATE EXISTING WATER METER BEHIND CURB AND REPLACE BOX AND LID WITH
- H-20 TRAFFIC RATED BOX AND LID PER CITY OF TURLOCK STD. RELOCATE EXISTING WATER METER BEHIND SIDEWALK PER CITY OF TURLOCK STD.
- RELOCATE EXISTING MAILBOX OUTSIDE IMPROVEMENTS
- REMAIN IN PLACE EXISTING WATER METER
- REMOVE AND RESET SURVEY MONUMENT. CONTRACTOR SHALL NOTIFY ENGINEER OF ALL MONUMENTS THAT ARE TO BE RESET DUE TO CONSTRUCTION OPERATIONS.
- PLUG AND ABANDON EXISTING OF DRY WELL

www.siegfriedeng.com

- PLUG AND ABANDON EXISTING STORM DRAIN MANHOLE
- 24 PLUG AND ABANDON EXISTING STORM DRAIN PIPE

REMOVE AND DISPOSE CONCRETE BLOCKAGE IN EXISTING GUTTER

- REMOVE AND RELOCATE ±35 TO ±40 LF OF EXISTING CHAIN LINK FENCE OUTSIDE OF
- REMAIN IN PLACE EXISTING CHAIN LINK FENCE

PLUG AND ABANDON IN PLACE EXISTING STORM DRYWELL. CONTRACTOR SHALL DEMOLISH

THE TOP 3', FILL WITH SAND, SHALL MAKE WATER-TIGHT, COVER WITH COMPACTED AGGREGATE BASE, MATCH THE ADJACENT SUBGRADE AND PAVEMENT STRUCTURAL

NOTE:

FOR LAYOUT NOTES, REFER TO SHEET 31

LEGEND:

5" HMA. FULL DEPTH AC OVER 8" RECOMPACTED SUBGRADE PREPARED PER SECTION 10.25 EARTHWORK IN THE TECHNICAL SPECIFICATIONS


SIDEWALK CONCRETE
3.5" PCC OVER 6" NATIVE MATERIAL PREPARED PER SECTION 10.22 EARTHWORK IN THE TECHNICAL SPECIFICATIONS


<u>DRIVEWAY CONCRETE</u>
5.5" PCC OVER 6" NATIVE MATERIAL PREPARED PER SECTION 10.22 EARTHWORK

EXISTING CONCRETE TO REMAIN

IN THE TECHNICAL SPECIFICATIONS

TRUNCATED DOMES TRUNCATED DOMES COMPLYING WITH CBC 11B-705.

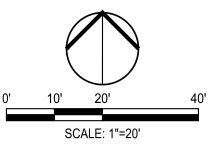

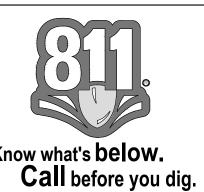

ALL REFERENCES AND WRITTEN DIMENSIONS SHALL SUPERCEDE ALL SCALED DISTANCES AND SHALL BE VERIFIED IN THE FIELD. ANY DISCREPANCY SHALL BE BROUGHT TO THE ATTENTION OF THE ENGINEER PRIOR TO THE COMMENCEMENT OF WORK



DATE SIGNED: 08/07/25



LANDSCAPE ATHLETIC FACILITY DESIGN



SECTION. (TYP)


CITY OF TURLOCK MUNICIPAL SERVICES DEPARTMENT 156 S. BROADWAY, SUITE 150 (209) 668 - 5520

IMPROVEMENTS PLAN - ANGELUS STREET I

PROJECT NO. 23-069 CITY OF TURLOCK ROADS PROGRAM

RIFY SCALE	DRAWN BY: JR	DRAWING NO
1 "	REV. BY: AKM	
	CH. BY: AKM	36
	DATE: 8/7/2025	
	SCALE: SEE SHEET	SHEET:
	SEI PROJ NO: 22157	36 OF 11

Know what's below.

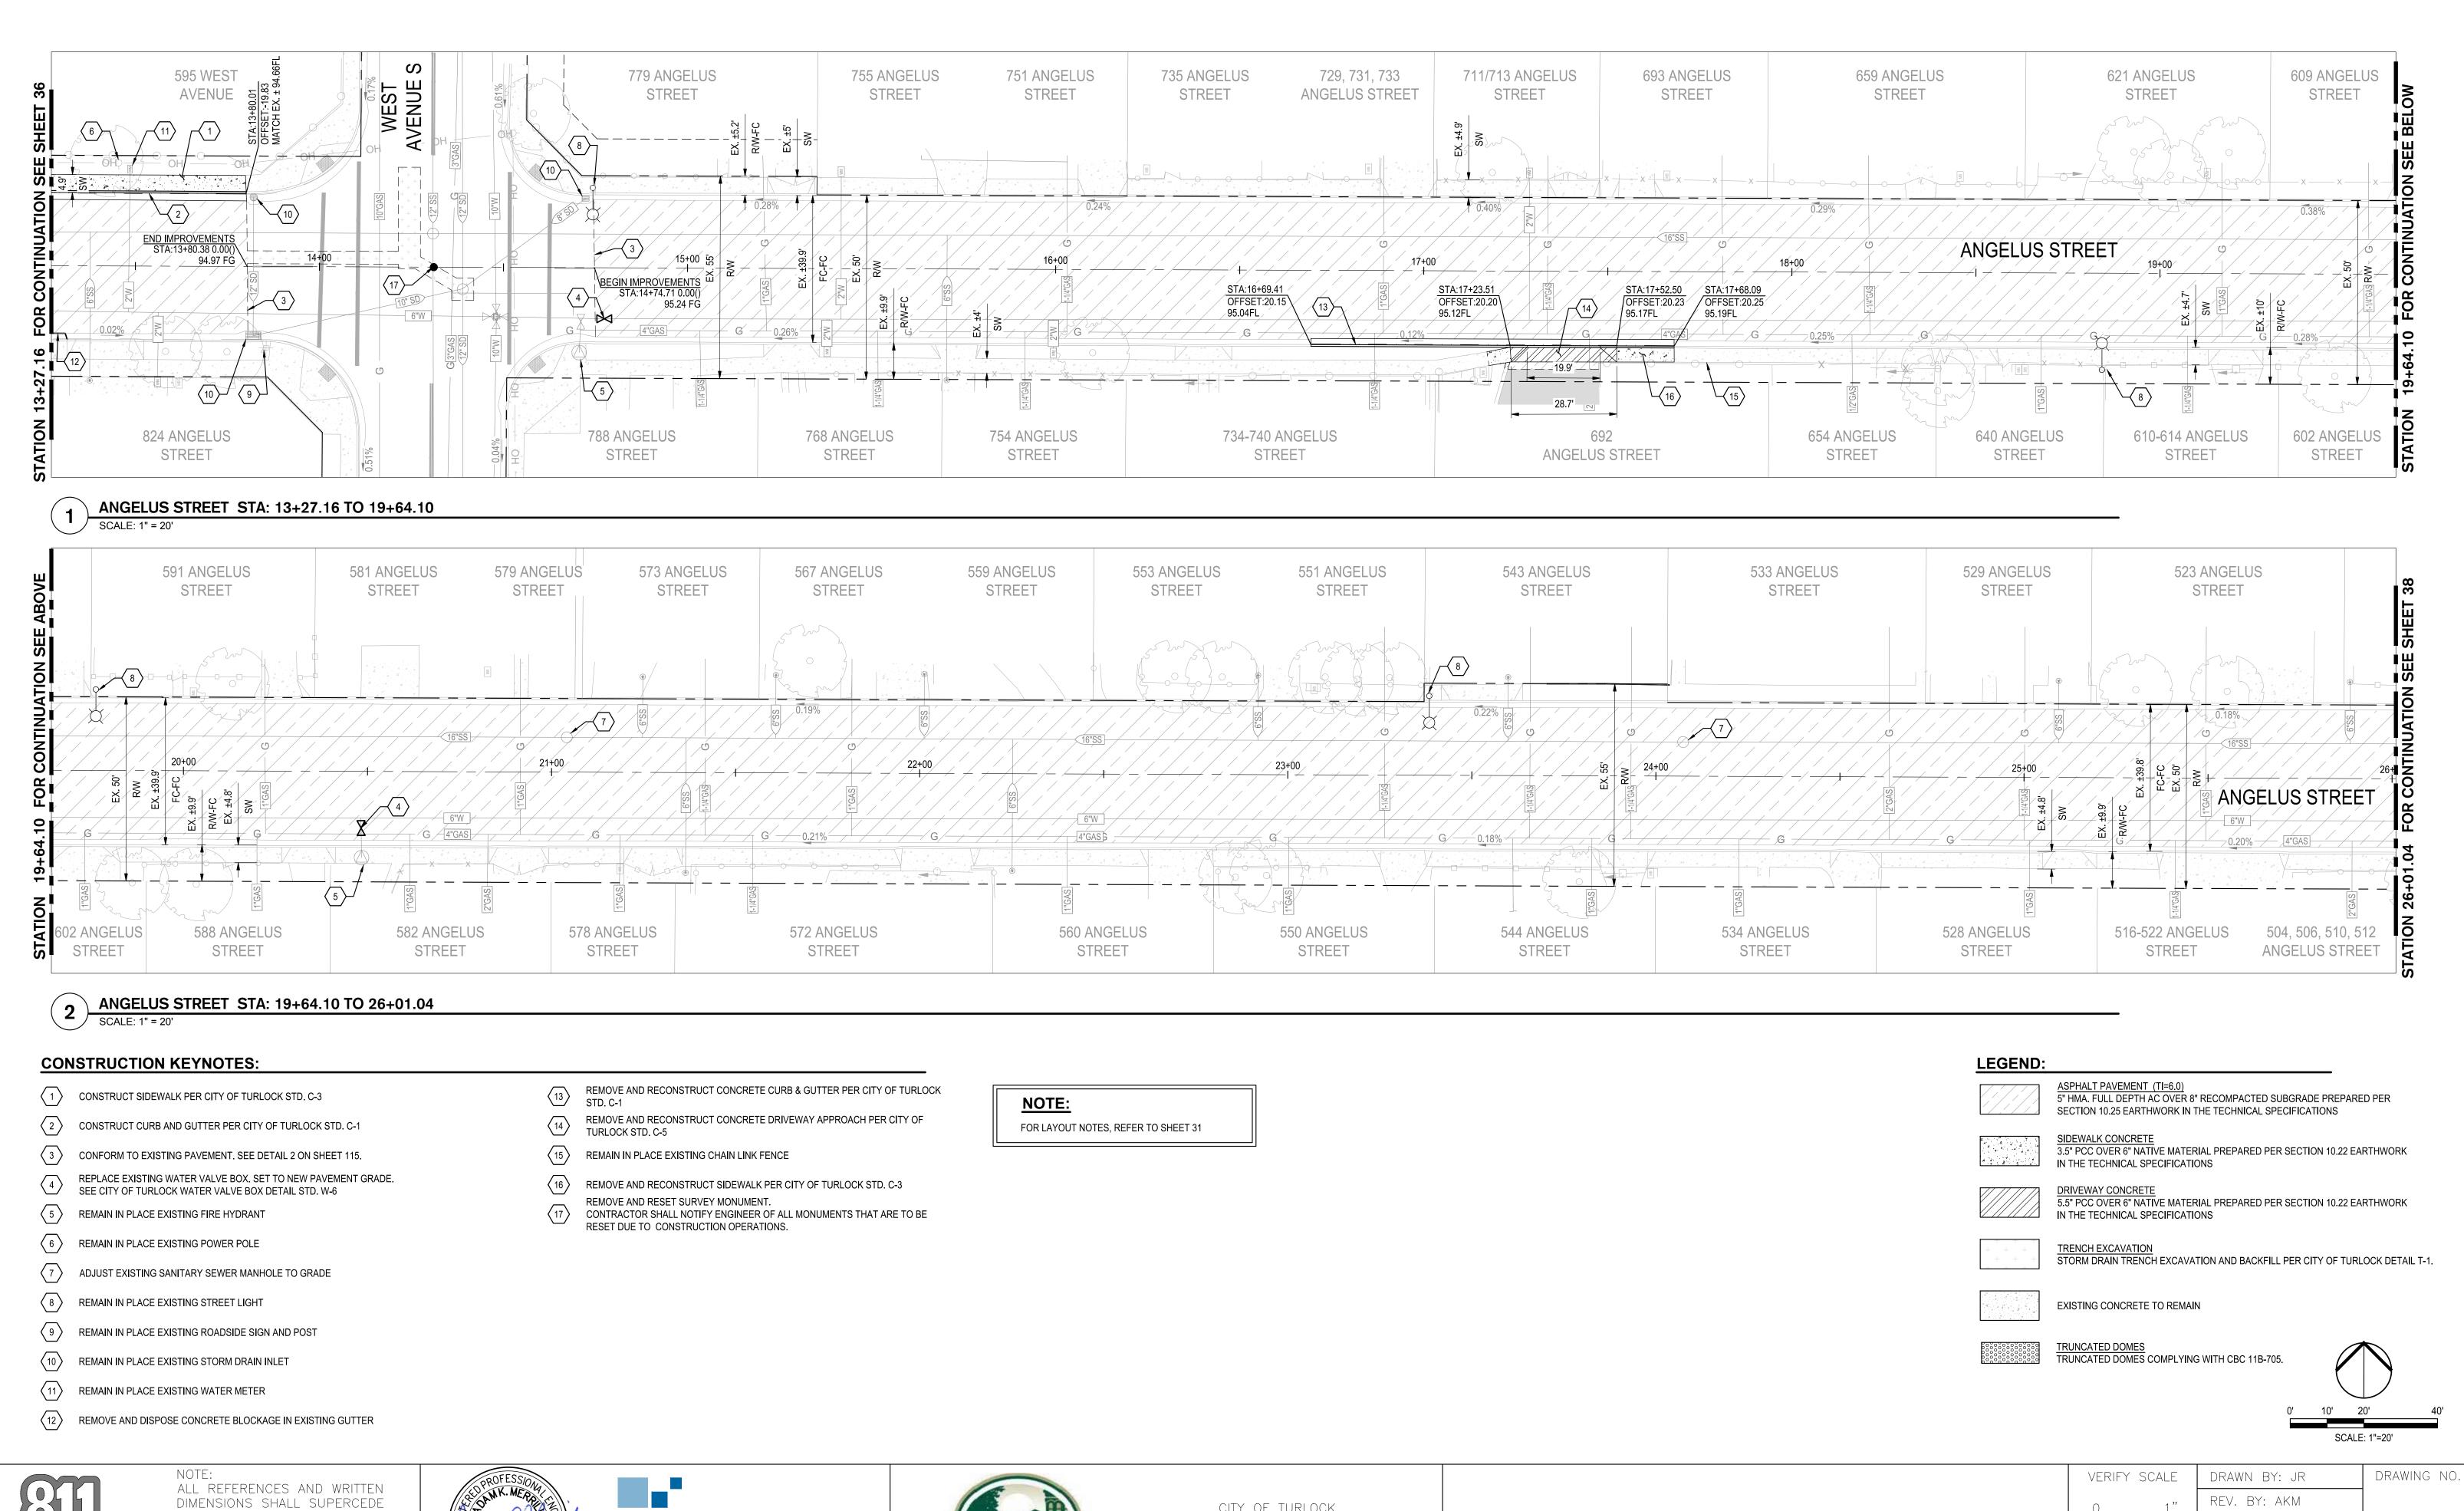




ALL SCALED DISTANCES AND SHALL BE VERIFIED IN THE FIELD. ANY DISCREPANCY SHALL BE BROUGHT TO THE ATTENTION OF THE ENGINEER PRIOR TO THE COMMENCEMENT OF WORK





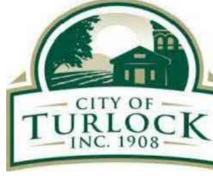


CITY OF TURLOCK MUNICIPAL SERVICES DEPARTMENT 156 S. BROADWAY, SUITE 150 (209) 668 - 5520

IMPROVEMENTS PLAN - ANGELUS STREET II PROJECT NO. 23-069

CH. BY: AKM DATE: 8/7/2025 SCALE: SEE SHEET SHEET: SEI PROJ NO: 22157 37 OF 117

CITY OF TURLOCK ROADS PROGRAM

ANGELUS STREET STA: 26+01.04 TO 27+51.30

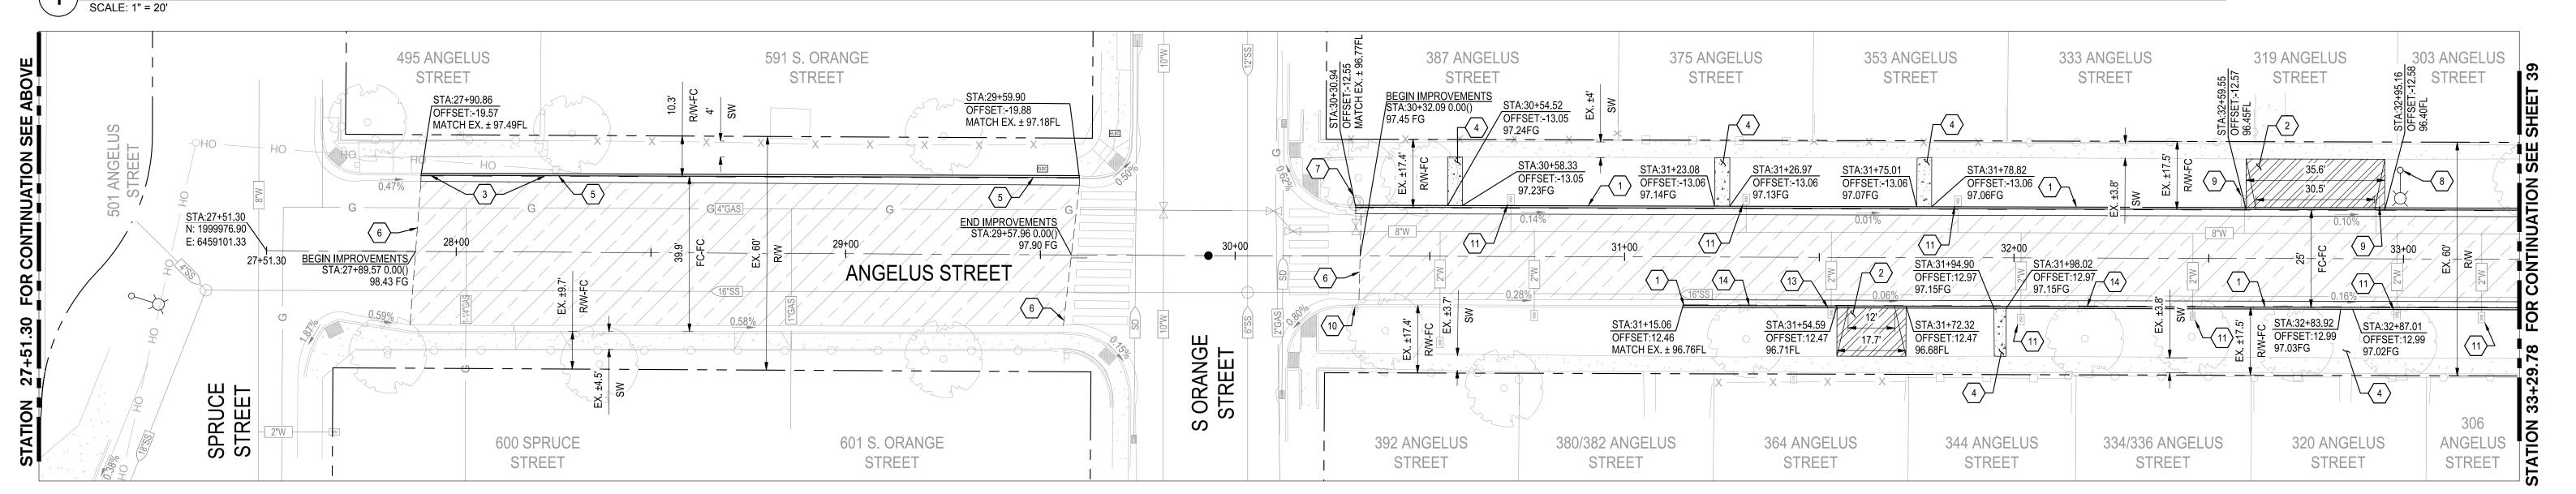

ANGELUS STREET STA: 27+51.30 TO 33+29.78

CONSTRUCTION KEYNOTES:

- REMOVE AND RECONSTRUCT CONCRETE CURB & GUTTER PER CITY OF TURLOCK STD. C-1
- REMOVE AND RECONSTRUCT CONCRETE DRIVEWAY APPROACH PER CITY OF TURLOCK STD. C-5
- REMOVE CURB AND CONSTRUCT CONCRETE CURB & GUTTER PER CITY OF TURLOCK STD. C-1
- REMOVE AND RECONSTRUCT SIDEWALK PER CITY OF TURLOCK STD. C-3
- CONSTRUCT CURB AND GUTTER PER CITY OF TURLOCK STD. C-1
- CONFORM TO EXISTING PAVEMENT. SEE DETAIL 2 ON SHEET 115.
- REMAIN IN PLACE EXISTING FIRE HYDRANT
- REMAIN IN PLACE EXISTING STREET LIGHT
- REPLACE EXISTING WATER METER BOX AND LID WITH H-20 TRAFFIC RATED BOX AND LID PER CITY OF TURLOCK STD.
- REMAIN IN PLACE EXISTING R6-1R SIGN PANEL AND POST
- REMAIN IN PLACE EXISTING WATER METER
- REMOVE COMPLETELY EXISTING TREE PER ARBORIST REVIEW. CONTRACTOR SHALL REMOVE STUMP & ROOTS AND GRIND AS NEEDED PRIOR TO IMPROVEMENTS.

ADJUST EXISTING WATER METER TO GRADE

CONTRACTOR SHALL MODIFY CURB & GUTTER IN FRONT OF TREE PER DETAIL 1 ON SHEET 46

NOTE:

FOR LAYOUT NOTES, REFER TO SHEET 31

LEGEND:

ASPHALT PAVEMENT (TI=6.0)
5" HMA. FULL DEPTH AC OVER 8" RECOMPACTED SUBGRADE PREPARED PER SECTION 10.25 EARTHWORK IN THE TECHNICAL SPECIFICATIONS


SIDEWALK CONCRETE

3.5" PCC OVER 6" NATIVE MATERIAL PREPARED PER SECTION 10.22 EARTHWORK IN THE TECHNICAL SPECIFICATIONS

> DRIVEWAY CONCRETE
> 5.5" PCC OVER 6" NATIVE MATERIAL PREPARED PER SECTION 10.22 EARTHWORK IN THE TECHNICAL SPECIFICATIONS


EXISTING CONCRETE TO REMAIN

TRUNCATED DOMES TRUNCATED DOMES COMPLYING WITH CBC 11B-705.

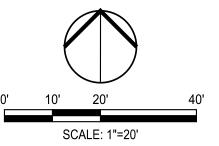



NOTE: ALL REFERENCES AND WRITTEN DIMENSIONS SHALL SUPERCEDE ALL SCALED DISTANCES AND SHALL BE VERIFIED IN THE FIELD. ANY DISCREPANCY SHALL BE BROUGHT TO THE ATTENTION OF THE ENGINEER PRIOR TO THE COMMENCEMENT OF WORK

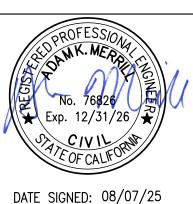



www.siegfriedeng.com




CITY OF TURLOCK MUNICIPAL SERVICES DEPARTMENT 156 S. BROADWAY, SUITE 150 (209) 668 - 5520

IMPROVEMENTS PLAN - ANGELUS STREET III

	SCALE	E: 1"=20'
VERIFY SCALE	DRAWN BY: JR	DRAWING NO
0 1"	REV. BY: AKM	
	CH. BY: AKM	38
	DATE: 8/7/2025	
	SCALE: SEE SHEET	SHEET:
	SEI PROJ NO: 22157	38 OF 117

1 ANGELUS STREET STA: 33+29.78 TO 39+66.72

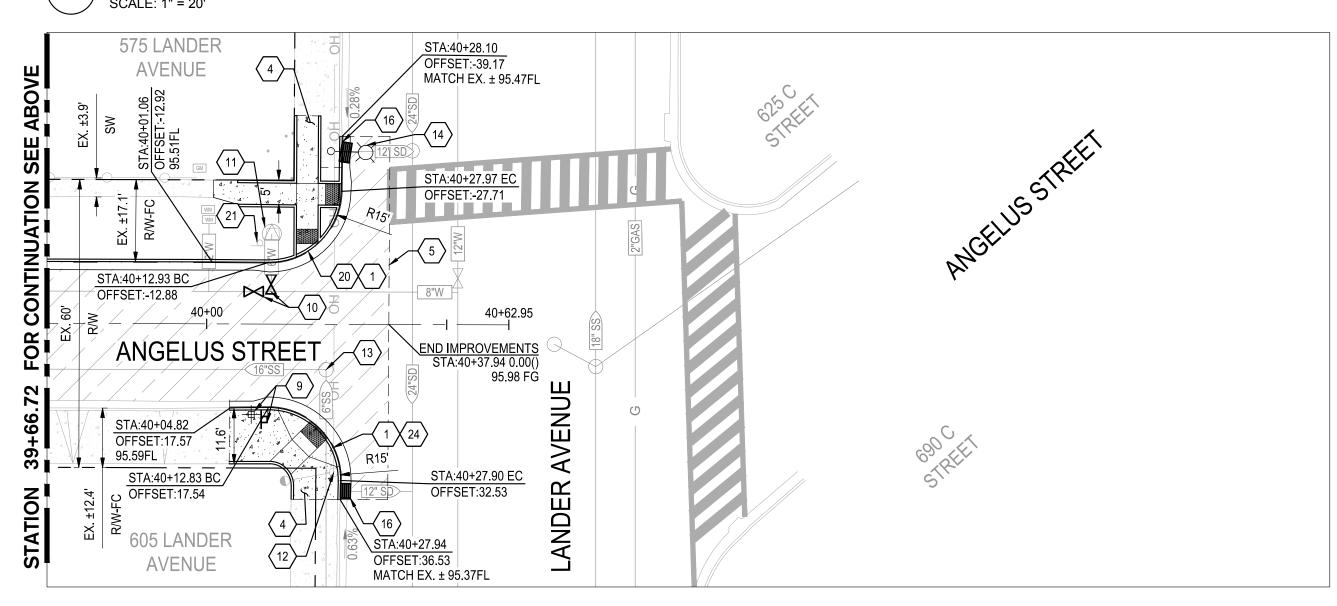

2 ANGELUS STREET STA: 39+66.72 TO END

CONSTRUCTION KEYNOTES:

- 1 REMOVE AND RECONSTRUCT CONCRETE CURB & GUTTER PER CITY OF TURLOCK STD. C-1
- 2 REMOVE AND RECONSTRUCT CONCRETE DRIVEWAY APPROACH PER CITY OF TURLOCK STD. C-5
- REMOVE CURB AND CONSTRUCT CONCRETE CURB & GUTTER PER CITY OF TURLOCK STD. C-1
- REMOVE AND RECONSTRUCT SIDEWALK PER CITY OF TURLOCK STD. C-3
- 5 CONFORM TO EXISTING PAVEMENT. SEE DETAIL 2 ON SHEET 115.
- REMOVE EXISTING CONCRETE AND CONSTRUCT MODIFIED CASE G CURB RAMP PER CALTRANS STD. A88A.
- 7 CONSTRUCT CONCRETE DRIVEWAY APPROACH PER CITY OF TURLOCK STD. C-5
- 8 CONSTRUCT CONCRETE VALLEY GUTTER PER CITY OF TURLOCK STD. C-1
- PREMOVE AND RELOCATE ROADSIDE SIGN AND POST. SEE STRIPING PLAN FOR MORE DETAILS.
- REPLACE EXISTING WATER VALVE BOX. SET TO NEW PAVEMENT GRADE. SEE CITY OF TURLOCK WATER VALVE BOX DETAIL STD. W-6
- 11) REMAIN IN PLACE EXISTING FIRE HYDRANT
- (12) REMAIN IN PLACE EXISTING POWER POLE
- 3 ADJUST EXISTING SANITARY SEWER MANHOLE TO GRADE

- (14) REMAIN IN PLACE EXISTING STREET LIGHT
- (15) REMAIN IN PLACE EXISTING ROADSIDE SIGN AND POST
- REMOVE AND DISPOSE EXISTING STORM DRAIN INLET.
- INSTALL CATCH BASIN AND FRAME PER CITY OF TURLOCK STD. SD-3 AND SD-5.
- 17 ADJUST EXISTING WATER METER TO GRADE
- REMOVE AND RESET SURVEY MONUMENT.
 CONTRACTOR SHALL NOTIFY ENGINEER OF ALL MONUMENTS THAT ARE TO BE RESET DUE TO CONSTRUCTION OPERATIONS.
- INSTALL SIGN PANEL ON EXISTING STREET LIGHT. SEE STRIPING PLANS FOR MORE DETAILS.
- REMOVE EXISTING CONCRETE AND CONSTRUCT MODIFIED CASE F CURB RAMP PER
- 21 REMAIN IN PLACE EXISTING POST, R5-1, R6-1R, AND STREET NAME SIGN PANELS
- (22) REMAIN IN PLACE EXISTING WATER METER
- REMAIN IN PLACE EXISTING FENCE
- REMOVE EXISTING CONCRETE AND CONSTRUCT CASE B CURB RAMP PER CALTRANS STD. A88A

REPLACE EXISTING WATER METER BOX AND LID WITH H-20 TRAFFIC RATED BOX AND LID PER CITY OF TURLOCK STD.

NOTE:

FOR LAYOUT NOTES, REFER TO SHEET 31

LEGEND:

5" HMA. FULL DEPTH AC OVER 8" RECOMPACTED SUBGRADE PREPARED PER SECTION 10.25 EARTHWORK IN THE TECHNICAL SPECIFICATIONS


3.5" PCC OVER 6" NATIVE MATERIAL PREPARED PER SECTION 10.22 EARTHWORK IN THE TECHNICAL SPECIFICATIONS

DRIVEWAY CONCRETE

5.5" PCC OVER 6" NATIVE MATERIAL PREPARED PER SECTION 10.22 EARTHWORK IN THE TECHNICAL SPECIFICATIONS

EXISTING CONCRETE TO REMAIN

TRUNCATED DOMES
TRUNCATED DOMES COMPLYING WITH CBC 11B-705.

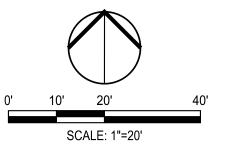



NOTE:
ALL REFERENCES AND WRITTEN
DIMENSIONS SHALL SUPERCEDE
ALL SCALED DISTANCES AND
SHALL BE VERIFIED IN THE
FIELD. ANY DISCREPANCY
SHALL BE BROUGHT TO THE
ATTENTION OF THE ENGINEER
PRIOR TO THE COMMENCEMENT
OF WORK






209-943-2021
www.siegfriedeng.com

LANDSCAPE
ARCHITECTURE


ATHLETIC
FACILITY DESIGN

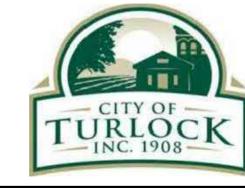

CITY OF TURLOCK
MUNICIPAL SERVICES DEPARTMENT
156 S. BROADWAY,
SUITE 150
(209) 668-5520

IMPROVEMENTS PLAN - ANGELUS STREET IV

VERIFY SCALE	DRAWN BY: JR	DRAWING NO
0 1"	REV. BY: AKM	
	CH. BY: AKM	39
	DATE: 8/7/2025	
	SCALE: SEE SHEET	SHEET:
	SEI PROJ NO: 22157	39 OF 11

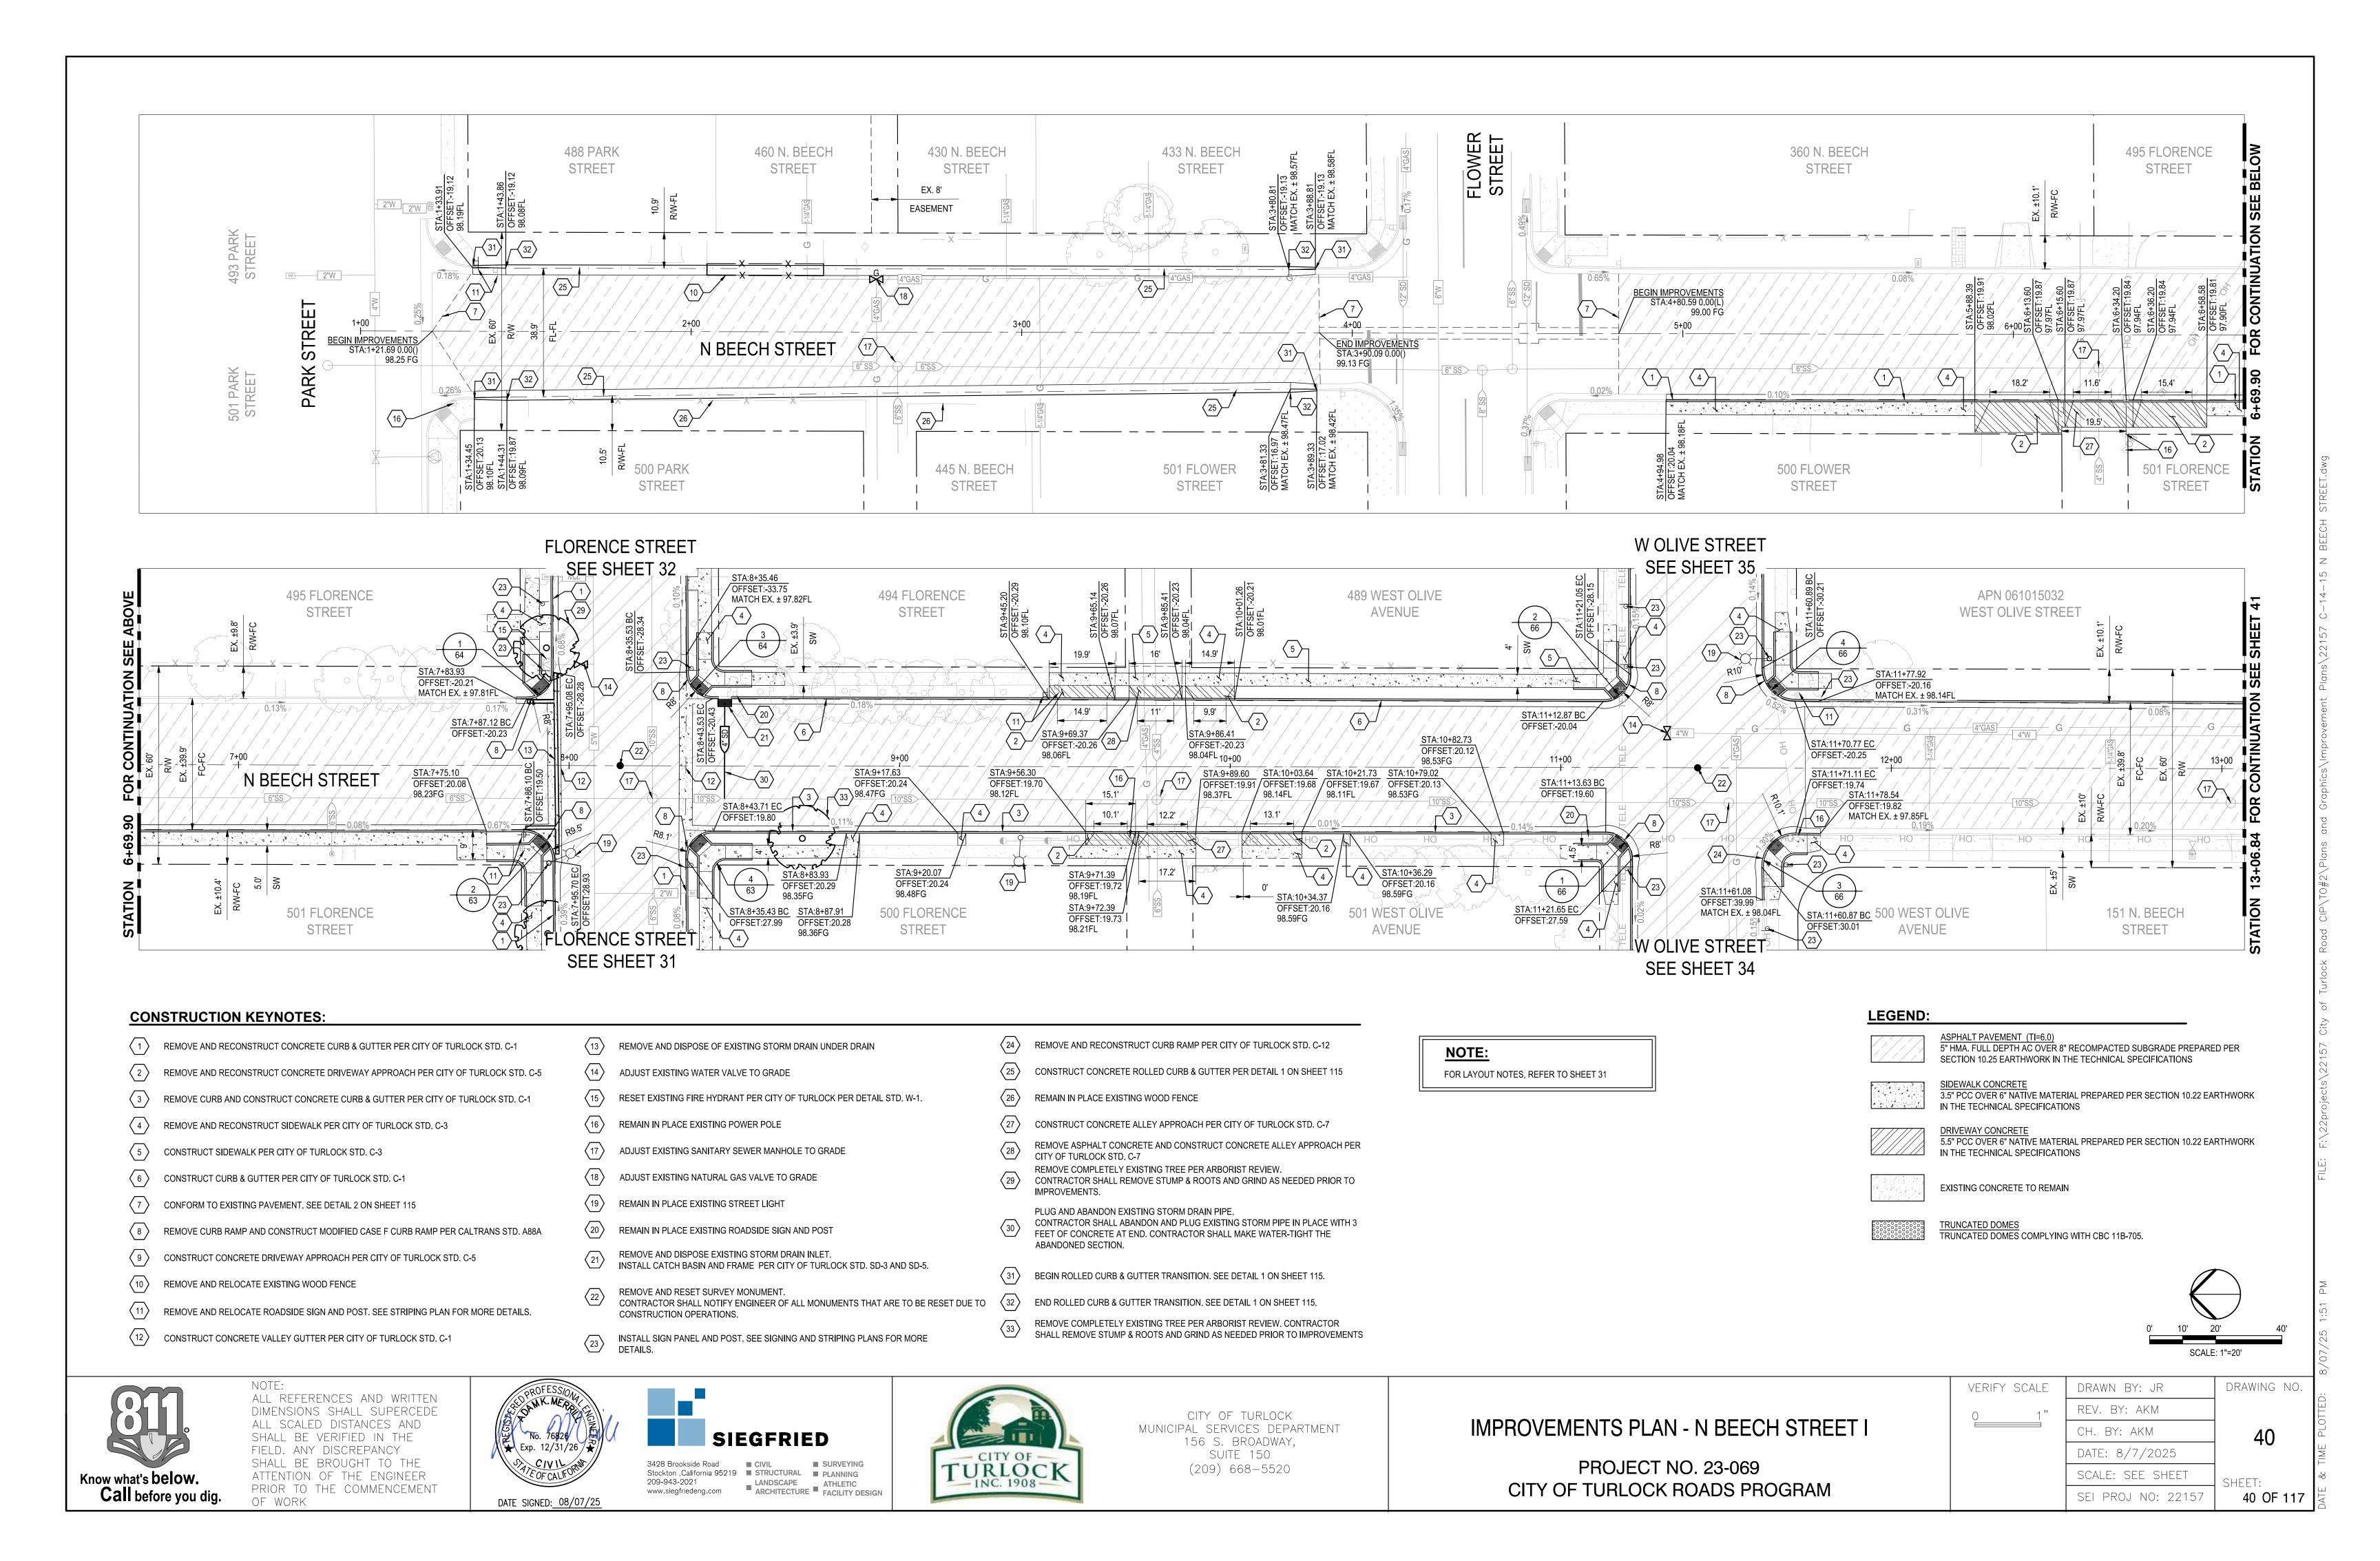

CONSTRUCTION KEYNOTES:

CONFORM TO EXISTING PAVEMENT. SEE DETAIL 2 ON SHEET 115.

REPLACE EXISTING WATER VALVE BOX. SET TO NEW PAVEMENT GRADE. SEE CITY OF TURLOCK WATER VALVE BOX DETAIL STD. W-6

ADJUST EXISTING SANITARY SEWER MANHOLE TO GRADE

4 REMAIN IN PLACE EXISTING STORM DRAIN INLET

REMAIN IN PLACE EXISTING POWER POLE

6 REMAIN IN PLACE EXISTING POST, W4-4P, R1-1, AND STREET NAME SIGN PANELS

CONSTRUCT CONCRETE ALLEY APPROACH PER CITY OF TURLOCK STD. C-7

REMOVE AND RECONSTRUCT CONCRETE CURB & GUTTER PER CITY OF TURLOCK STD. C-1

NOTE:

FOR LAYOUT NOTES, REFER TO SHEET 31

LEGEND:


ASPHALT PAVEMENT (TI=6.0)
5" HMA. FULL DEPTH AC OVER 8" RECOMPACTED SUBGRADE PREPARED PER
SECTION 10.25 EARTHWORK IN THE TECHNICAL SPECIFICATIONS

SIDEWALK CONCRETE
3.5" PCC OVER 6" NATIVE MATERIAL PREPARED PER SECTION 10.22 EARTHWORK IN THE TECHNICAL SPECIFICATIONS

DRIVEWAY CONCRETE
5.5" PCC OVER 6" NATIVE MATERIAL PREPARED PER SECTION 10.22 EARTHWORK
IN THE TECHNICAL SPECIFICATIONS

EXISTING CONCRETE TO REMAIN

TRUNCATED DOMES
TRUNCATED DOMES COMPLYING WITH CBC 11B-705.

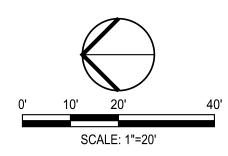




ALL REFERENCES AND WRITTEN DIMENSIONS SHALL SUPERCEDE ALL SCALED DISTANCES AND SHALL BE VERIFIED IN THE FIELD. ANY DISCREPANCY SHALL BE BROUGHT TO THE ATTENTION OF THE ENGINEER PRIOR TO THE COMMENCEMENT OF WORK





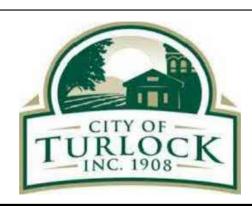

CITY OF TURLOCK MUNICIPAL SERVICES DEPARTMENT 156 S. BROADWAY, SUITE 150 (209) 668-5520

IMPROVEMENTS PLAN - N BEECH STREET II

PROJECT NO. 23-069 CITY OF TURLOCK ROADS PROGRAM

VERIFY	SCALE	
0	1"	
		L

DRAWING NO. DRAWN BY: JR REV. BY: AKM CH. BY: AKM DATE: 8/7/2025 SCALE: SEE SHEET SHEET: SEI PROJ NO: 22157 41 OF 117

131, 205, 207 285 CLIFFORD 225, 227, 235 215/217 CLIFFORD 901 WEST MAIN 275 CLIFFORD 119-129 CLIFFORD 111 CLIFFORD CLIFFORD AVENUE **AVENUE AVENUE** CLIFFORD AVENUE **AVENUE AVENUE AVENUE** STREET

CLIFFORD AVENUE STA: 6+74.88 TO 13+11.82

CONSTRUCTION KEYNOTES:


- CONFORM TO EXISTING PAVEMENT. SEE DETAIL 2 ON SHEET 115.
- ADJUST EXISTING SANITARY SEWER MANHOLE TO GRADE
- REMAIN IN PLACE EXISTING POWER POLE
- REMAIN IN PLACE EXISTING STORM DRAIN INLET
- REMAIN IN PLACE EXISTING ROADSIDE SIGN AND POST
- REMAIN IN PLACE EXISTING WOOD FENCE
- REMAIN IN PLACE EXISTING STREET LIGHT
- INSTALL SIGN PANEL AND POST. SEE SIGNING AND STRIPING PLANS FOR MORE DETAILS.
- REMOVE AND RECONSTRUCT CONCRETE DRIVEWAY APPROACH PER CITY OF TURLOCK STD. C-5
- REMOVE AND RECONSTRUCT CONCRETE CURB & GUTTER PER CITY OF TURLOCK STD. C-1
- REMOVE AND RECONSTRUCT CONCRETE SIDEWALK PER CITY OF TURLOCK STD. C-3
- RECONNECT DOWNSPOUT DRAIN PIPE

NOTE:

FOR LAYOUT NOTES, REFER TO SHEET 31

Know what's below. Call before you dig.

ALL REFERENCES AND WRITTEN DIMENSIONS SHALL SUPERCEDE ALL SCALED DISTANCES AND SHALL BE VERIFIED IN THE FIELD. ANY DISCREPANCY SHALL BE BROUGHT TO THE ATTENTION OF THE ENGINEER PRIOR TO THE COMMENCEMENT OF WORK

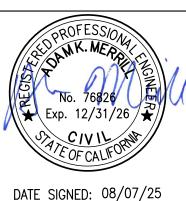




REMAIN IN PLACE EXISTING WROUGHT IRON FENCE

REMAIN IN PLACE EXISTING WATER METER

ADJUST EXISTING WATER METER TO GRADE

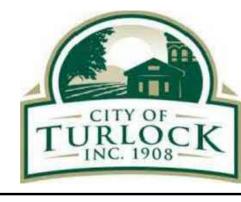

CITY OF TURLOCK MUNICIPAL SERVICES DEPARTMENT 156 S. BROADWAY, SUITE 150 (209) 668 - 5520

IMPROVEMENTS PLAN - CLIFFORD AVENUE I PROJECT NO. 23-069

LEGEND:

SCALE: 1"=20' VERIFY SCALE DRAWN BY: JR REV. BY: AKM CH. BY: AKM DATE: 8/7/2025 SCALE: SEE SHEET SHEET: 42 OF 117 SEI PROJ NO: 22157

ASPHALT PAVEMENT (TI=6.0)
5" HMA. FULL DEPTH AC OVER 8" RECOMPACTED SUBGRADE PREPARED PER SECTION 10.25 EARTHWORK IN THE TECHNICAL SPECIFICATIONS

ASPHALT PAVEMENT (TI=6.0)
3.5" HMA OVER 5" CLASS 2 AGGREGATE BASE OVER
RECOMPACTED SUBGRADE PREPARED PER SECTION

SIDEWALK CONCRETE
3.5" PCC OVER 6" NATIVE MATERIAL PREPARED

5.5" PCC OVER 6" NATIVE MATERIAL PREPARED

PER SECTION 10.22 EARTHWORK IN THE TECHNICAL SPECIFICATIONS

PER SECTION 10.22 EARTHWORK IN THE TECHNICAL SPECIFICATIONS

EXISTING CONCRETE TO REMAIN

10.25 EARTHWORK IN THE TECHNICAL SPECIFICATIONS

TRUNCATED DOMES TRUNCATED DOMES COMPLYING WITH CBC 11B-705. DRAWING NO.

CITY OF TURLOCK ROADS PROGRAM

CONSTRUCTION KEYNOTES:

CONFORM TO EXISTING PAVEMENT. SEE DETAIL 2 ON SHEET 115.

ADJUST EXISTING SANITARY SEWER MANHOLE TO GRADE

REMAIN IN PLACE EXISTING STREET LIGHT

NOTE:

FOR LAYOUT NOTES, REFER TO SHEET 31


LEGEND:


ASPHALT PAVEMENT (TI=6.0)
3.5" HMA OVER 5" CLASS 2 AGGREGATE BASE OVER
RECOMPACTED SUBGRADE PREPARED PER SECTION
10.25 EARTHWORK IN THE TECHNICAL SPECIFICATIONS


EXISTING CONCRETE TO REMAIN



ALL REFERENCES AND WRITTEN DIMENSIONS SHALL SUPERCEDE
ALL SCALED DISTANCES AND
SHALL BE VERIFIED IN THE
FIELD. ANY DISCREPANCY
SHALL BE BROUGHT TO THE
ATTENTION OF THE ENGINEER PRIOR TO THE COMMENCEMENT OF WORK

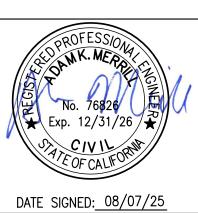

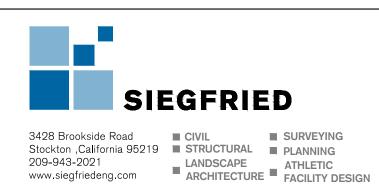

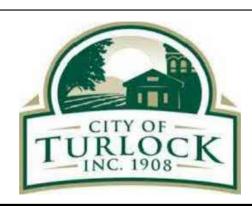

CITY OF TURLOCK MUNICIPAL SERVICES DEPARTMENT 156 S. BROADWAY, SUITE 150 (209) 668-5520

IMPROVEMENTS PLAN - CLIFFORD AVENUE II

JUALL	/LINII	
1"	0	
		г

REV. BY: AKM CH. BY: AKM DATE: 8/7/2025 SCALE: SEE SHEET SHEET: SEI PROJ NO: 22157 43 OF 117

PROJECT NO. 23-069 CITY OF TURLOCK ROADS PROGRAM VERIFY SCALE DRAWN BY: JR DRAWING NO. THE BURL STA: 1+00 TO END

1043 CHESTNU 1063 CHESTNUT 1083 CHESTNUT 1127 CHESTNUT 1125 CHESTNUT 1129 CHESTNUT 700 SODERQUIST STREET STREET STREET STREET STREET ROAD 0.20% 4+00 CHESTNUT STREET STA:1+00.00 N: 2004341.52 E: 6456575.29 0.15% 1060 CHESTNUT 1098 CHESTNUT 1088 CHESTNUT 1116 CHESTNUT 674 SODERQUIST STREET STREET STREET STREET STREET ROAD

2 CHESTNUT STREET STA: 1+00 TO 5+31.16

SCALE: 1" = 20'

CONSTRUCTION KEYNOTES:

- 1 REMAIN IN PLACE EXISTING FIRE HYDRANT
- REMOVE AND RECONSTRUCT SIDEWALK PER CITY OF TURLOCK STD. C-3
- REMAIN IN PLACE EXISTING POWER POLE
- 4 REMOVE AND RECONSTRUCT CURB RAMP PER CITY OF TURLOCK STD. C-12
- 75 REMOVE AND RECONSTRUCT CONCRETE VALLEY GUTTER PER CITY OF TURLOCK STD. C-1
- REPLACE EXISTING WATER METER BOX. SET TO NEW PAVEMENT GRADE. WATER METER BOX SHALL BE TRAFFIC RATED BOX.
- 7 ADJUST EXISTING SANITARY SEWER MANHOLE TO GRADE
- (8) INSTALL SIGN PANEL AND POST. SEE SIGNING AND STRIPING PLANS FOR MORE DETAILS.
- 9 CONFORM TO EXISTING PAVEMENT. SEE DETAIL 2 ON SHEET 115.
- 10 REMOVE AND RECONSTRUCT CONCRETE CURB & GUTTER PER CITY OF TURLOCK STD. C-1
- REPLACE EXISTING WATER VALVE BOX. SET TO NEW PAVEMENT GRADE. SEE CITY OF TURLOCK WATER VALVE BOX DETAIL STD. W-6
- (12) REMAIN IN PLACE EXISTING WROUGHT IRON FENCE

- REMOVE AND RESET SURVEY MONUMENT.
 CONTRACTOR SHALL NOTIFY ENGINEER OF ALL MONUMENTS THAT ARE TO BE RESET DUE TO CONSTRUCTION OPERATIONS.
- 8 BEGIN TRANSITION FOR CONCRETE ROLLED CURB PER DETAIL 5 ON SHEET 115
- (15) END TRANSITION FOR CONCRETE ROLLED CURB PER DETAIL 5 ON SHEET 115
- REMOVE AND REPLACE STORM DRAIN INLET PER CITY OF TURLOCK STD. SD-3. SEE UTILITY PLANS FOR MORE DETAILS.

NOTE:

FOR LAYOUT NOTES, REFER TO SHEET 31

LEGEND:


ASPHALT PAVEMENT (TI=6.0)
5" HMA. FULL DEPTH AC OVER 8" RECOMPACTED SUBGRADE PREPARED PER SECTION 10.25 EARTHWORK IN THE TECHNICAL SPECIFICATIONS

SIDEWALK CONCRETE

3.5" PCC OVER 6" NATIVE MATERIAL PREPARED PER SECTION 10.22 EARTHWORK IN THE TECHNICAL SPECIFICATIONS


EXISTING CONCRETE TO REMAIN

TRUNCATED DOMES
TRUNCATED DOMES COMPLYING WITH CBC 11B-705.

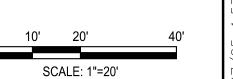




NOTE:
ALL REFERENCES AND WRITTEN
DIMENSIONS SHALL SUPERCEDE
ALL SCALED DISTANCES AND
SHALL BE VERIFIED IN THE
FIELD. ANY DISCREPANCY
SHALL BE BROUGHT TO THE
ATTENTION OF THE ENGINEER
PRIOR TO THE COMMENCEMENT
OF WORK

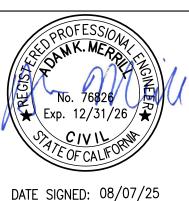



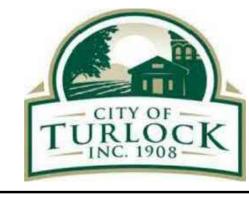



CITY OF TURLOCK MUNICIPAL SERVICES DEPARTMENT 156 S. BROADWAY, SUITE 150 (209) 668-5520

IMPROVEMENTS PLAN - THE BURL

RIFY SCALE	DRAWN BY: JR	DRAWING NO
1 "	REV. BY: AKM	
	CH. BY: AKM	44
	DATE: 8/7/2025	
	SCALE: SEE SHEET	SHEET:
	SEI PROJ NO: 22157	44 OF 11

S. ORANGE STREET STA: 1+00 TO 6+78.60

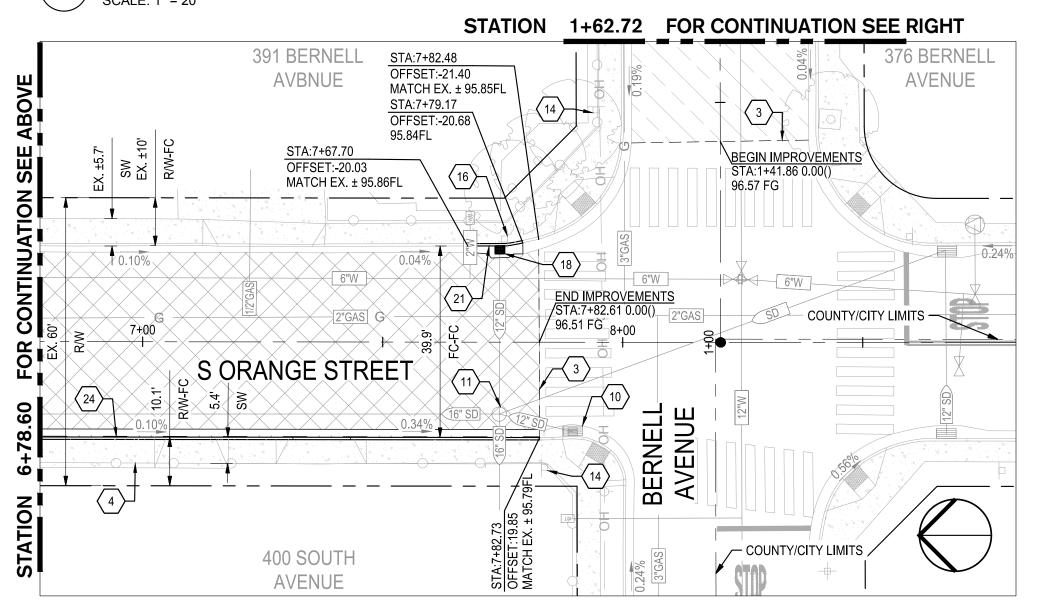

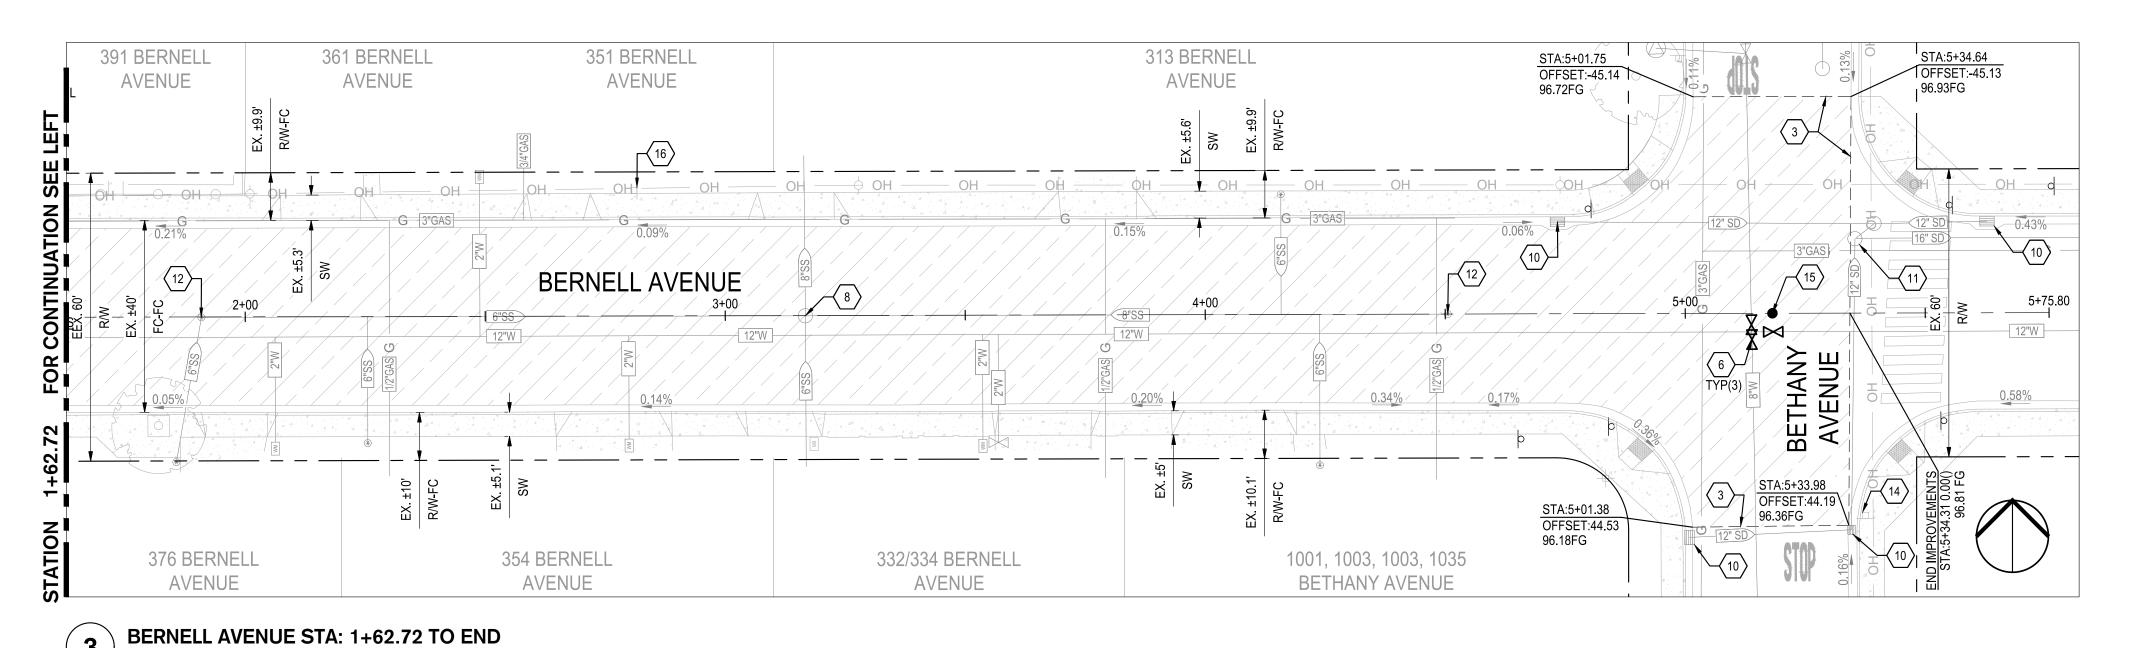

S. ORANGE STA: 6+78.60 TO 8+81.94

CONSTRUCTION KEYNOTES:

- REMOVE CURB AND CONSTRUCT CONCRETE CURB & GUTTER PER CITY OF TURLOCK STD. C-1
- REMOVE AND RECONSTRUCT SIDEWALK PER CITY OF TURLOCK STD. C-3
- CONFORM TO EXISTING PAVEMENT. SEE DETAIL 2 ON SHEET 115.
- REMAIN IN PLACE EXISTING CHAIN LINK FENCE
- REMAIN IN PLACE EXISTING WROUGHT IRON FENCE
- REPLACE EXISTING WATER VALVE BOX TO NEW PAVEMENT GRADE. SEE CITY OF TURLOCK WATER VALVE BOX DETAIL STD. W-6
- REMAIN IN PLACE EXISTING POWER POLE
- ADJUST EXISTING SANITARY SEWER MANHOLE TO GRADE
- REMAIN IN PLACE EXISTING STREET LIGHT
- REMAIN IN PLACE EXISTING STORM DRAIN INLET
- ADJUST EXISTING STORM DRAIN MANHOLE TO GRADE
- ADJUST EXISTING SANITARY SEWER CLEANOUT TO GRADE

- REMAIN IN PLACE EXISTING ELECTRICAL BOX
- REMAIN IN PLACE EXISTING ROADSIDE SIGN AND POST
- REMOVE AND RESET SURVEY MONUMENT. CONTRACTOR SHALL NOTIFY ENGINEER OF ALL MONUMENTS THAT ARE TO BE RESET DUE TO CONSTRUCTION OPERATIONS.
- REMAIN IN PLACE EXISTING POST AND SW24-3 SIGN PANEL
- REMAIN IN PLACE EXISTING POST AND SR4-1 SIGN PANEL
- REPLACE STORM DRAIN INLET PER CITY OF TURLOCK STD. SD-3.
- CONTRACTOR SHALL REPLACE TRAFFIC SIGNAL LOOPS ON THIS LANE, PER CITY OF TURLOCK AND SPECIFICATIONS.
- REMOVE AND RECONSTRUCT CONCRETE DRIVEWAY APPROACH PER CITY OF
- REMOVE AND RECONSTRUCT CONCRETE CURB & GUTTER PER CITY OF TURLOCK
- 22 RECONNECT UNDERDRAIN PIPE

- REMOVE AND RECONSTRUCT MODIFIED CONCRETE DRIVEWAY APPROACH WITH 3/4" DRIVEWAY BREAKDOWN LIP PER CITY OF TURLOCK STD. C-5
- REMOVE CURB AND CONSTRUCT VARIABLE HEIGHT CONCRETE CURB & GUTTER PER CITY OF TURLOCK STD. C-1. MATCH NEW TOP OF CURB TO EXISTING SIDEWALK. SEE GRADING PLAN FOR MORE DETAILS.

NOTES:

INTERSECTION.

I. FOR LAYOUT NOTES, REFER TO SHEET 31 2. THE INTERSECTION OF S. ORANGE STREET & BERNELL AVENUE SHALL REMAIN OPEN TO ALLOW DROP-OFF AT BERNELL AVENUE, WEST OF

LEGEND:

ASPHALT PAVEMENT (TI=7.0)
4" AC OVER 5" CLASS 2 AB OVER 8" RECOMPACTED SUBGRADE PREPARED PER SECTION 10.25 EARTHWORK IN THE TECHNICAL SPECIFICATIONS


ASPHALT PAVEMENT (TI=6.0)
5" HMA. FULL DEPTH AC OVER 8" RECOMPACTED SUBGRADE PREPARED PER SECTION 10.22 EARTHWORK IN THE TECHNICAL SPECIFICATIONS

SIDEWALK CONCRETE
3.5" PCC OVER 6" NATIVE MATERIAL PREPARED PER SECTION 10.22 EARTHWORK IN THE TECHNICAL SPECIFICATIONS

5.5" PCC OVER 6" NATIVE MATERIAL PREPARED PER SECTION 10.22 EARTHWORK IN THE TECHNICAL SPECIFICATIONS


EXISTING CONCRETE TO REMAIN

TRUNCATED DOMES
TRUNCATED DOMES COMPLYING WITH CBC 11B-705.

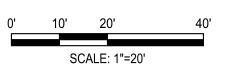




ALL REFERENCES AND WRITTEN DIMENSIONS SHALL SUPERCEDE ALL SCALED DISTANCES AND SHALL BE VERIFIED IN THE FIELD. ANY DISCREPANCY SHALL BE BROUGHT TO THE ATTENTION OF THE ENGINEER PRIOR TO THE COMMENCEMENT OF WORK

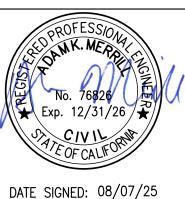



www.siegfriedeng.com

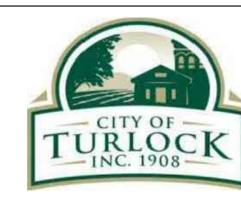


CITY OF TURLOCK MUNICIPAL SERVICES DEPARTMENT 156 S. BROADWAY, SUITE 150 (209) 668 - 5520

IMPROVEMENTS PLAN - S ORANGE STREET & BERNELL AVENUE PROJECT NO. 23-069 CITY OF TURLOCK ROADS PROGRAM

	SCALE	i: 1"=20'
VERIFY SCALE	DRAWN BY: JR	DRAWING NO.
0 1"	REV. BY: AKM	
	CH. BY: AKM	45
	DATE: 8/7/2025	
	SCALE: SEE SHEET	SHEET:
	SEI PROJ NO: 22157	45 OF 117

S. ORANGE STREET STA: 14+51.50 TO 20+40.72

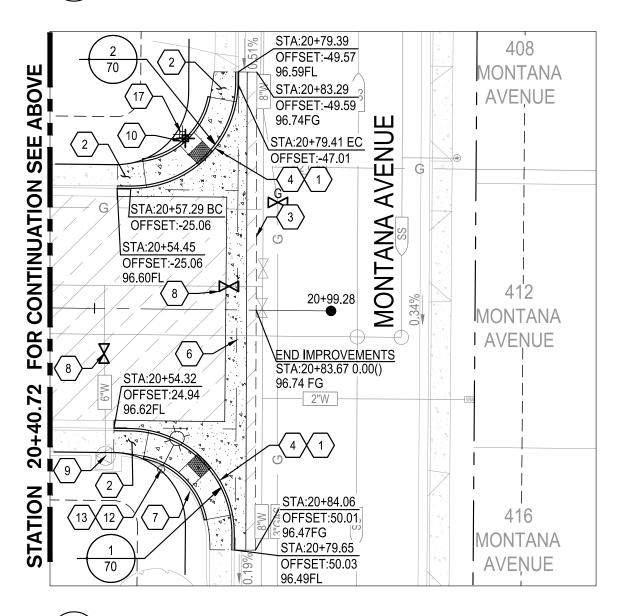

2 S. ORANGE STA: 20+40.72 TO END
SCALE: 1" = 20'

CONSTRUCTION KEYNOTES:

- REMOVE AND RECONSTRUCT CONCRETE CURB & GUTTER PER CITY OF TURLOCK STD. C-1
- REMOVE AND RECONSTRUCT SIDEWALK PER CITY OF TURLOCK STD. C-3
- CONFORM TO EXISTING PAVEMENT. SEE DETAIL 2 ON SHEET 115.
- REMOVE AND RECONSTRUCT CURB RAMP PER CITY OF TURLOCK STD. C-12
- REMAIN IN PLACE EXISTING ELECTRICAL BOX
- REMOVE AND RECONSTRUCT CONCRETE VALLEY GUTTER PER CITY OF TURLOCK STD. C-1
- REMAIN IN PLACE EXISTING CHAIN LINK FENCE
- REPLACE EXISTING WATER VALVE BOX TO NEW PAVEMENT GRADE. SEE CITY OF TURLOCK WATER VALVE BOX DETAIL STD. W-6
- REMAIN IN PLACE EXISTING FIRE HYDRANT
- REMOVE AND RELOCATE ROADSIDE SIGN AND POST. SEE STRIPING PLAN FOR MORE DETAILS.
- ADJUST EXISTING SANITARY SEWER MANHOLE TO GRADE
- REMAIN IN PLACE EXISTING STREET LIGHT


- REMAIN IN PLACE EXISTING ROADSIDE SIGN AND POST
- REMAIN IN PLACE EXISTING STORM DRAIN INLET
- ADJUST EXISTING WATER METER TO GRADE
- REMOVE AND RESET SURVEY MONUMENT. CONTRACTOR SHALL NOTIFY ENGINEER OF ALL MONUMENTS THAT ARE TO BE RESET DUE TO CONSTRUCTION OPERATIONS.

NOTE:

FOR LAYOUT NOTES, REFER TO SHEET 31

INSTALL SIGN PANEL AND POST. SEE SIGNING AND STRIPING PLANS FOR MORE



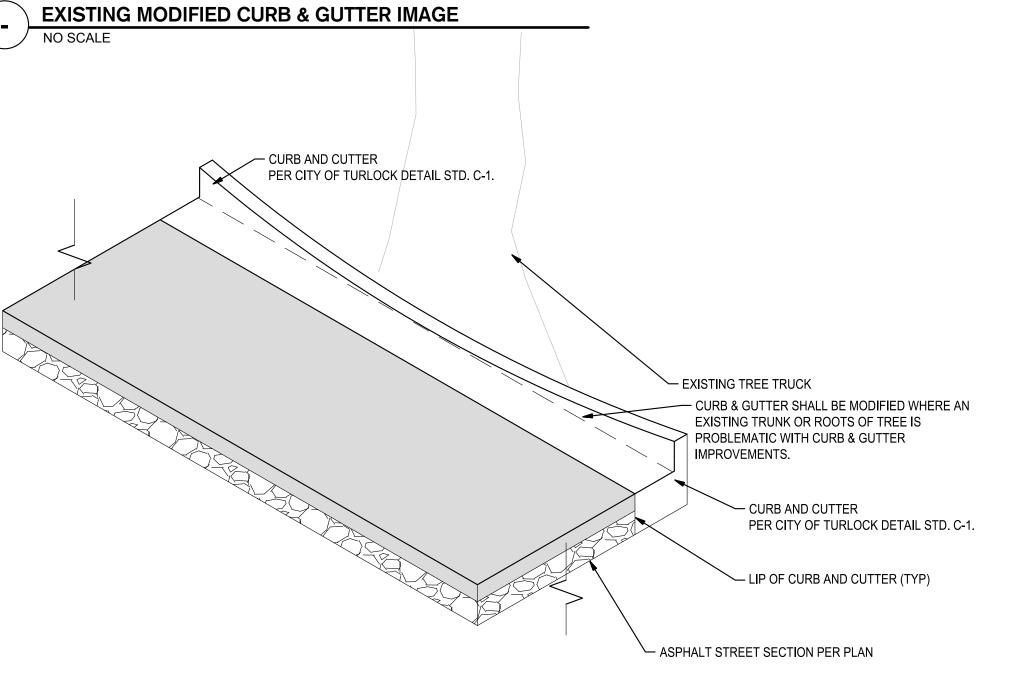

MODIFIED CURB & GUTTER AT TREE DETAIL

LEGEND:

ASPHALT PAVEMENT (TI=7.0)
4" AC OVER 5" CLASS 2 AB OVER 8" RECOMPACTED SUBGRADE PREPARED PER
SECTION 10.25 EARTHWORK IN THE TECHNICAL SPECIFICATIONS


SIDEWALK CONCRETE

3.5" PCC OVER 6" NATIVE MATERIAL PREPARED PER SECTION 10.22 EARTHWORK IN THE TECHNICAL SPECIFICATIONS

DRIVEWAY CONCRETE
5.5" PCC OVER 6" NATIVE MATERIAL PREPARED PER SECTION 10.22 EARTHWORK IN THE TECHNICAL SPECIFICATIONS


EXISTING CONCRETE TO REMAIN

TRUNCATED DOMES TRUNCATED DOMES COMPLYING WITH CBC 11B-705.

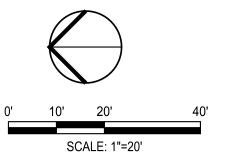




ALL REFERENCES AND WRITTEN DIMENSIONS SHALL SUPERCEDE ALL SCALED DISTANCES AND SHALL BE VERIFIED IN THE FIELD. ANY DISCREPANCY SHALL BE BROUGHT TO THE ATTENTION OF THE ENGINEER PRIOR TO THE COMMENCEMENT OF WORK

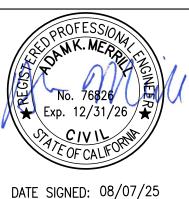



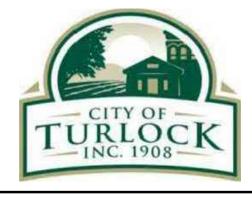


CITY OF TURLOCK MUNICIPAL SERVICES DEPARTMENT 156 S. BROADWAY, SUITE 150 (209) 668 - 5520

IMPROVEMENTS PLAN - S ORANGE STREET II

PROJECT NO. 23-069
CITY OF TURLOCK ROADS PROGRAM

	JOALL	1 –20
VERIFY SCALE	DRAWN BY: JR	DRAWING NO.
0 1"	REV. BY: AKM	
	CH. BY: AKM	46
	DATE: 8/7/2025	
	SCALE: SEE SHEET	SHEET:
	SEI PROJ NO: 22157	46 OF 117

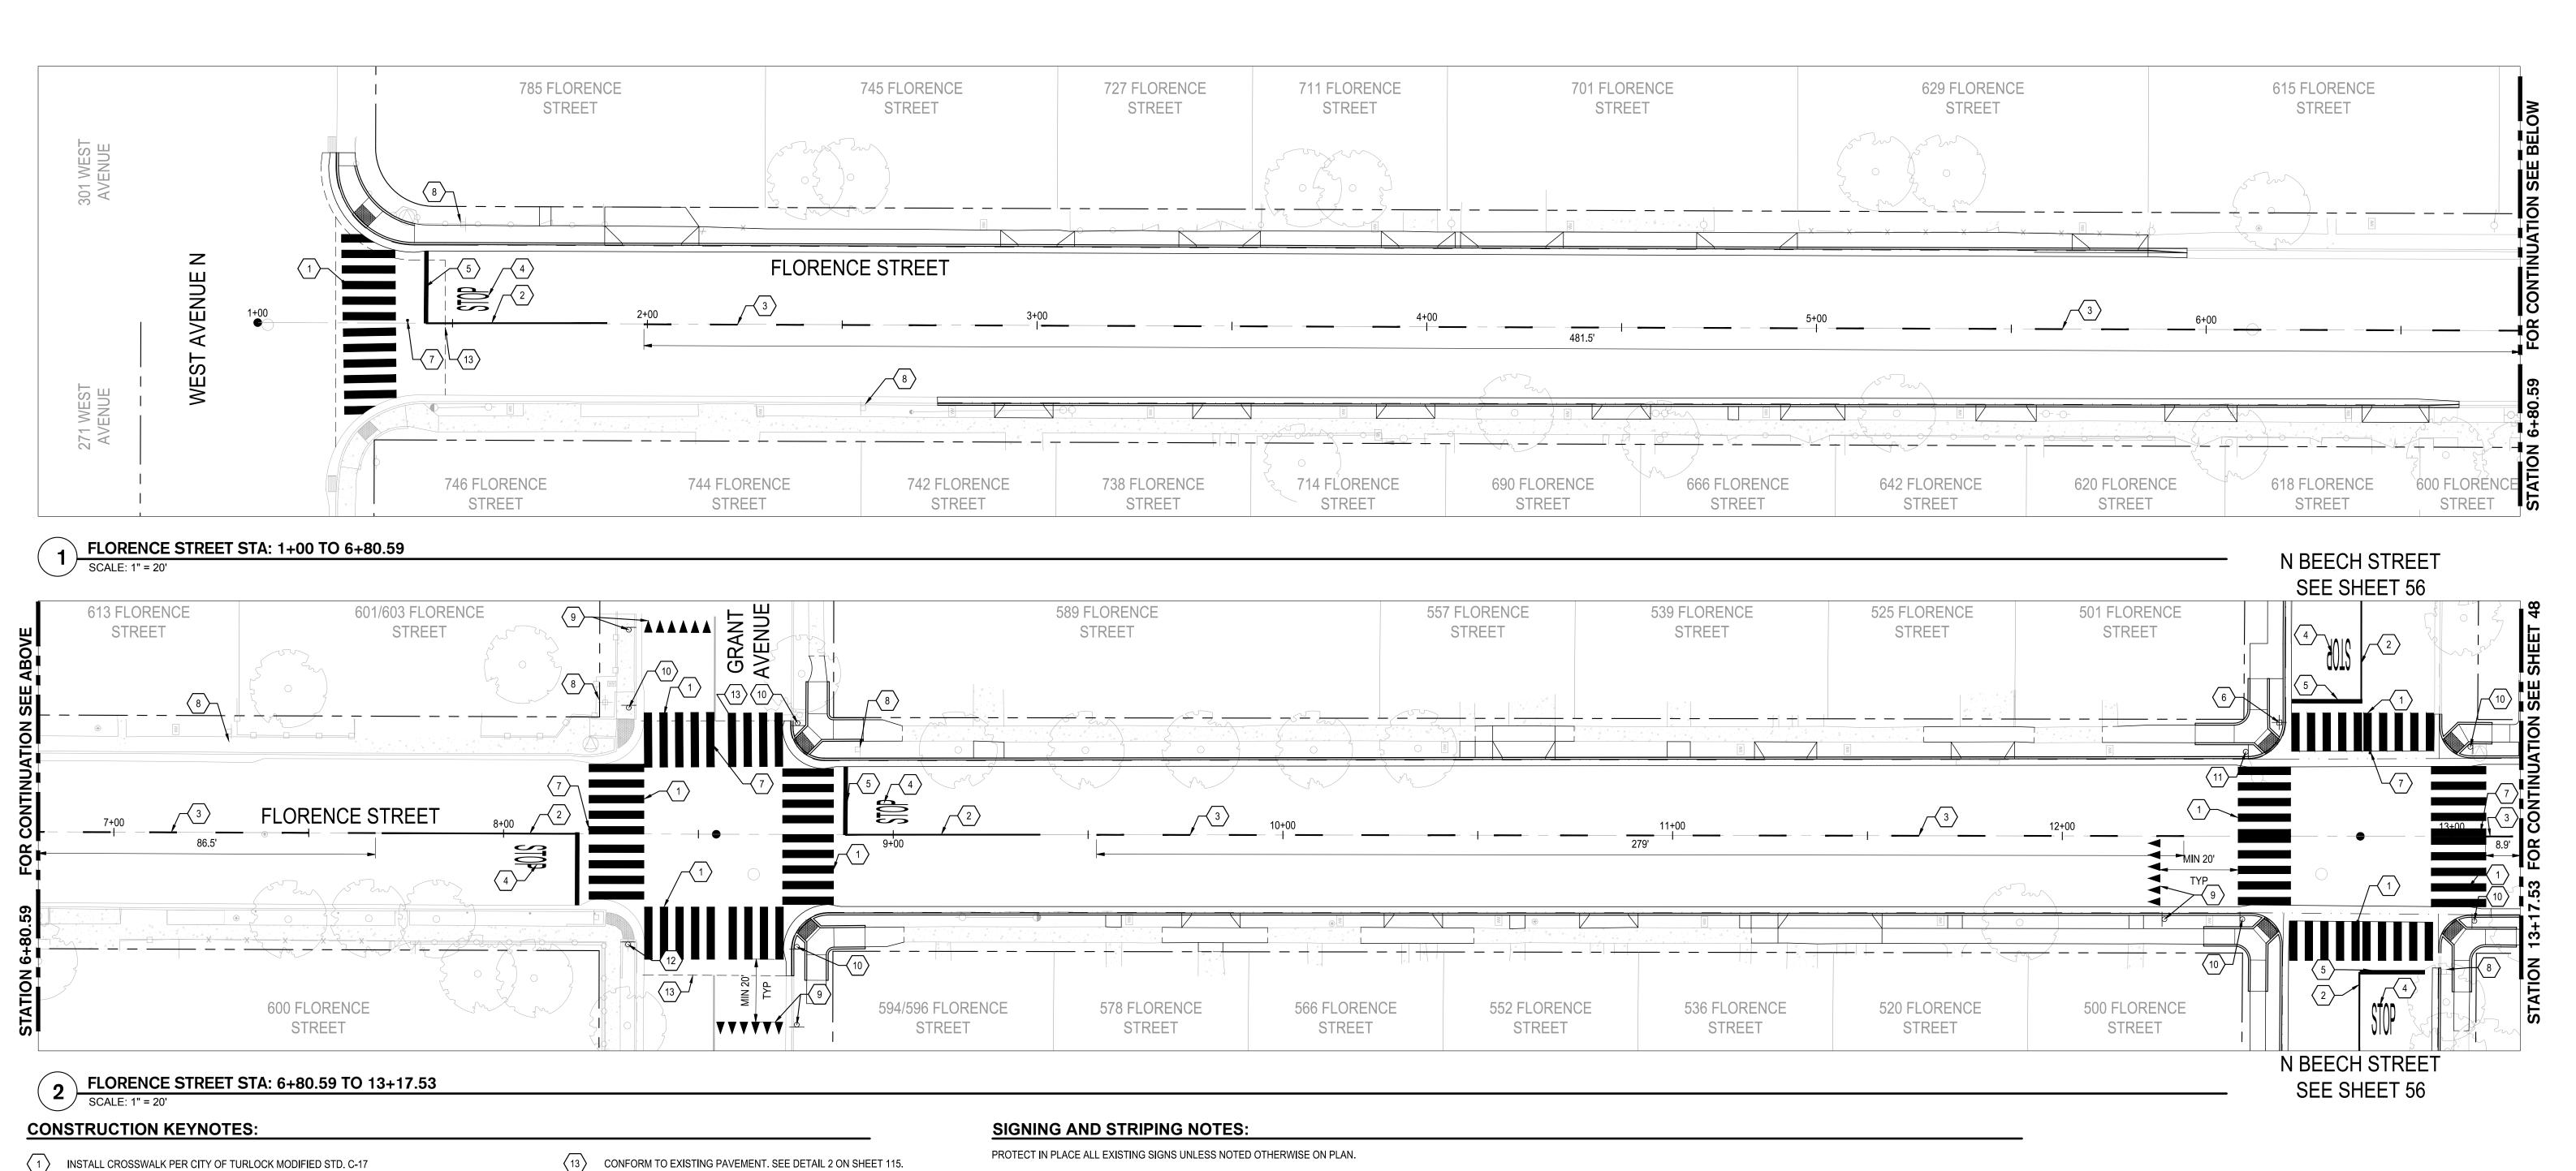

INSTALL 50 LF OF DETAIL 22 TRAFFIC LINES PER CALTRANS STANDARD DETAIL A20A

INSTALL DETAIL 2 TRAFFIC LINES PER CALTRANS STANDARD DETAIL A20A

INSTALL "STOP" MARKING PER CALTRANS STANDARD DETAIL A24D

INSTALL LIMIT STOP LINE MARKING FROM CENTERLINE TO LIP OF GUTTER PER CALTRANS STANDARD DETAIL A24G

REINSTALL EXISTING POST AND R1-1 SIGN PANEL PER CA MUTCD FIGURE 2B-1. REINSTALL STREET NAME SIGN PANELS ON POST PER CITY OF TURLOCK STANDARD DETAILS

INSTALL BLUE REFLECTIVE HYDRANT MARKER PER CITY OF TURLOCK STD. W-3

REMAIN IN PLACE EXISTING POST AND SIGN

INSTALL YIELD PAVEMENT MARKINGS AND R1-5 SIGNAGE PER CA MUTCD FIGURE 3B-17

INSTALL POST AND W11-2 & W16-7P SIGN PANELS PER CA MUTCD


INSTALL W11-2 & W16-7P SIGN PANELS ON EXISTING STREET LIGHT PER CA MUTCD


INSTALL W11-2 & W16-7P SIGN PANELS ON EXISTING POWER POLE PER CA MUTCD



ALL REFERENCES AND WRITTEN DIMENSIONS SHALL SUPERCEDE ALL SCALED DISTANCES AND SHALL BE VERIFIED IN THE FIELD. ANY DISCREPANCY SHALL BE BROUGHT TO THE ATTENTION OF THE ENGINEER PRIOR TO THE COMMENCEMENT OF WORK



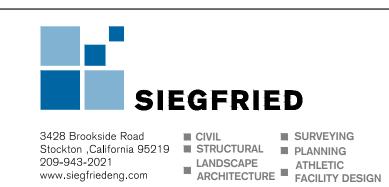


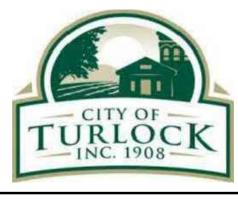

CITY OF TURLOCK MUNICIPAL SERVICES DEPARTMENT 156 S. BROADWAY, SUITE 150 (209) 668 - 5520

SIGNING AND STRIPING PLAN - FLORENCE STREET I

	SCALE	:: 1"=20'
/ERIFY SCALE	DRAWN BY: JR	DRAWING NO.
0 1"	REV. BY: AKM	
	CH. BY: AKM	47
	DATE: 8/7/2025	
	SCALE: SEE SHEET	SHEET:
	SEI PROJ NO: 22157	47 OF 117

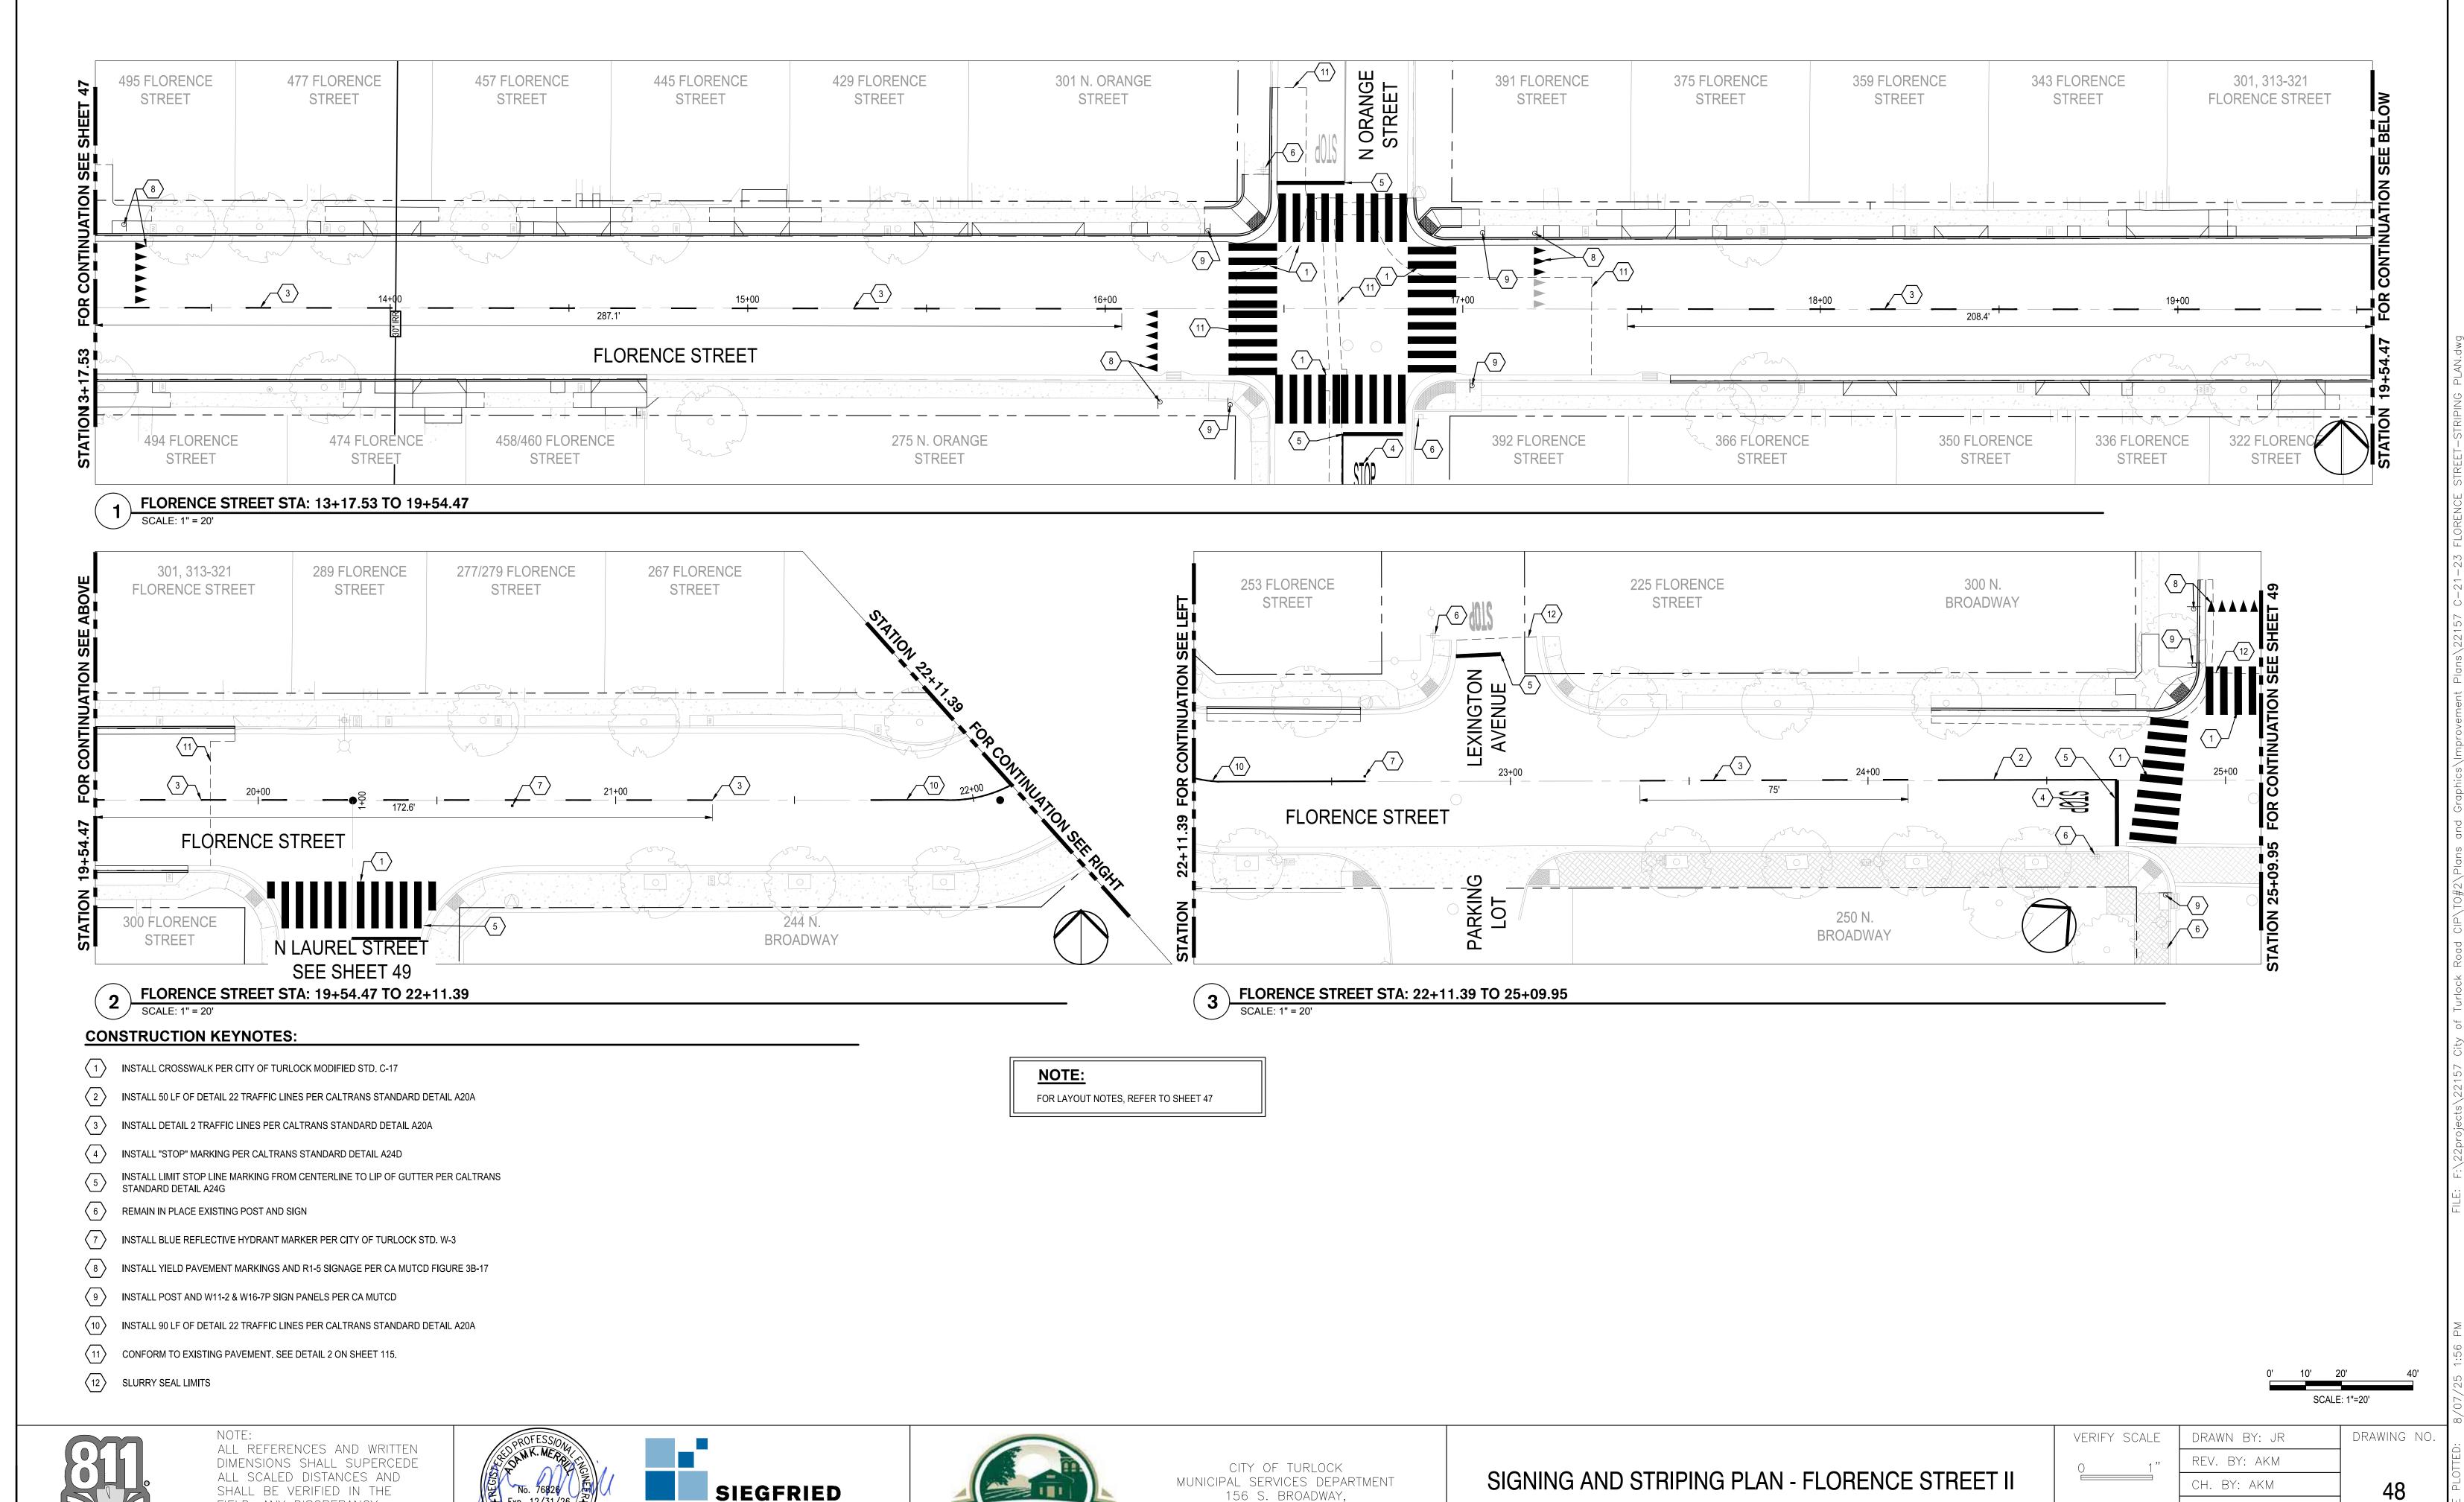

Know what's **below. Call** before you dig.

FIELD. ANY DISCREPANCY
SHALL BE BROUGHT TO THE
ATTENTION OF THE ENGINEER PRIOR TO THE COMMENCEMENT OF WORK









156 S. BROADWAY, SUITE 150 (209) 668-5520

PROJECT NO. 23-069

CITY OF TURLOCK ROADS PROGRAM

FY SCALE	DRAWN BY: JR	DRAWING	NO
1 "	REV. BY: AKM		
	CH. BY: AKM	48	
	DATE: 8/7/2025		
	SCALE: SEE SHEET	SHEET:	
	SEI PROJ NO: 22157	48 OF	11

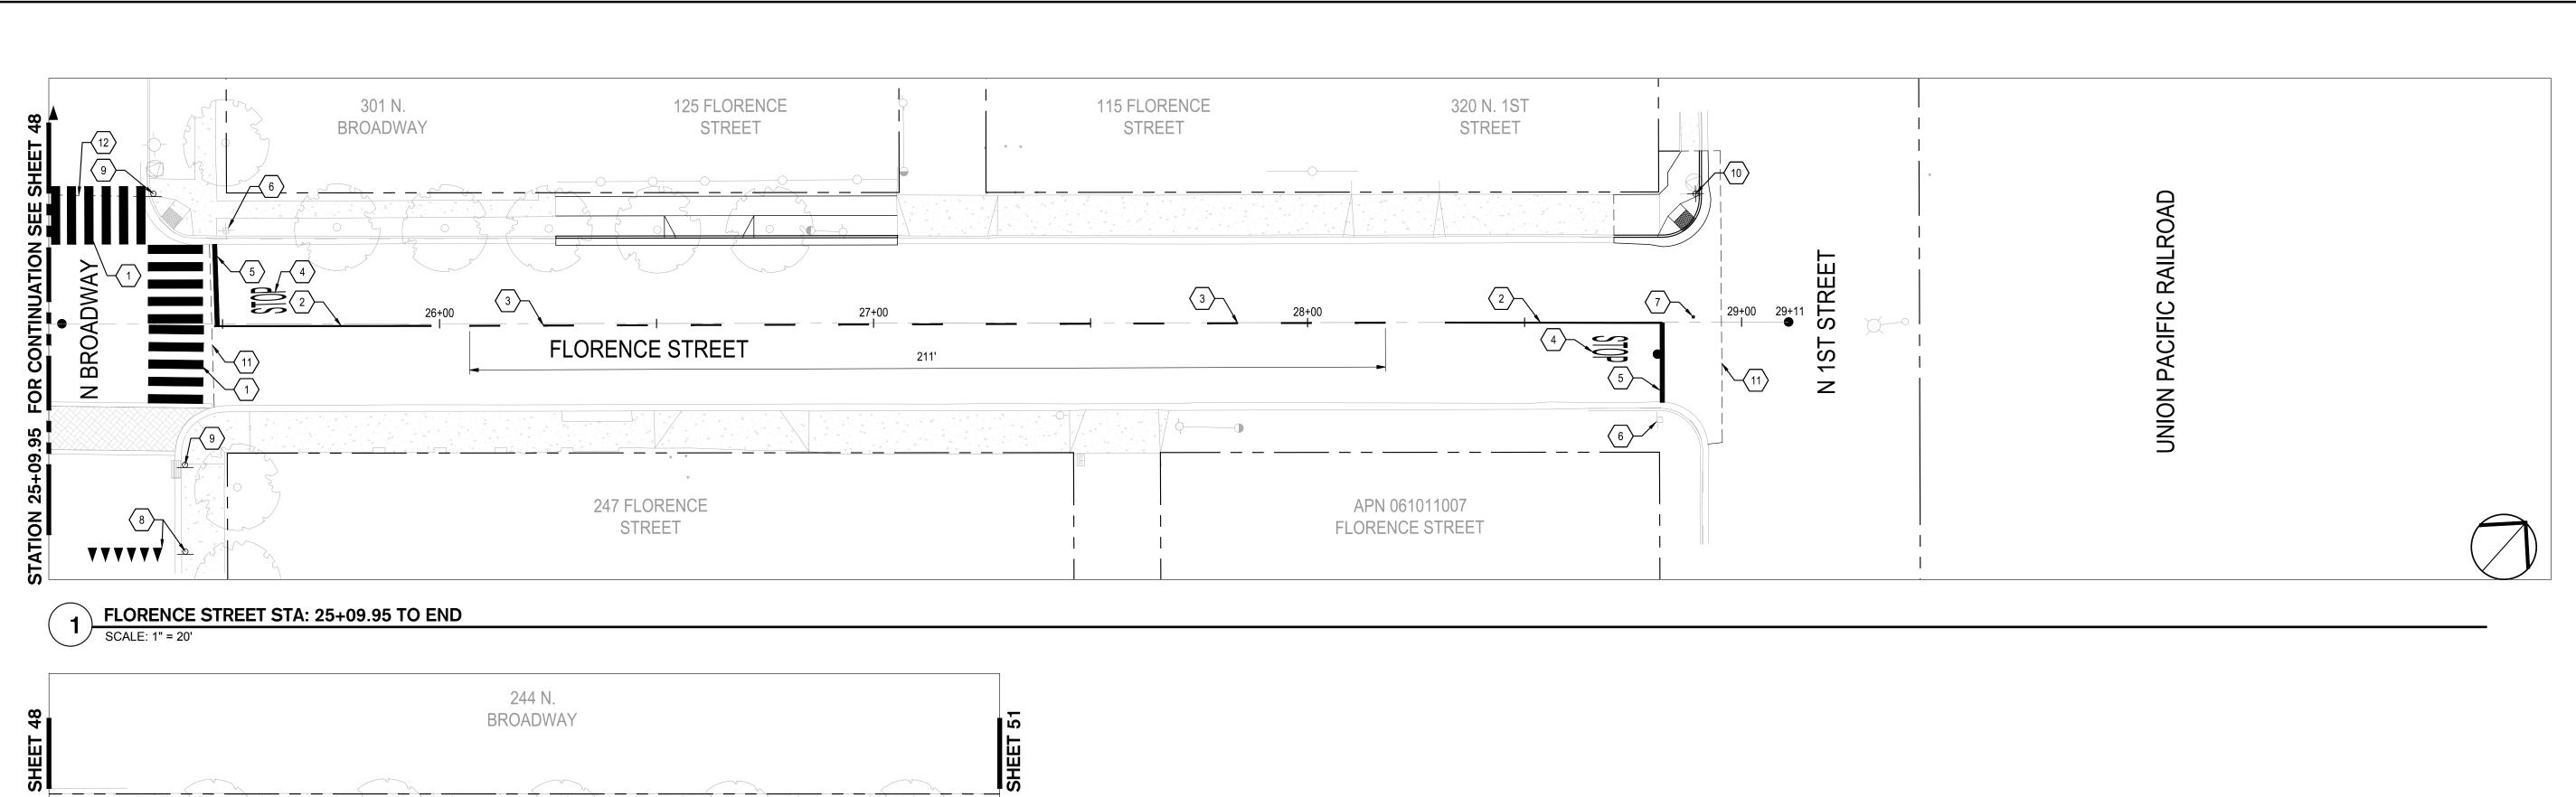

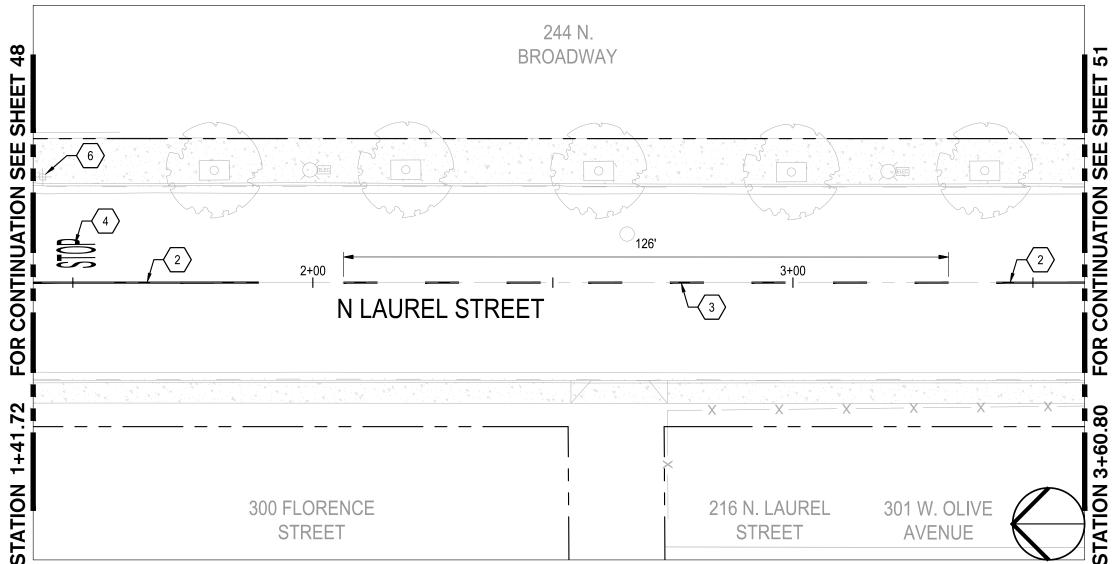

N. LAUREL STREET STA: 1+41.72 TO 3+60.80

SCALE: 1" = 20'

CONSTRUCTION KEYNOTES:


- INSTALL CROSSWALK PER CITY OF TURLOCK MODIFIED STD. C-17
- INSTALL 50 LF OF DETAIL 22 TRAFFIC LINES PER CALTRANS STANDARD DETAIL A20A
- INSTALL DETAIL 2 TRAFFIC LINES PER CALTRANS STANDARD DETAIL A20A
- INSTALL "STOP" MARKING PER CALTRANS STANDARD DETAIL A24D
- INSTALL LIMIT STOP LINE MARKING FROM CENTERLINE TO LIP OF GUTTER PER CALTRANS STANDARD DETAIL A24G
- REMAIN IN PLACE EXISTING POST AND SIGN
- INSTALL BLUE REFLECTIVE HYDRANT MARKER PER CITY OF TURLOCK STD. W-3
- INSTALL YIELD PAVEMENT MARKINGS AND R1-5 SIGNAGE PER CA MUTCD FIGURE 3B-17
- INSTALL POST AND W11-2 & W16-7P SIGN PANELS PER CA MUTCD
- REINSTALL POST AND STREET NAME SIGN PANELS PER CITY OF TURLOCK STANDARD DETAILS ST-10 THRU ST-12
- CONFORM TO EXISTING PAVEMENT. SEE DETAIL 2 ON SHEET 115.
- SLURRY SEAL LIMITS


NOTE:


FOR LAYOUT NOTES, REFER TO SHEET 47



ALL REFERENCES AND WRITTEN DIMENSIONS SHALL SUPERCEDE ALL SCALED DISTANCES AND SHALL BE VERIFIED IN THE FIELD. ANY DISCREPANCY SHALL BE BROUGHT TO THE ATTENTION OF THE ENGINEER PRIOR TO THE COMMENCEMENT OF WORK

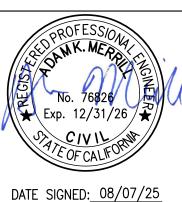

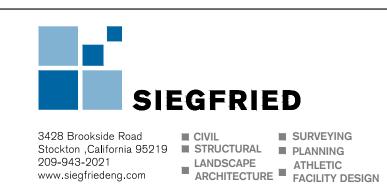

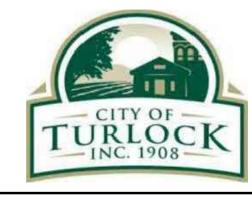


CITY OF TURLOCK MUNICIPAL SERVICES DEPARTMENT 156 S. BROADWAY, SUITE 150 (209) 668 - 5520

SIGNING AND STRIPING PLAN - FLORENCE STREET III

PROJECT NO. 23-069 CITY OF TURLOCK ROADS PROGRAM


VERIFY SCALE	DRAWN BY: JR	DRAWING NO.
0 1"	REV. BY: AKM	
	CH. BY: AKM	49
	DATE: 8/7/2025	
	SCALE: SEE SHEET	SHEET:
	SEI PROJ NO: 22157	49 OF 117

SCALE: 1"=20'

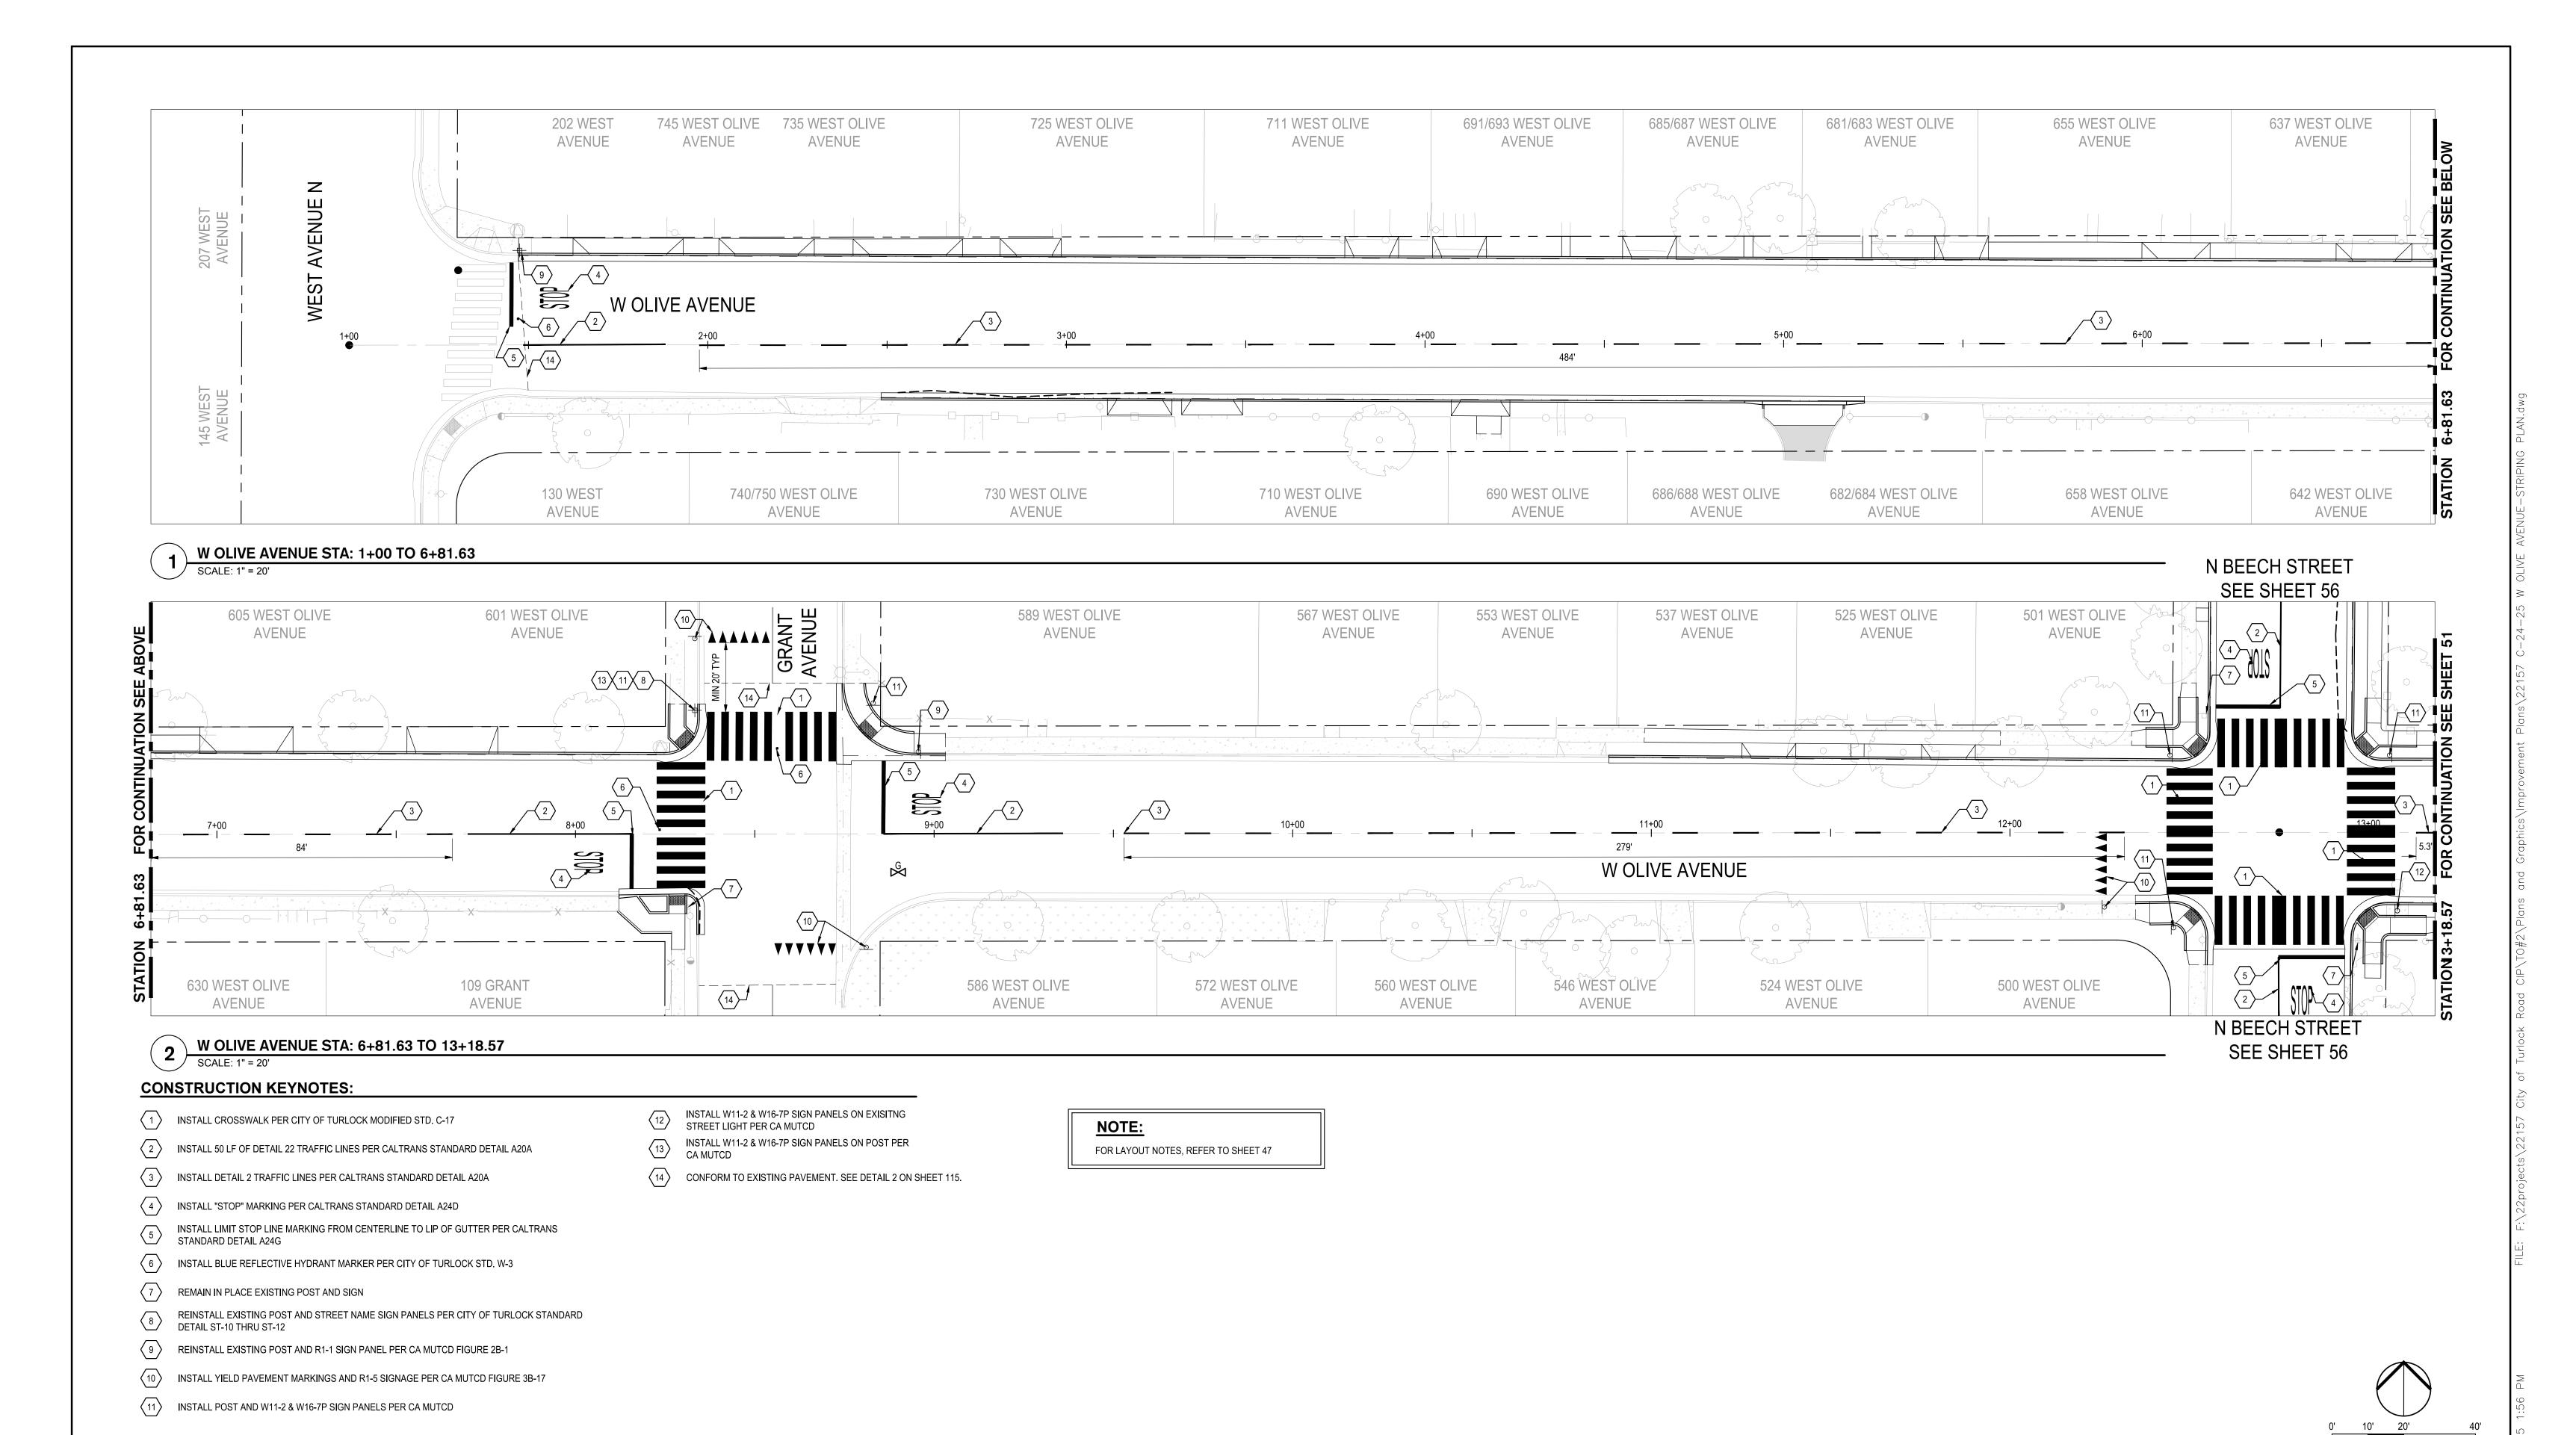




NOTE:
ALL REFERENCES AND WRITTEN
DIMENSIONS SHALL SUPERCEDE
ALL SCALED DISTANCES AND
SHALL BE VERIFIED IN THE
FIELD. ANY DISCREPANCY
SHALL BE BROUGHT TO THE
ATTENTION OF THE ENGINEER
PRIOR TO THE COMMENCEMENT
OF WORK

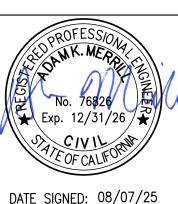



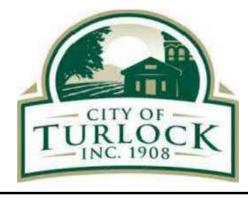

CITY OF TURLOCK MUNICIPAL SERVICES DEPARTMENT 156 S. BROADWAY, SUITE 150 (209) 668-5520


SIGNING AND STRIPING PLAN - W OLIVE AVE I


PROJECT NO. 23-069 CITY OF TURLOCK ROADS PROGRAM

JOALL	1 –20
DRAWN BY: JR	DRAWING NO
REV. BY: AKM	
CH. BY: AKM	50
DATE: 8/7/2025	
SCALE: SEE SHEET	SHEET:
SEI PROJ NO: 22157	50 OF 117
	DRAWN BY: JR REV. BY: AKM CH. BY: AKM DATE: 8/7/2025 SCALE: SEE SHEET

VERIFY SCALE


S AND STRIPING PLAN - W OLIVE AVE I

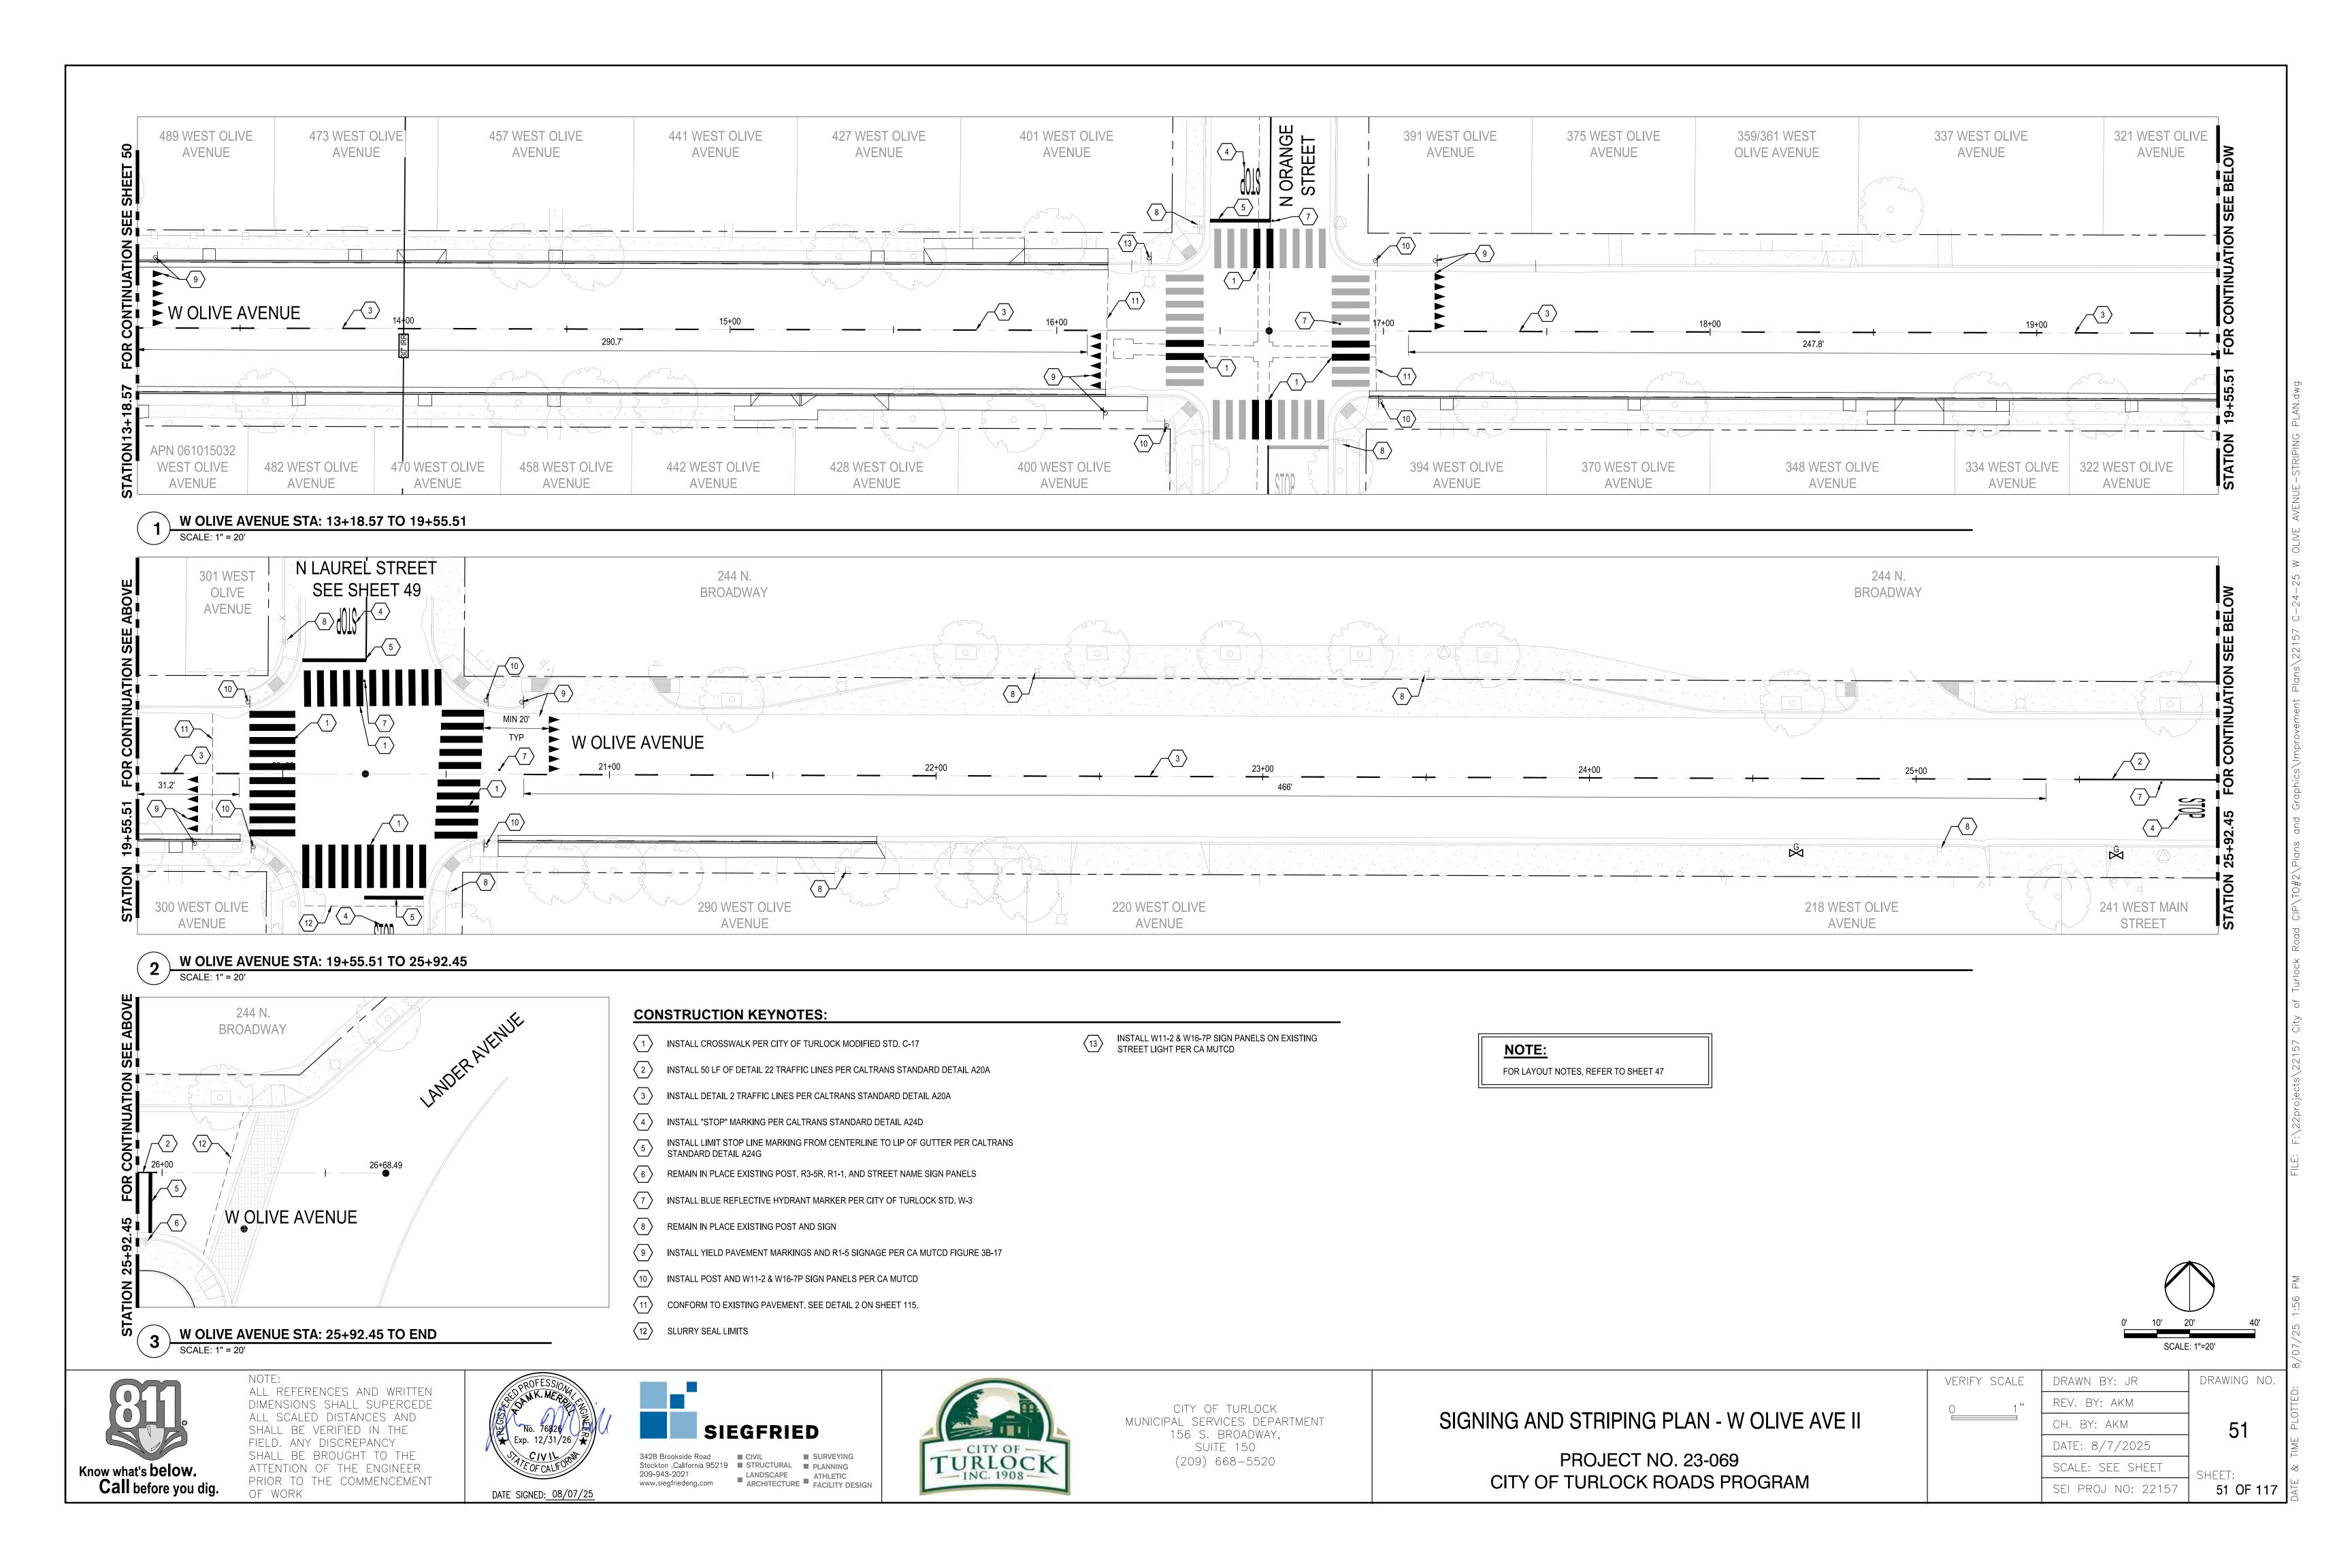

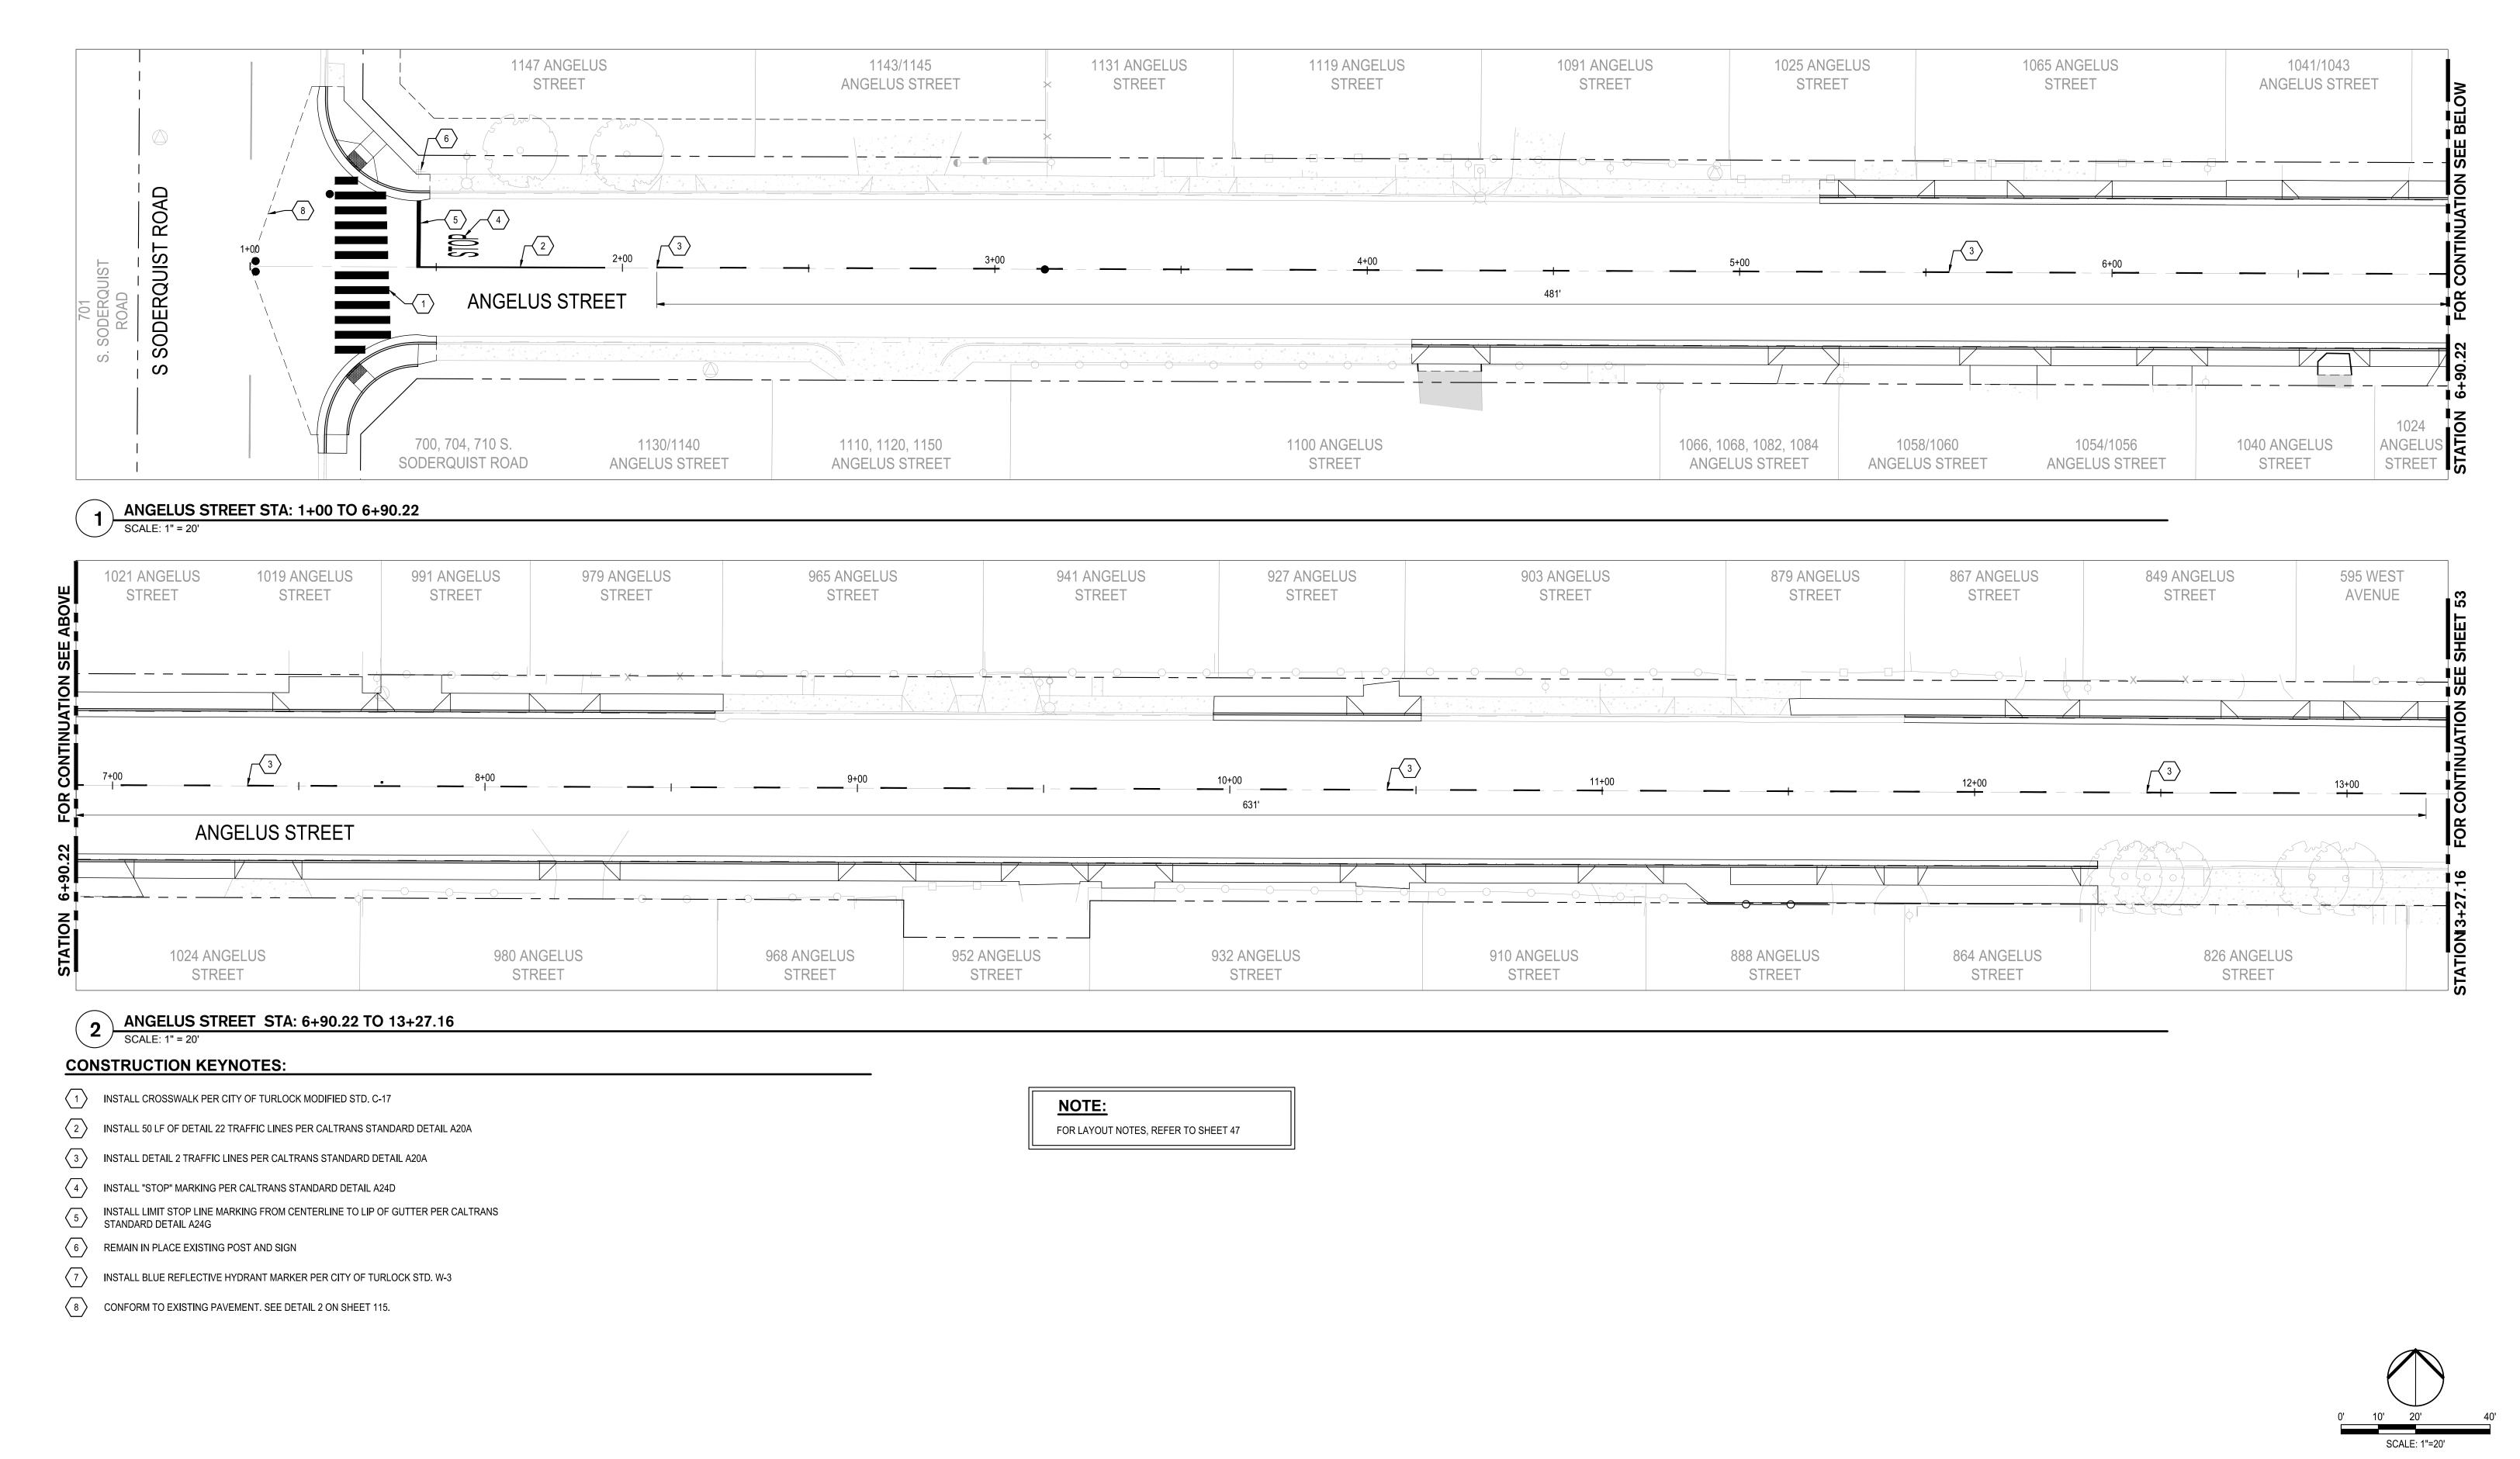




NOTE:
ALL REFERENCES AND WRITTEN
DIMENSIONS SHALL SUPERCEDE
ALL SCALED DISTANCES AND
SHALL BE VERIFIED IN THE
FIELD. ANY DISCREPANCY
SHALL BE BROUGHT TO THE
ATTENTION OF THE ENGINEER
PRIOR TO THE COMMENCEMENT
OF WORK

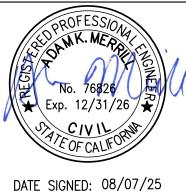



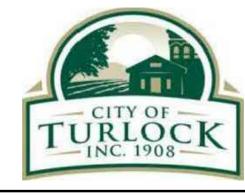

CITY OF TURLOCK
MUNICIPAL SERVICES DEPARTMENT
156 S. BROADWAY,
SUITE 150
(209) 668-5520

SIGNING AND STRIPING PLAN - ANGELUS STREET I

VERIFY SCALE

O

1"

REV. BY: AKM

CH. BY: AKM

DATE: 8/7/2025

SCALE: SEE SHEET

SEI PROJ NO: 22157


DRAWING NO.

52

SHEET:

SHEET:

52 OF 117

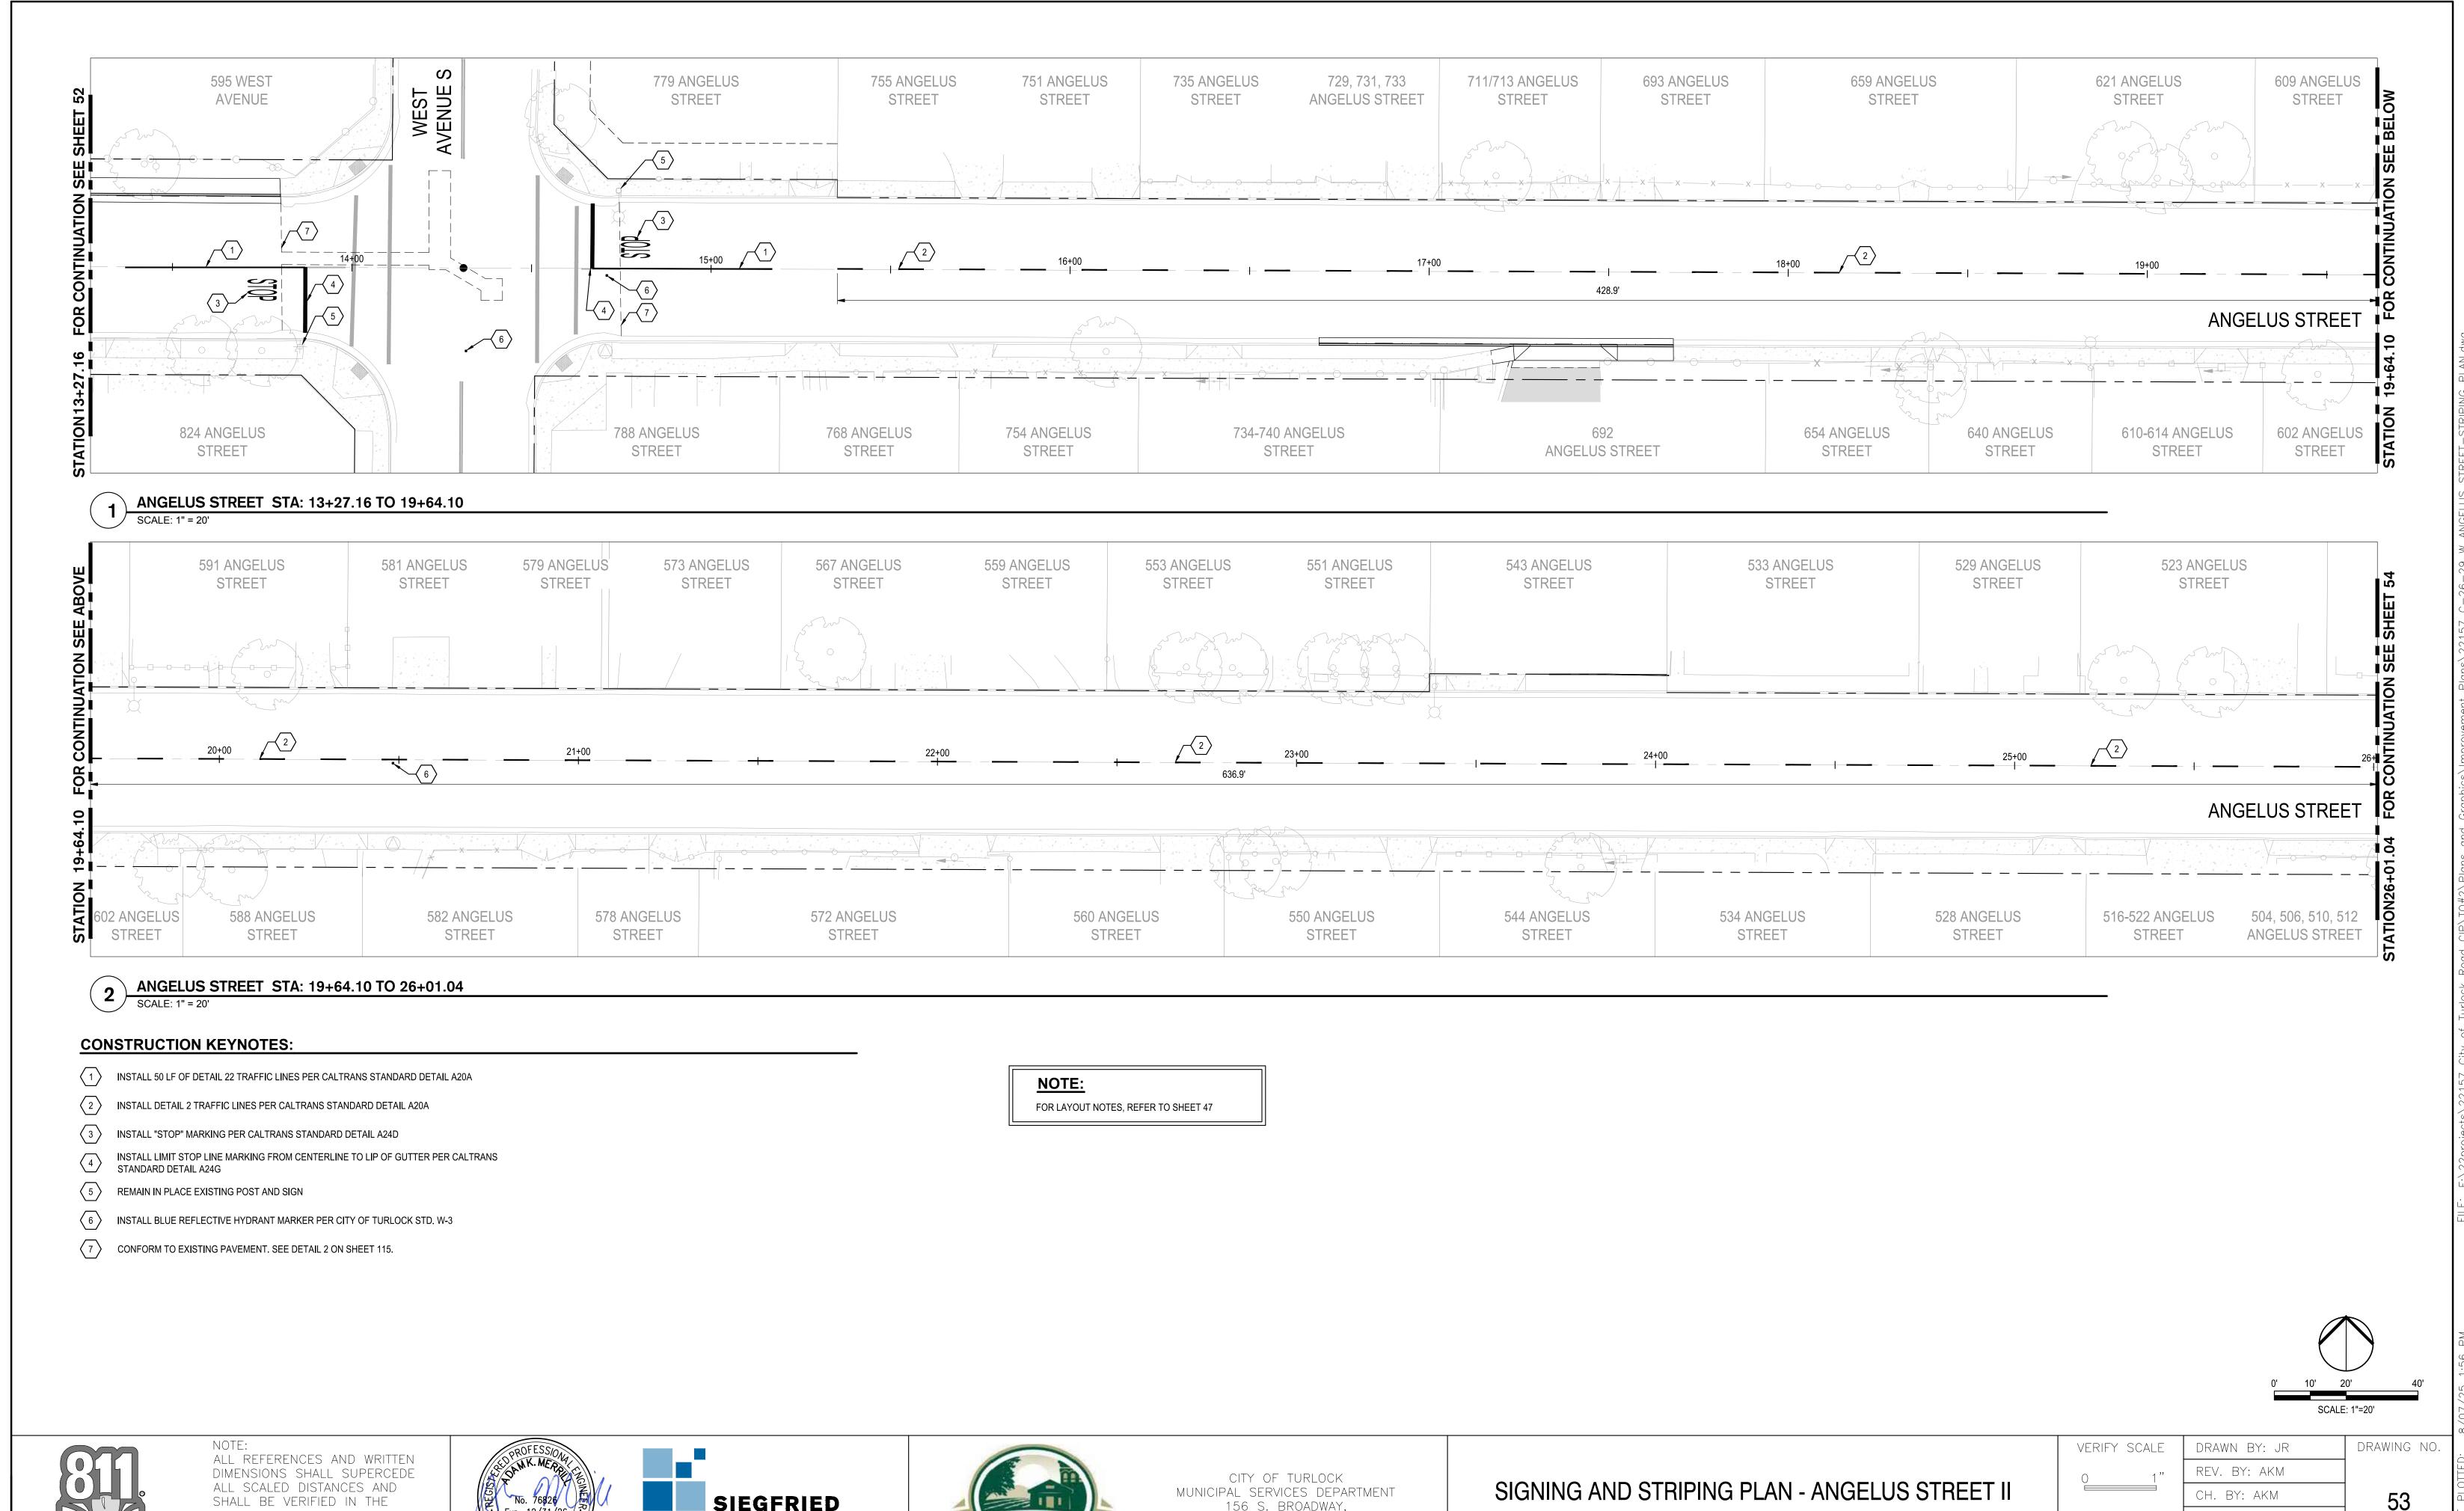

Know what's below. Call before you dig.

FIELD. ANY DISCREPANCY SHALL BE BROUGHT TO THE ATTENTION OF THE ENGINEER PRIOR TO THE COMMENCEMENT OF WORK








156 S. BROADWAY, SUITE 150 (209) 668 - 5520


PROJECT NO. 23-069

CITY OF TURLOCK ROADS PROGRAM

DATE: 8/7/2025 SCALE: SEE SHEET SHEET: SEI PROJ NO: 22157 53 OF 117

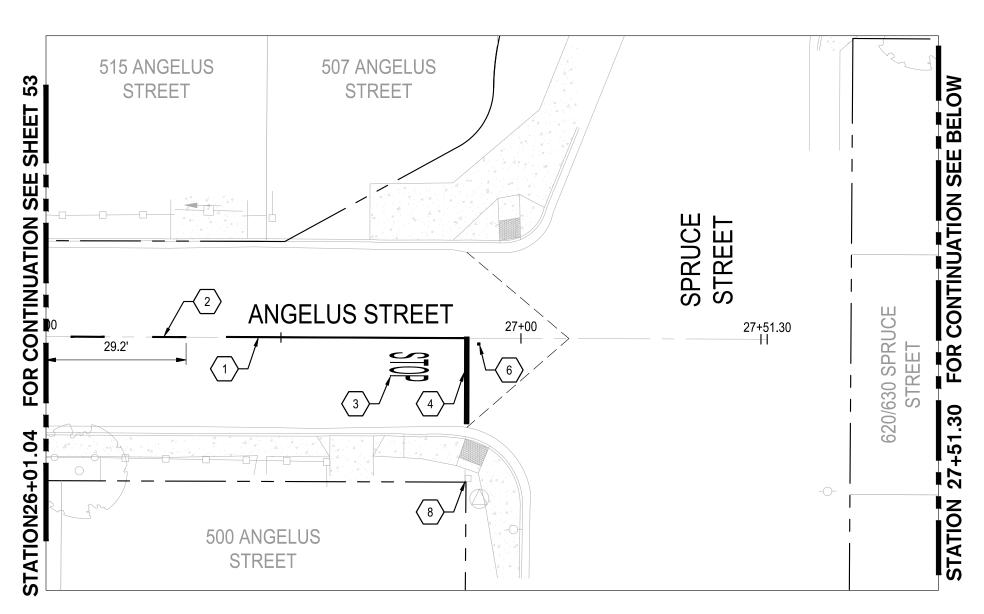

ANGELUS STREET STA: 26+01.04 TO 27+51.30

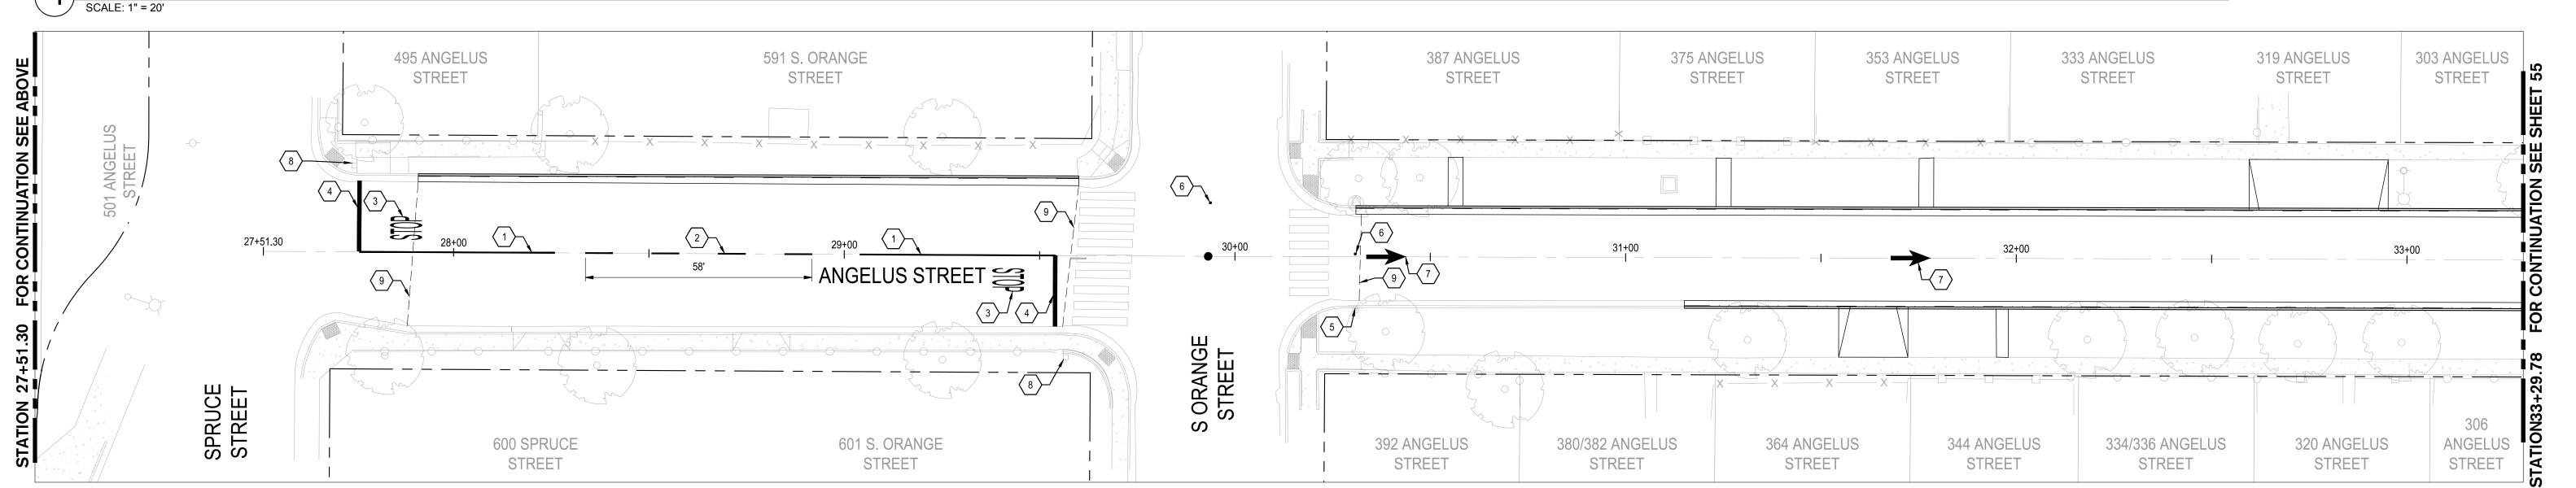

2 ANGELUS STREET STA: 27+51.30 TO 33+29.78

CONSTRUCTION KEYNOTES:


- 1 INSTALL 50 LF OF DETAIL 22 TRAFFIC LINES PER CALTRANS STANDARD DETAIL A20A
- 2 INSTALL DETAIL 2 TRAFFIC LINES PER CALTRANS STANDARD DETAIL A20A
- 3 INSTALL "STOP" MARKING PER CALTRANS STANDARD DETAIL A24D
- INSTALL LIMIT STOP LINE MARKING FROM CENTERLINE TO LIP OF GUTTER PER CALTRANS STANDARD DETAIL A24G
- STANDARD DETAIL A24G
- 5 REMAIN IN PLACE EXISTING R6-1R SIGN PANEL AND POST
- 6 INSTALL BLUE REFLECTIVE HYDRANT MARKER PER CITY OF TURLOCK STD. W-3
- 7 INSTALL TYPE I 10' ARROW PER CALTRANS STANDARD DETAIL A24A
- 8 REMAIN IN PLACE EXISTING POST AND SIGN
- 9 CONFORM TO EXISTING PAVEMENT. SEE DETAIL 2 ON SHEET 115.


NOTE:


FOR LAYOUT NOTES, REFER TO SHEET 47



NOTE:
ALL REFERENCES AND WRITTEN
DIMENSIONS SHALL SUPERCEDE
ALL SCALED DISTANCES AND
SHALL BE VERIFIED IN THE
FIELD. ANY DISCREPANCY
SHALL BE BROUGHT TO THE
ATTENTION OF THE ENGINEER
PRIOR TO THE COMMENCEMENT
OF WORK

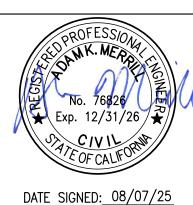

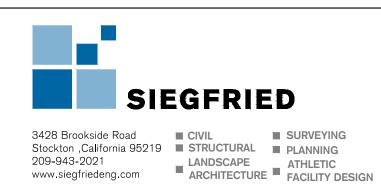

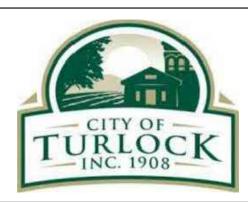


CITY OF TURLOCK MUNICIPAL SERVICES DEPARTMENT 156 S. BROADWAY, SUITE 150 (209) 668-5520


SIGNING AND STRIPING PLAN - ANGELUS STREET III

DRAWN BY: JR	DRAWING NO
REV. BY: AKM	
CH. BY: AKM	54
DATE: 8/7/2025	
SCALE: SEE SHEET	SHEET:
SEI PROJ NO: 22157	54 OF 11
	REV. BY: AKM CH. BY: AKM DATE: 8/7/2025 SCALE: SEE SHEET

10' 20' 40' SCALE: 1"=20'

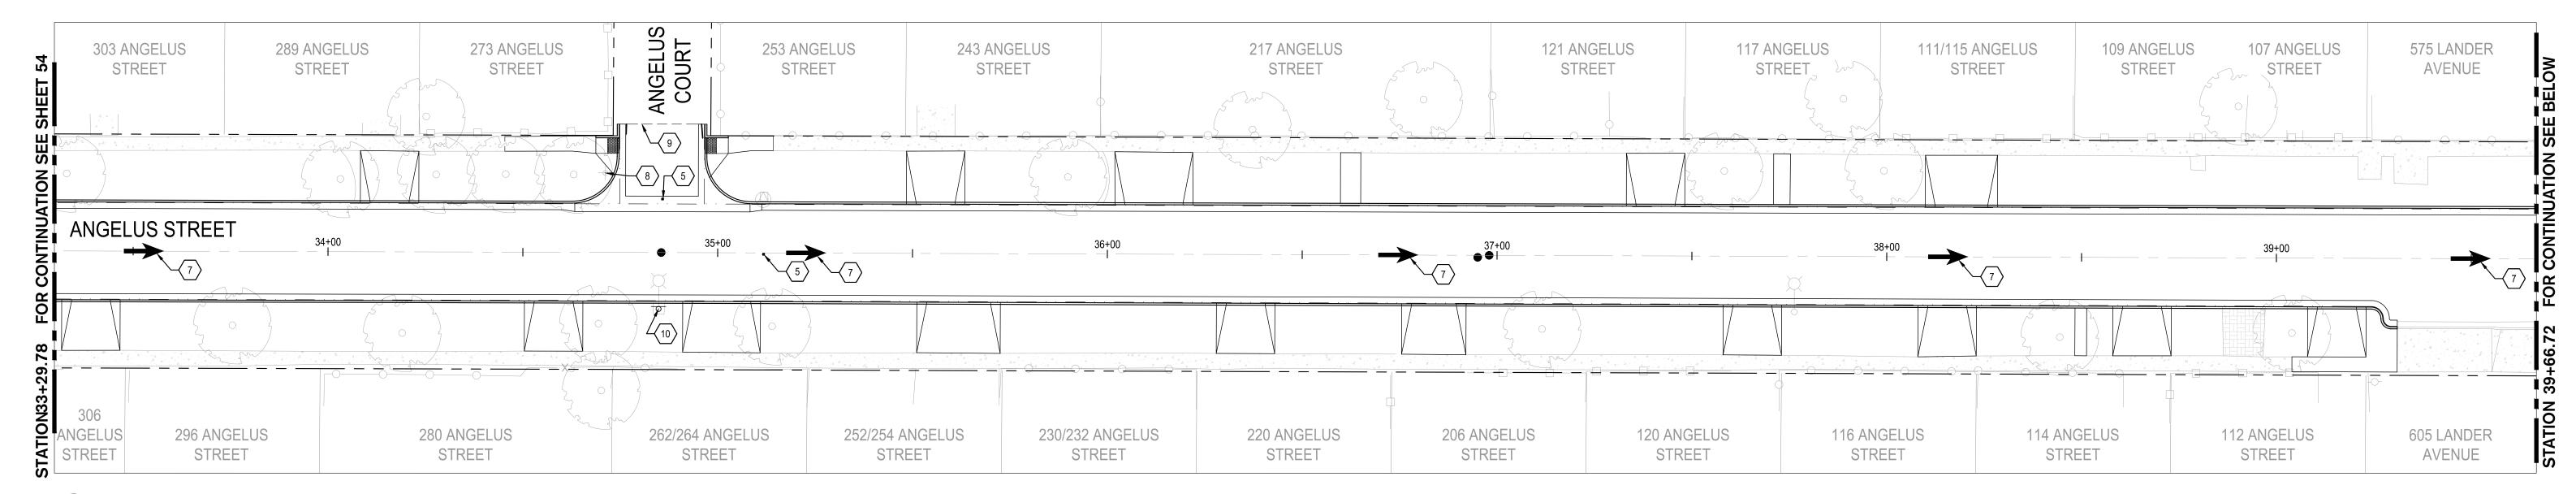

ANGELUS STREET STA: 33+29.78 TO 39+66.72

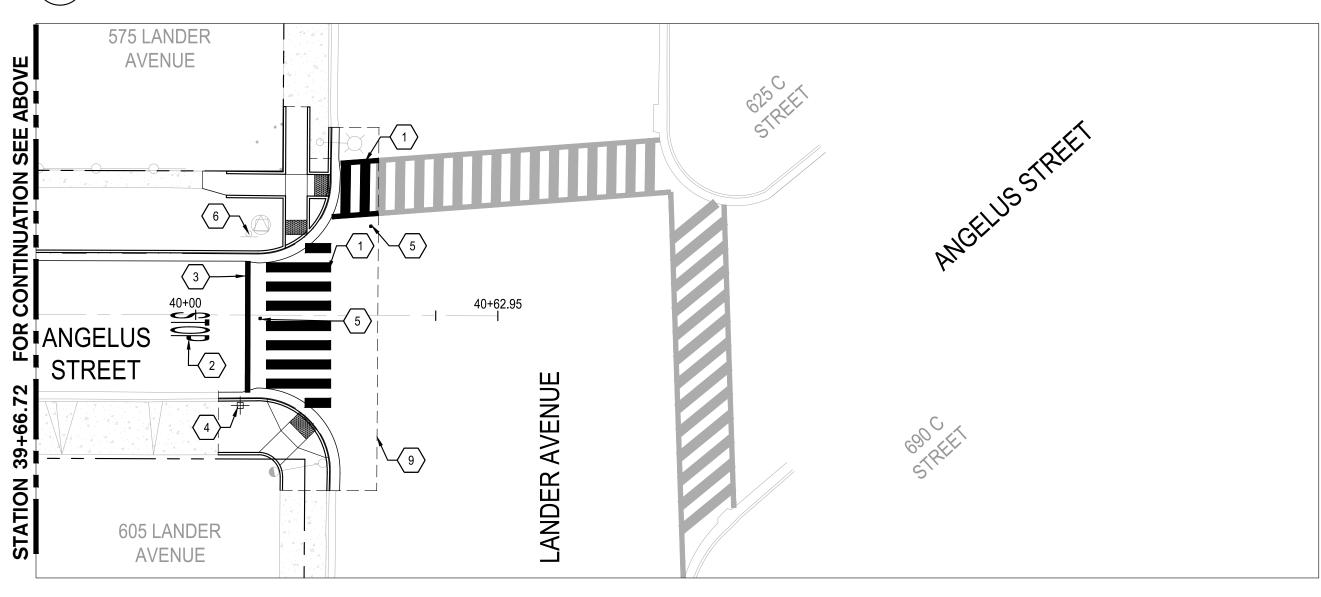

ANGELUS STREET STA: 39+66.72 TO END

CONSTRUCTION KEYNOTES:


- INSTALL CROSSWALK PER CITY OF TURLOCK MODIFIED STD. C-17
- INSTALL "STOP" MARKING PER CALTRANS STANDARD DETAIL A24D
- INSTALL LIMIT STOP LINE MARKING FROM CENTERLINE TO LIP OF GUTTER PER CALTRANS STANDARD DETAIL A24G
- REINSTALL EXISTING POST AND R1-1 SIGN PANEL PER CA MUTCD FIGURE 2B-1. REINSTALL EXISTING R5-1 AND R6-1L ON POST PER CITY OF TURLOCK STANDARD DETAILS
- INSTALL BLUE REFLECTIVE HYDRANT MARKER PER CITY OF TURLOCK STD. W-3
- REMAIN IN PLACE EXISTING POST, R5-1, R6-1R, AND STREET NAME SIGN PANELS
- INSTALL TYPE I 10' ARROW PER CALTRANS STANDARD DETAIL A24A
- REMAIN IN PLACE EXISTING POST AND SIGN
- CONFORM TO EXISTING PAVEMENT. SEE DETAIL 2 ON SHEET 115.
- 10 INSTALL R6-1L SIGN PANEL ON EXISTING STREET LIGHT PER CA MUTCD

NOTE:

FOR LAYOUT NOTES, REFER TO SHEET 47



ALL REFERENCES AND WRITTEN DIMENSIONS SHALL SUPERCEDE ALL SCALED DISTANCES AND SHALL BE VERIFIED IN THE FIELD. ANY DISCREPANCY SHALL BE BROUGHT TO THE ATTENTION OF THE ENGINEER PRIOR TO THE COMMENCEMENT OF WORK

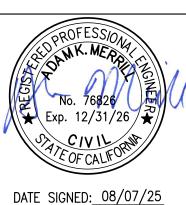






CITY OF TURLOCK MUNICIPAL SERVICES DEPARTMENT 156 S. BROADWAY, SUITE 150 (209) 668 - 5520

SIGNING AND STRIPING PLAN - ANGELUS STREET IV

	SCALE	. 1 - 20
ERIFY SCALE	DRAWN BY: JR	DRAWING NC
1 "	REV. BY: AKM	
	CH. BY: AKM	55
	DATE: 8/7/2025	
	SCALE: SEE SHEET	SHEET:
	SEI PROJ NO: 22157	55 OF 11

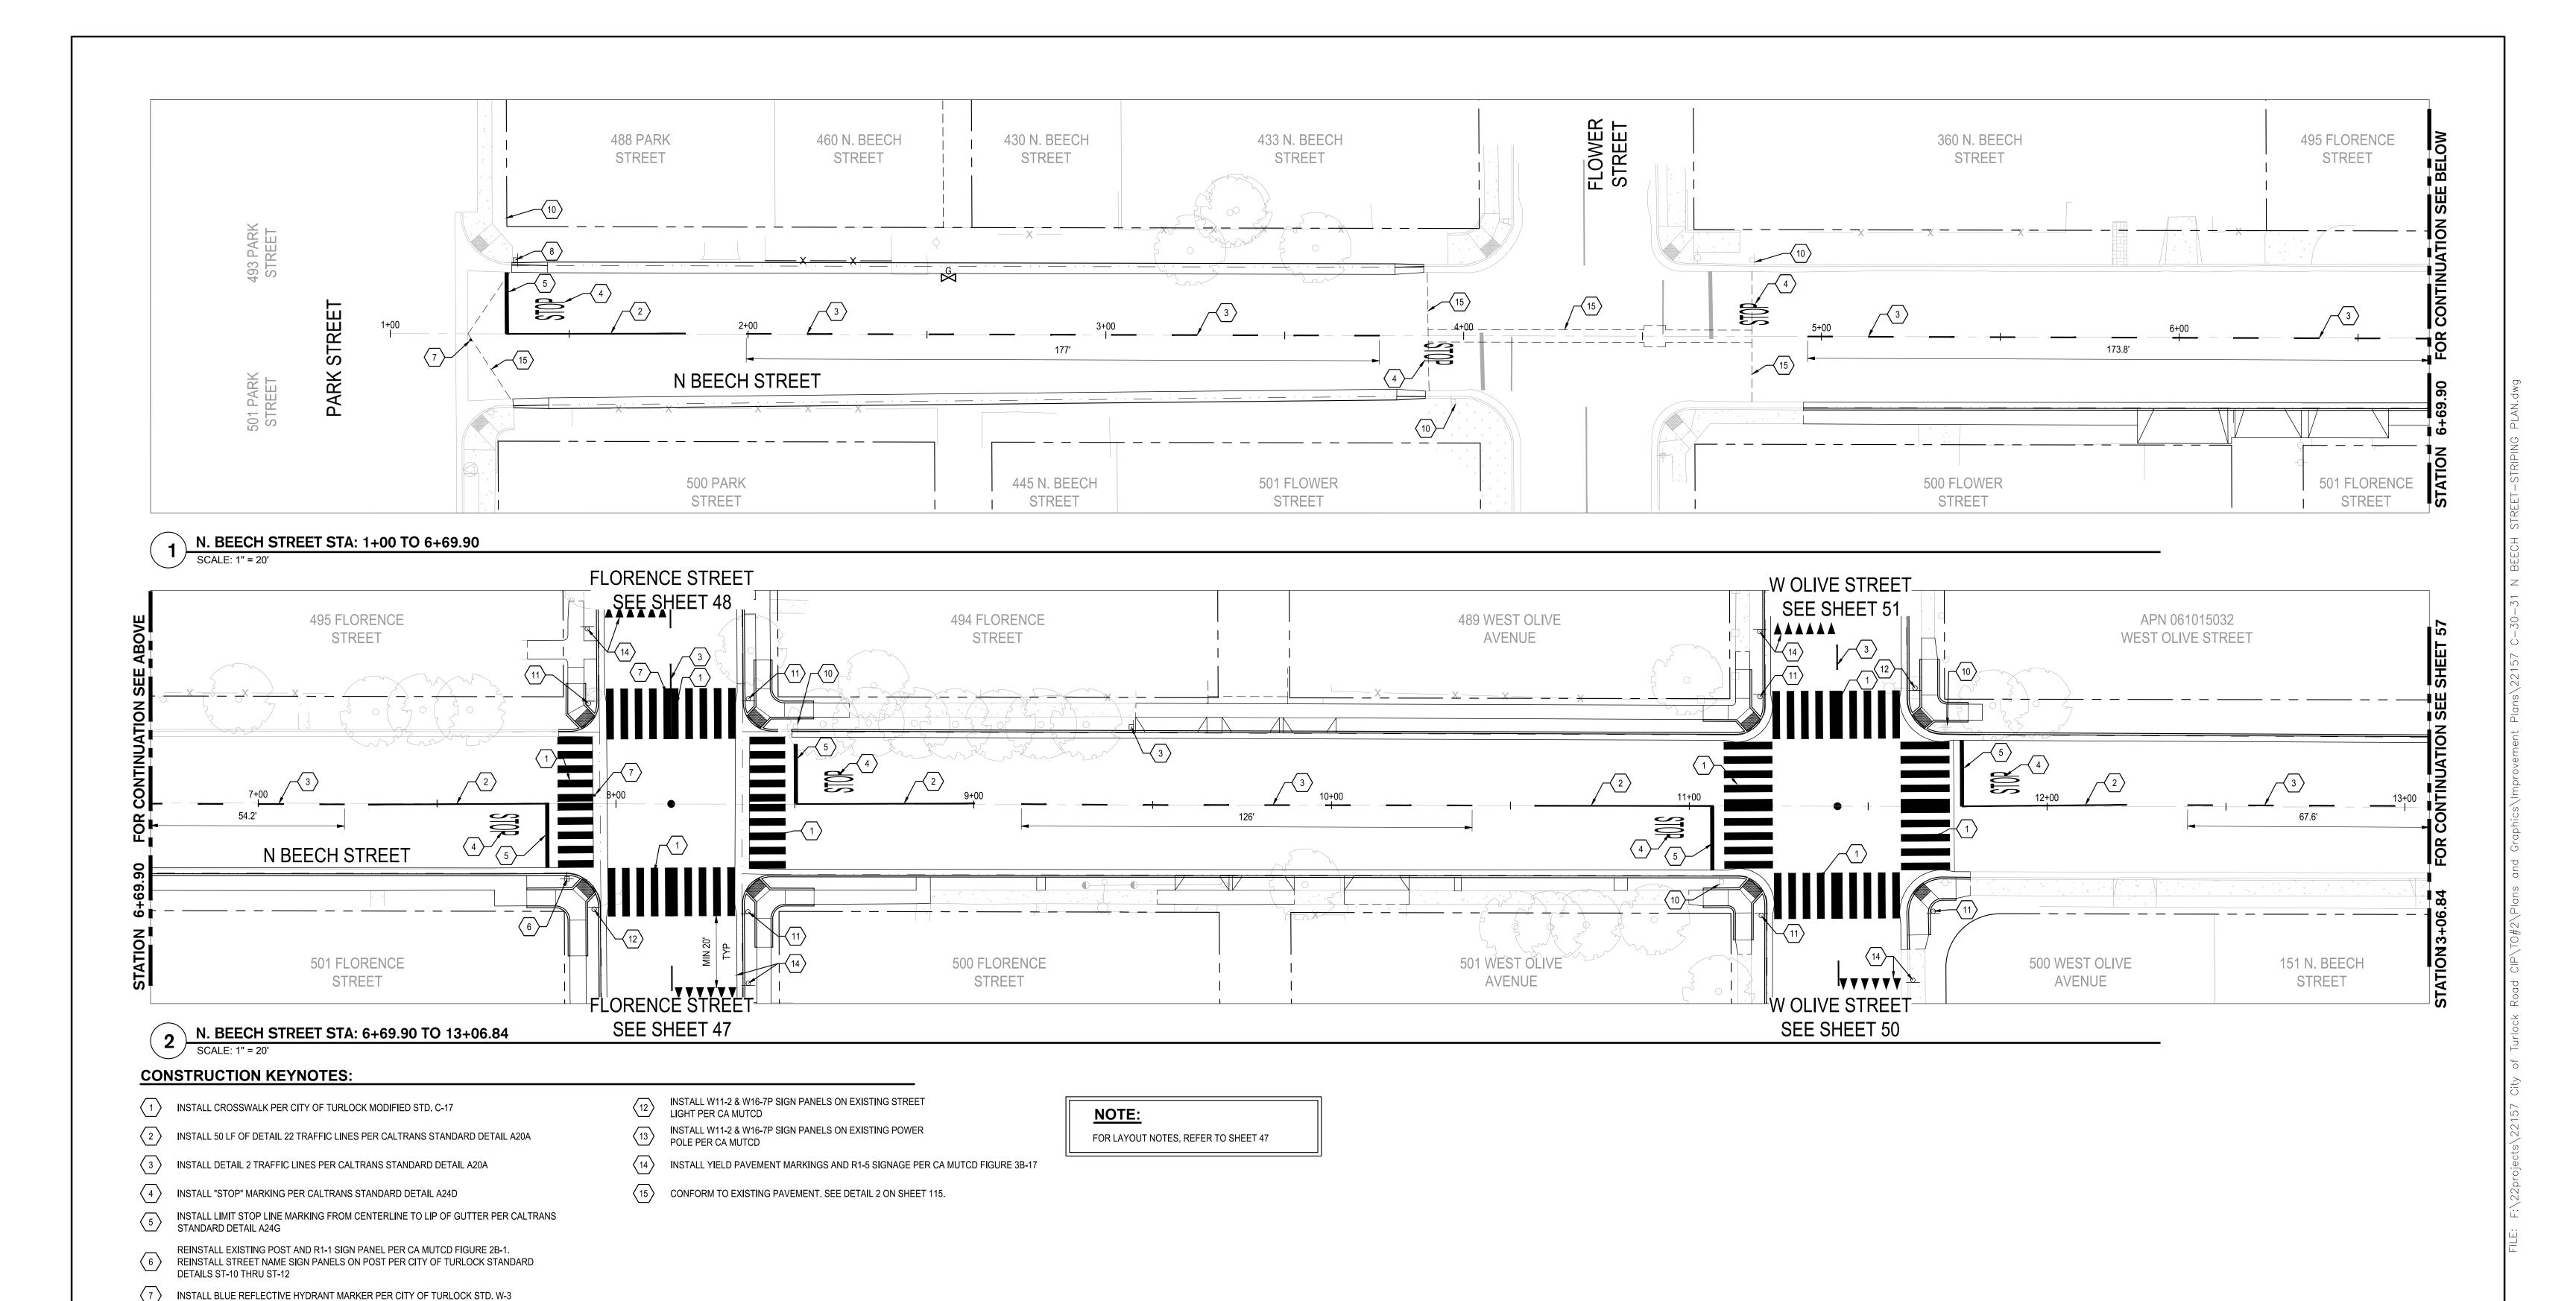



ALL REFERENCES AND WRITTEN DIMENSIONS SHALL SUPERCEDE ALL SCALED DISTANCES AND SHALL BE VERIFIED IN THE FIELD. ANY DISCREPANCY SHALL BE BROUGHT TO THE ATTENTION OF THE ENGINEER PRIOR TO THE COMMENCEMENT OF WORK

REINSTALL POST AND R1-1 SIGN PANEL PER CA MUTCD FIGURE 2B-1


INSTALL POST AND W11-2 & W16-7P SIGN PANELS PER CA MUTCD

REINSTALL POST AND W3-1 SIGN PANEL PER CA MUTCD

REMAIN IN PLACE EXISTING POST AND SIGN





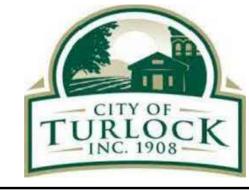

CITY OF TURLOCK MUNICIPAL SERVICES DEPARTMENT 156 S. BROADWAY, SUITE 150 (209) 668 - 5520

SCALE: 1"=20' VERIFY SCALE DRAWING NO. DRAWN BY: JR REV. BY: AKM CH. BY: AKM DATE: 8/7/2025 SCALE: SEE SHEET SHEET: SEI PROJ NO: 22157 56 OF 117

SIGNING AND STRIPING PLAN - N BEECH STREET I

PROJECT NO. 23-069

CITY OF TURLOCK ROADS PROGRAM

N. BEECH STREET STA: 13+06.84 TO END

CONSTRUCTION KEYNOTES:


1) INSTALL DETAIL 2 TRAFFIC LINES PER CALTRANS STANDARD DETAIL A20A


2 REMAIN IN PLACE EXISTING POST, W4-4P, R1-1, AND STREET NAME SIGN PANELS

CONFORM TO EXISTING PAVEMENT. SEE DETAIL 2 ON SHEET 115.


NOTE:

FOR LAYOUT NOTES, REFER TO SHEET 47

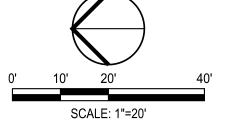


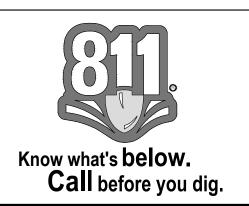

NOTE:
ALL REFERENCES AND WRITTEN
DIMENSIONS SHALL SUPERCEDE
ALL SCALED DISTANCES AND
SHALL BE VERIFIED IN THE
FIELD. ANY DISCREPANCY
SHALL BE BROUGHT TO THE
ATTENTION OF THE ENGINEER
PRIOR TO THE COMMENCEMENT
OF WORK

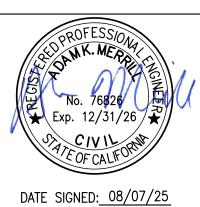



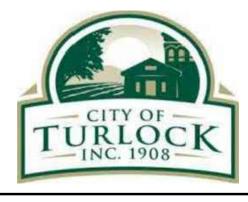


CITY OF TURLOCK MUNICIPAL SERVICES DEPARTMENT 156 S. BROADWAY, SUITE 150 (209) 668-5520

SIGNING AND STRIPING PLAN - N BEECH STREET II
PROJECT NO. 23-069

CITY OF TURLOCK ROADS PROGRAM

VERIFY	SCALE	DRAV
0	1 "	REV.
		CH.
		DATE

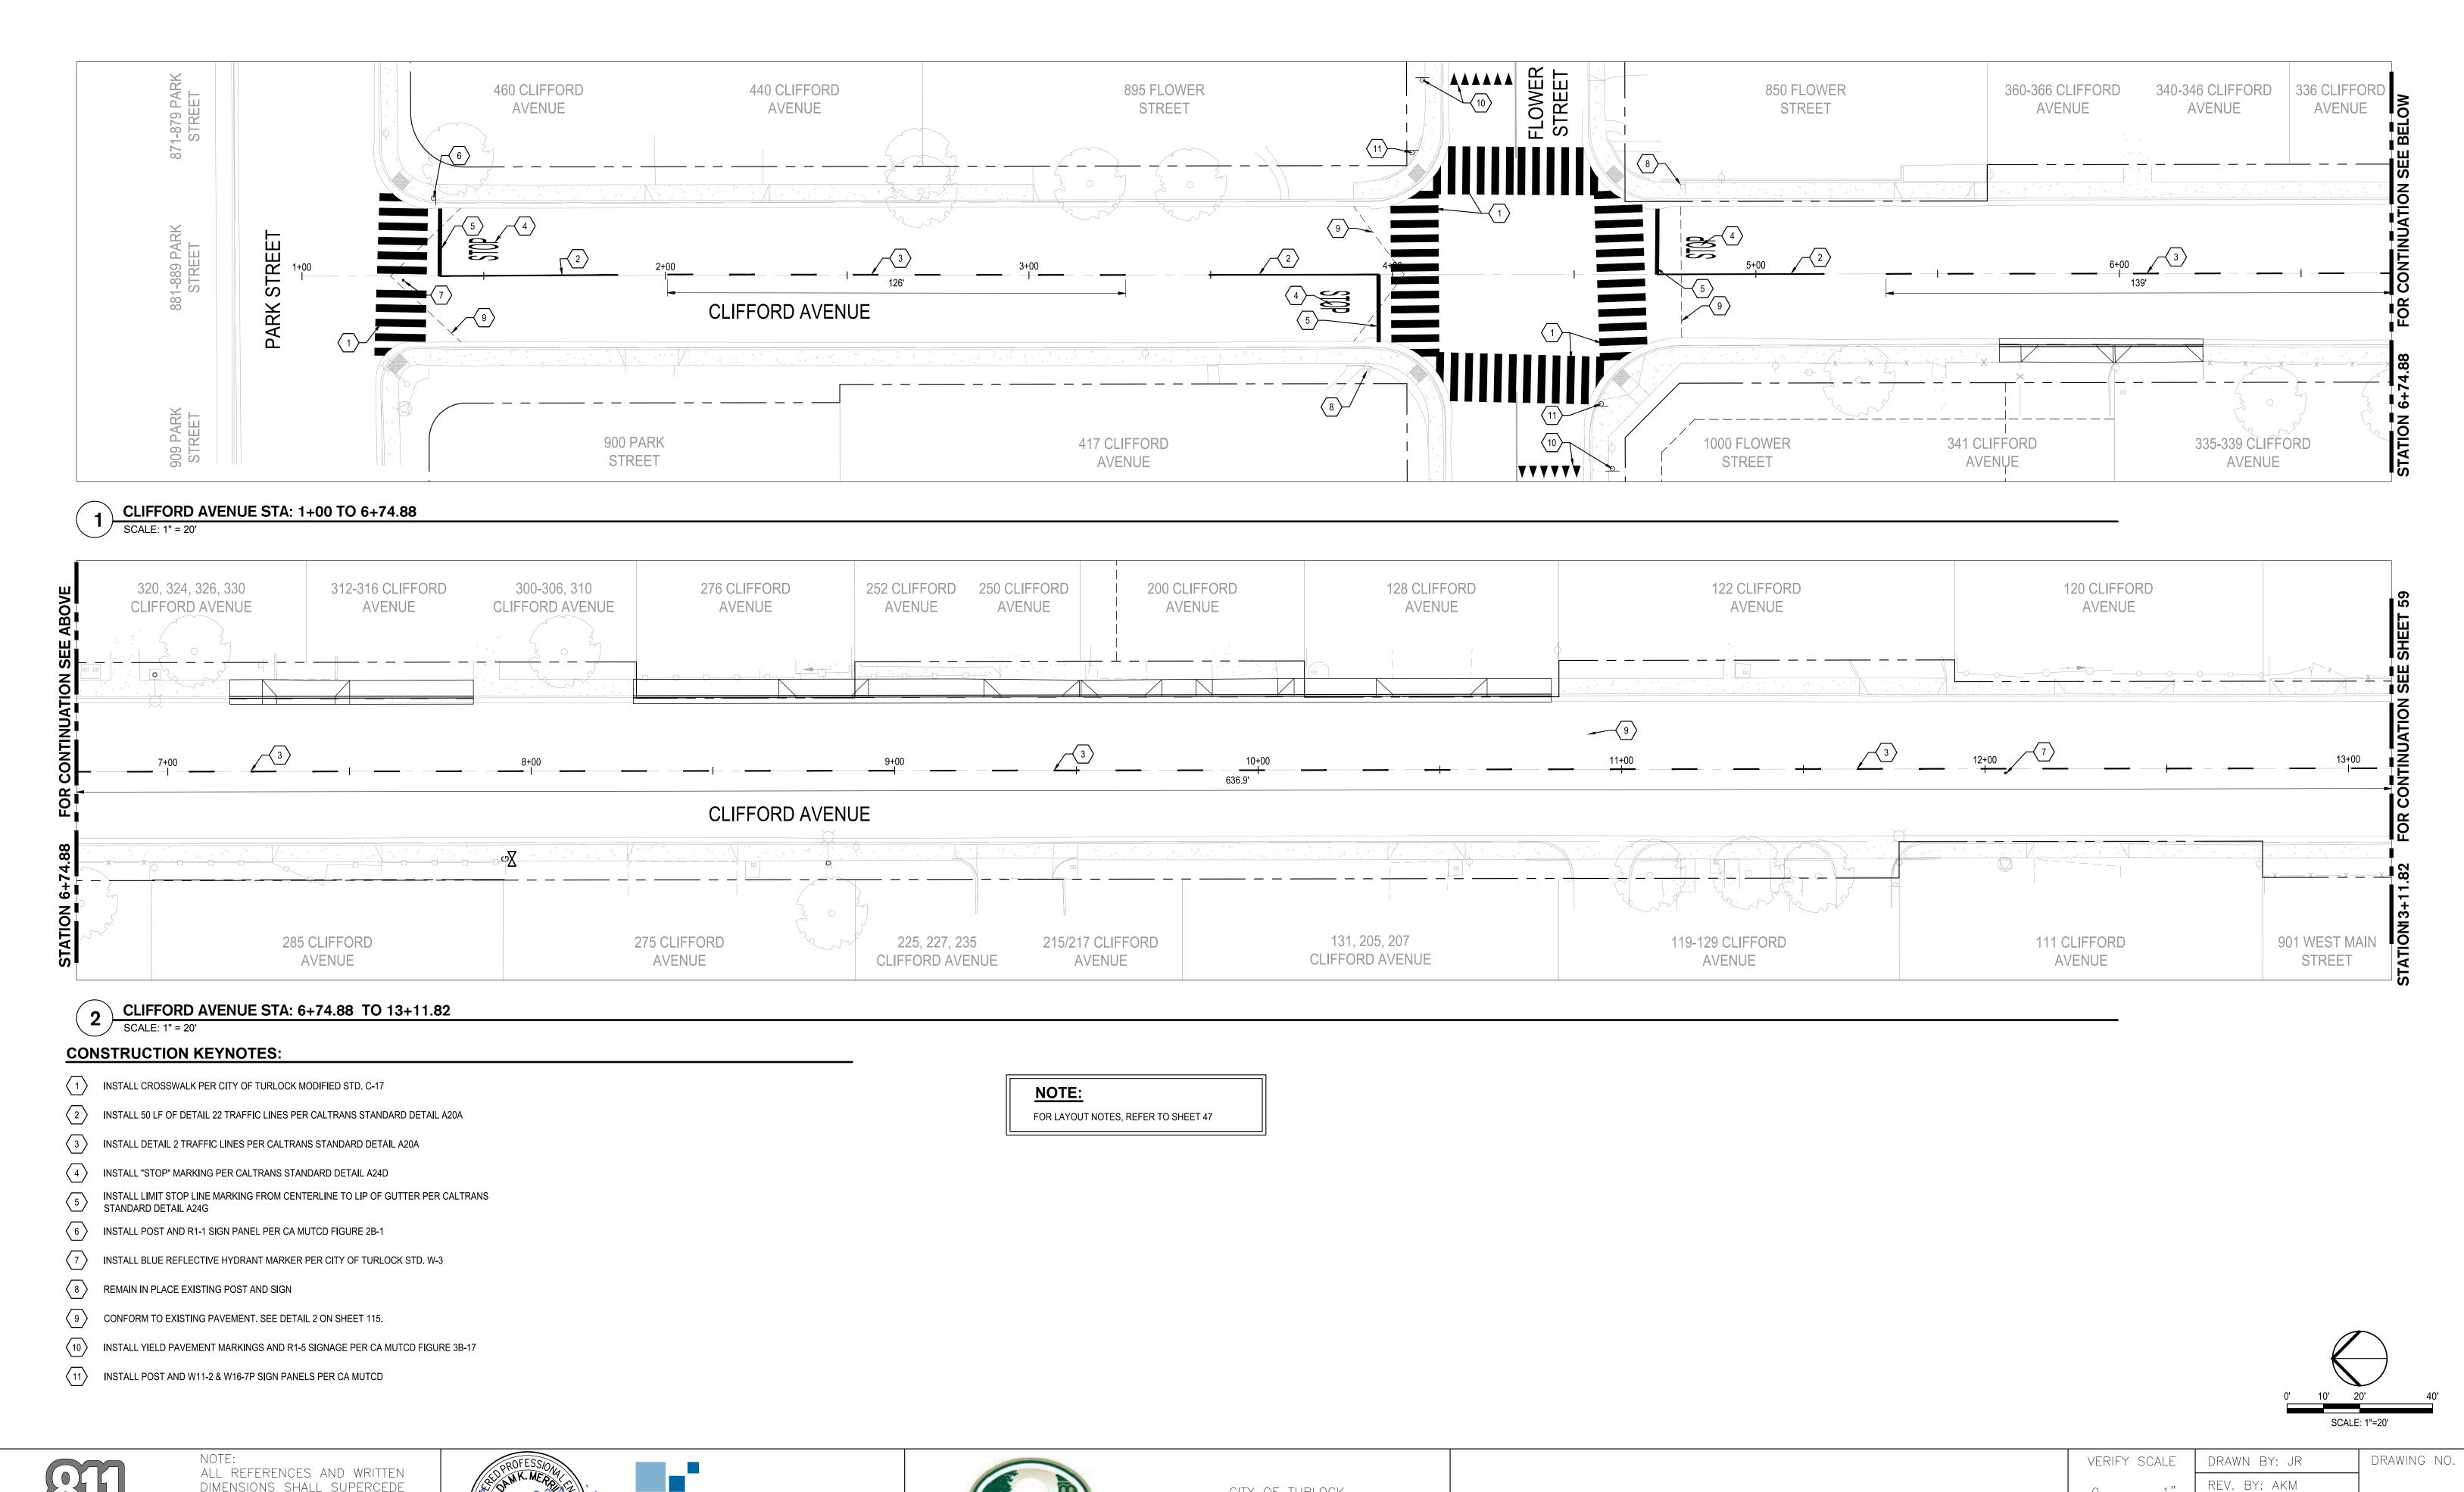



DIMENSIONS SHALL SUPERCEDE ALL SCALED DISTANCES AND SHALL BE VERIFIED IN THE FIELD. ANY DISCREPANCY SHALL BE BROUGHT TO THE ATTENTION OF THE ENGINEER PRIOR TO THE COMMENCEMENT OF WORK





www.siegfriedeng.com



CITY OF TURLOCK MUNICIPAL SERVICES DEPARTMENT 156 S. BROADWAY, SUITE 150 (209) 668 - 5520

SIGNING AND STRIPING PLAN - CLIFFORD AVENUE I

DRAWING NO.	DRAWN BY: JR	IFY SCALE
	REV. BY: AKM	1 "
58	CH. BY: AKM	
	DATE: 8/7/2025	
] SHEET:	SCALE: SEE SHEET	
58 OF 117	SEI PROJ NO: 22157	

CLIFFORD AVENUE STA: 13+11.82 TO END

CONSTRUCTION KEYNOTES:

- 1) INSTALL 50 LF OF DETAIL 22 TRAFFIC LINES PER CALTRANS STANDARD DETAIL A20A
- INSTALL DETAIL 2 TRAFFIC LINES PER CALTRANS STANDARD DETAIL A20A
- 3 INSTALL "STOP" MARKING PER CALTRANS STANDARD DETAIL A24D
- INSTALL LIMIT STOP LINE MARKING FROM CENTERLINE TO LIP OF GUTTER PER CALTRANS STANDARD DETAIL A24G
- INSTALL BLUE REFLECTIVE HYDRANT MARKER PER CITY OF TURLOCK STD. W-3
- 6 SLURRY SEAL LIMITS

NOTE:


FOR LAYOUT NOTES, REFER TO SHEET 47



ALL REFERENCES AND WRITTEN
DIMENSIONS SHALL SUPERCEDE
ALL SCALED DISTANCES AND
SHALL BE VERIFIED IN THE
FIELD. ANY DISCREPANCY
SHALL BE BROUGHT TO THE
ATTENTION OF THE ENGINEER PRIOR TO THE COMMENCEMENT OF WORK





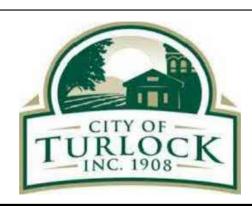

CITY OF TURLOCK MUNICIPAL SERVICES DEPARTMENT 156 S. BROADWAY, SUITE 150 (209) 668-5520

SIGNING AND STRIPING PLAN - CLIFFORD AVENUE II

PROJECT NO. 23-069 CITY OF TURLOCK ROADS PROGRAM

	0'	10' 2	0' 40'
		SCALE	: 1"=20'
VERIFY SCALE	DRAWN BY: JR		DRAWING N
0 1"	REV. BY: AKM		
	CH. BY: AKM		59
	ı		

DATE: 8/7/2025 SCALE: SEE SHEET SEI PROJ NO: 22157 59 OF 117

1 THE BURL STA: 1+00 TO END

SCALE: 1" = 20'

CONSTRUCTION KEYNOTES:

1) INSTALL 50 LF OF DETAIL 22 TRAFFIC LINES PER CALTRANS STANDARD DETAIL A20A

2 INSTALL "STOP" MARKING PER CALTRANS STANDARD DETAIL A24D

INSTALL LIMIT STOP LINE MARKING FROM CENTERLINE TO LIP OF GUTTER PER CALTRANS STANDARD DETAIL A24G

4 INSTALL POST AND R1-1 SIGN PANEL PER CA MUTCD FIGURE 2B-1

5 INSTALL BLUE REFLECTIVE HYDRANT MARKER PER CITY OF TURLOCK STD. W-3

6 CONFORM TO EXISTING PAVEMENT. SEE DETAIL 2 ON SHEET 115.


7 INSTALL CROSSWALK PER CITY OF TURLOCK MODIFIED STD. C-17


NOTE:

FOR LAYOUT NOTES, REFER TO SHEET 47



NOTE:
ALL REFERENCES AND WRITTEN
DIMENSIONS SHALL SUPERCEDE
ALL SCALED DISTANCES AND
SHALL BE VERIFIED IN THE
FIELD. ANY DISCREPANCY
SHALL BE BROUGHT TO THE
ATTENTION OF THE ENGINEER
PRIOR TO THE COMMENCEMENT
OF WORK

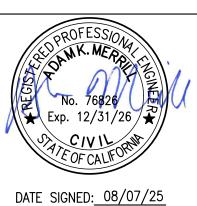

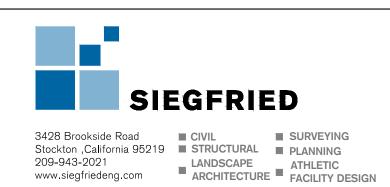




CITY OF TURLOCK MUNICIPAL SERVICES DEPARTMENT 156 S. BROADWAY, SUITE 150 (209) 668-5520

SIGNING AND STRIPING PLAN - THE BURL
PROJECT NO. 23-069

CITY OF TURLOCK ROADS PROGRAM

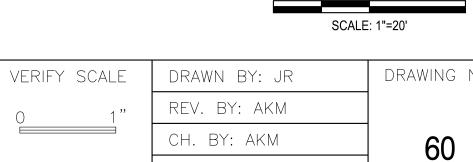

E DRAWN BY: JR

REV. BY: AKM

CH. BY: AKM

DATE: 8/7/2025


SCALE: SEE SHEET

SEI PROJ NO: 22157

DRAWING NO.

60


SHEET:
60 OF 117

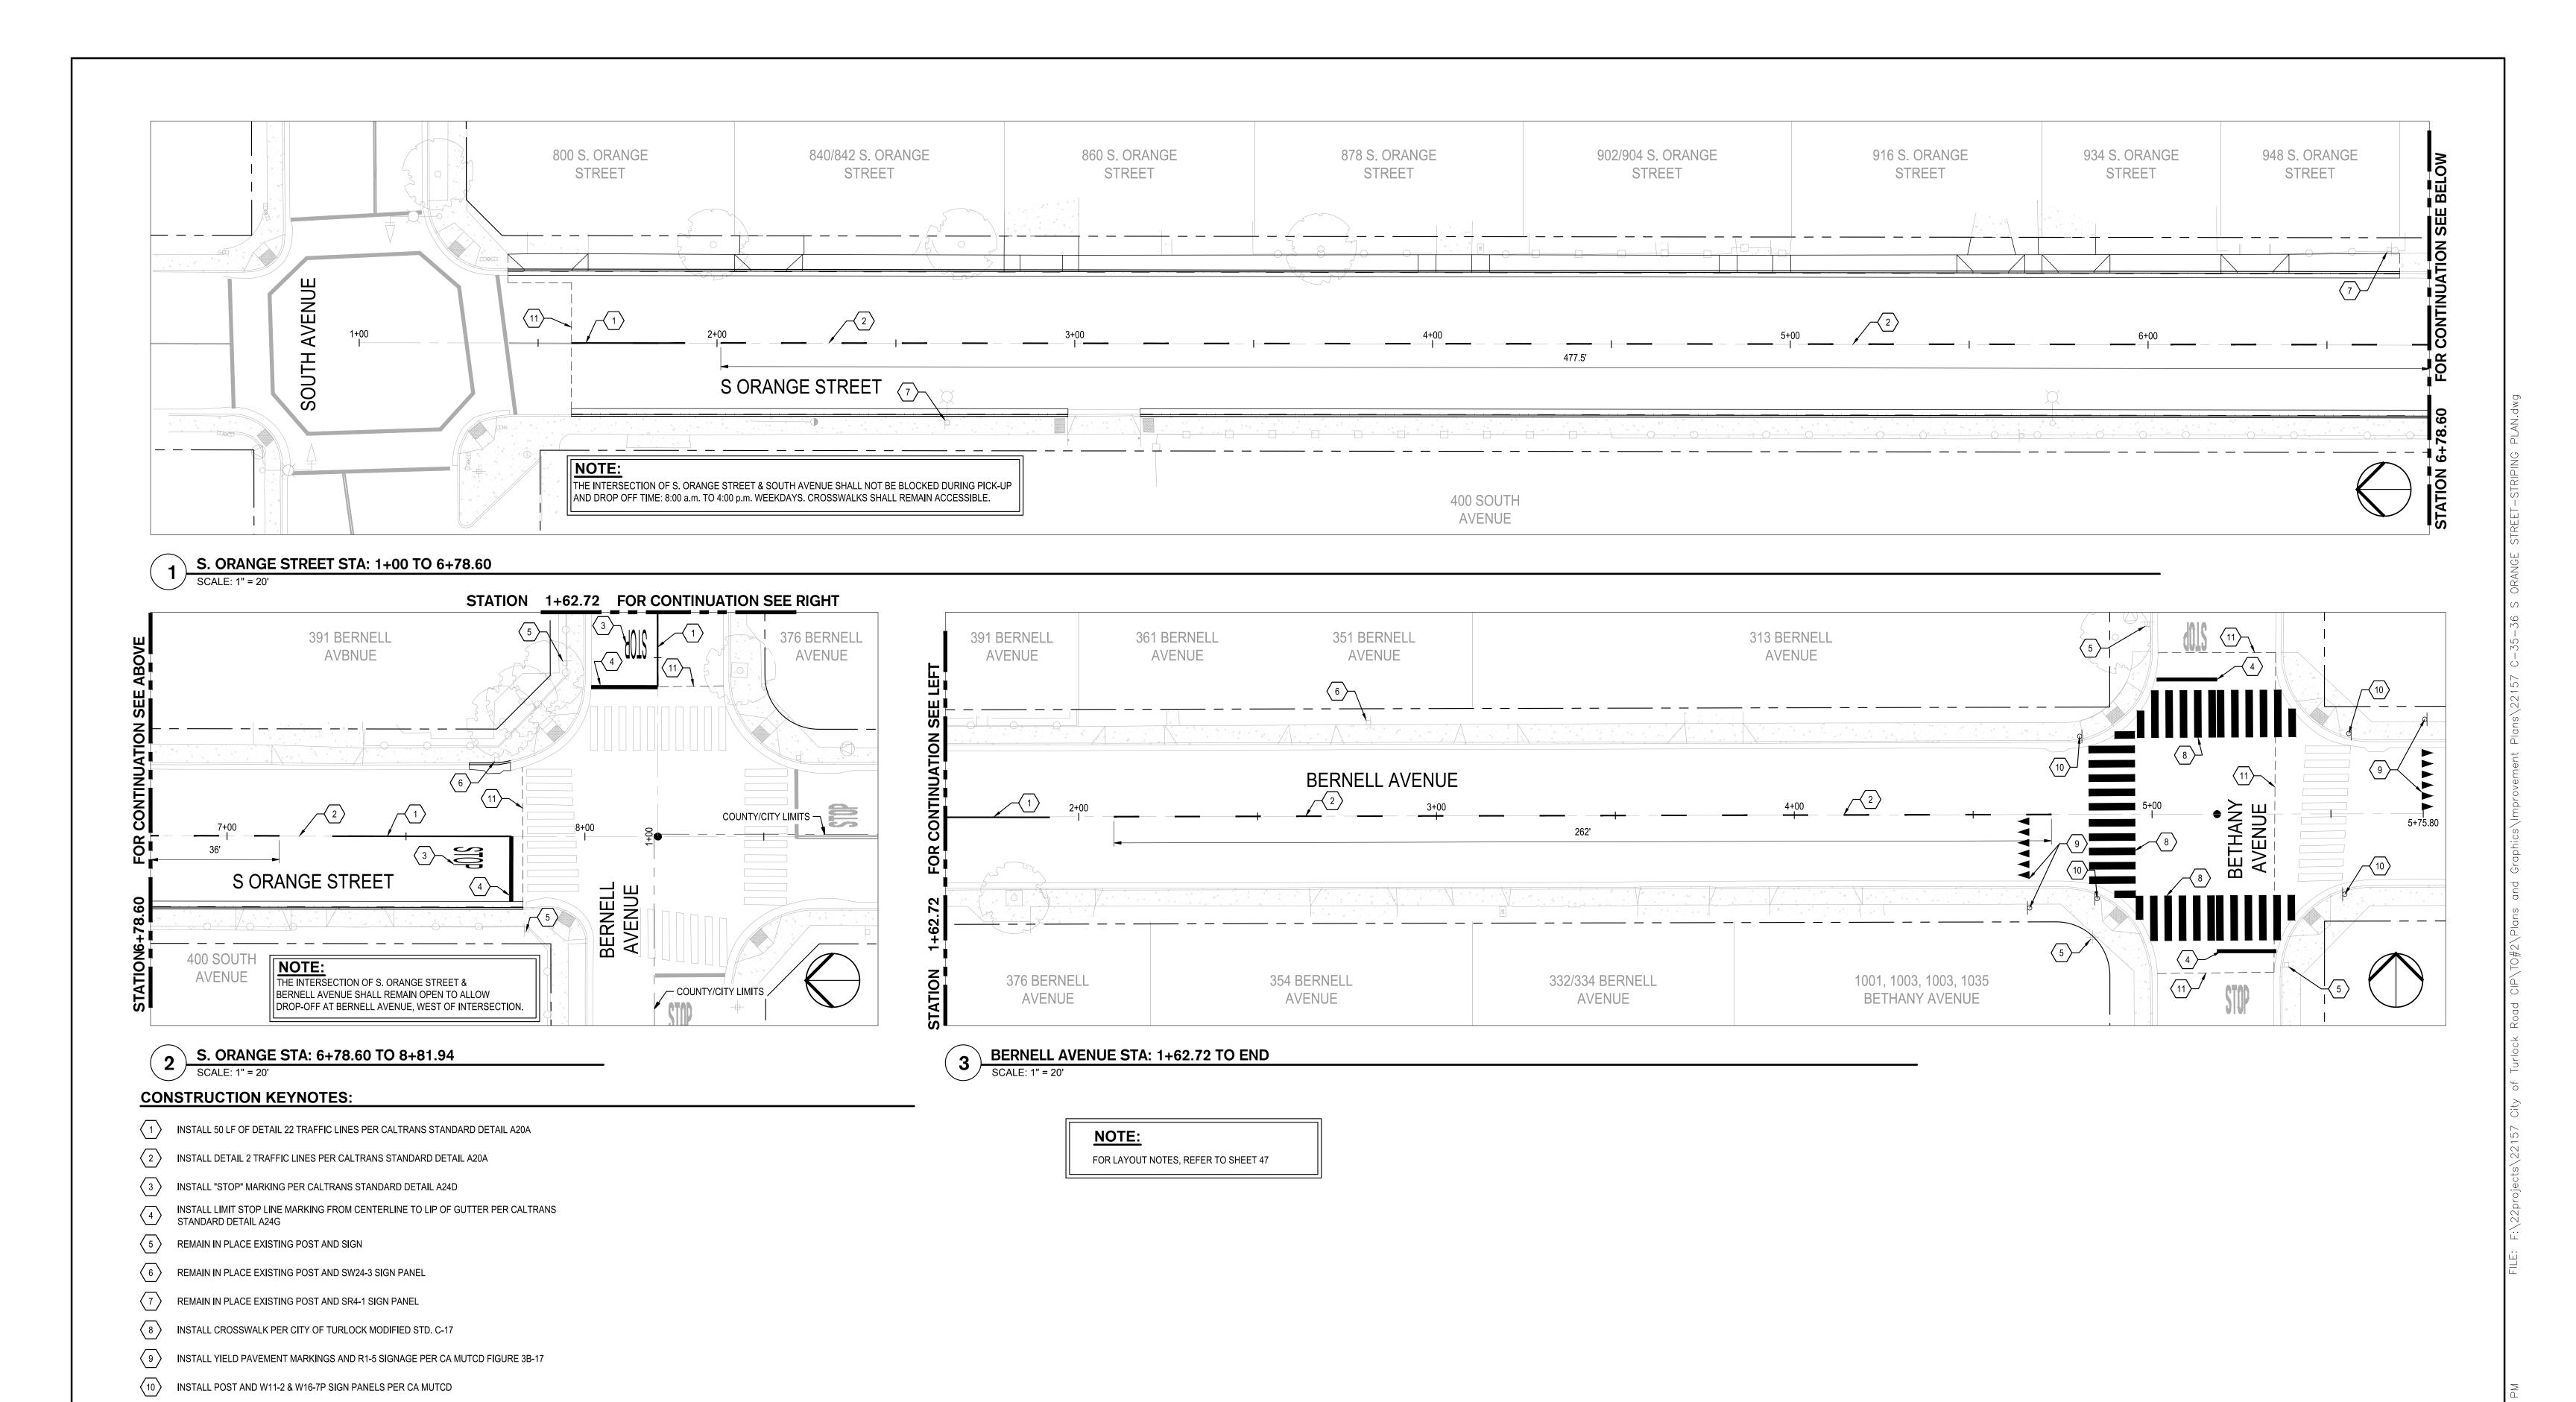



Know what's **below. Call** before you dig.

ALL REFERENCES AND WRITTEN DIMENSIONS SHALL SUPERCEDE ALL SCALED DISTANCES AND SHALL BE VERIFIED IN THE FIELD. ANY DISCREPANCY
SHALL BE BROUGHT TO THE
ATTENTION OF THE ENGINEER PRIOR TO THE COMMENCEMENT OF WORK

(11) CONFORM TO EXISTING PAVEMENT. SEE DETAIL 2 ON SHEET 115.

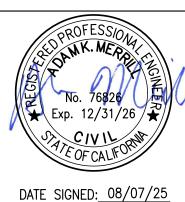

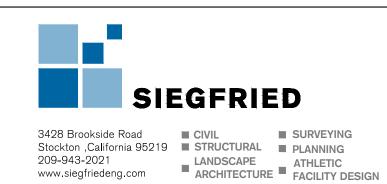

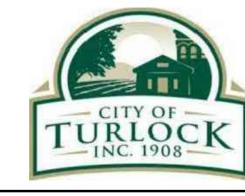


CITY OF TURLOCK MUNICIPAL SERVICES DEPARTMENT 156 S. BROADWAY, SUITE 150 (209) 668-5520

SIGNING AND STRIPING PLAN - S ORANGE STREET & BERNELL AVENUE PROJECT NO. 23-069 CITY OF TURLOCK ROADS PROGRAM

VERIFY SCALE	DRAWN BY: JR	DRAWING NO.
0 1"	REV. BY: AKM	
	CH. BY: AKM	61
	DATE: 8/7/2025	
	SCALE: SEE SHEET	SHEET:
	SEI PROJ NO: 22157	61 OF 117

SCALE: 1"=20'

S. ORANGE STREET STA: 14+51.50 TO 20+40.72

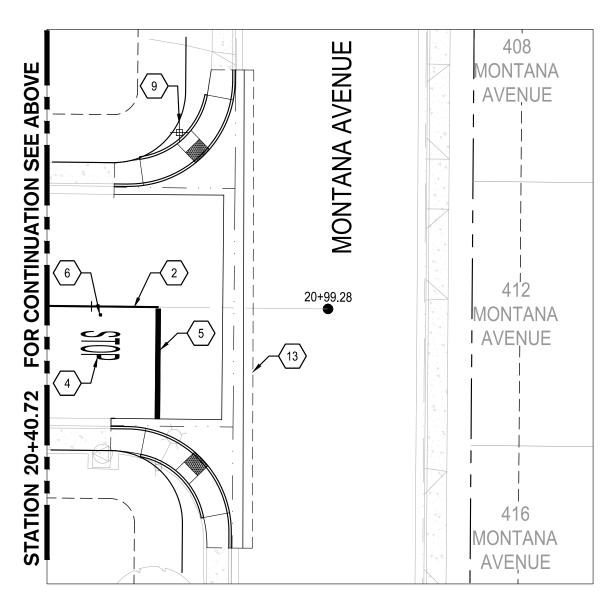

2 S. ORANGE STA: 20+40.72 TO END

SCALE: 1" = 20'

CONSTRUCTION KEYNOTES:

- 1 INSTALL CROSSWALK PER CITY OF TURLOCK MODIFIED STD. C-17
- 2 INSTALL 50 LF OF DETAIL 22 TRAFFIC LINES PER CALTRANS STANDARD DETAIL A20A
- 3 INSTALL DETAIL 2 TRAFFIC LINES PER CALTRANS STANDARD DETAIL A20A
- 4 INSTALL "STOP" MARKING PER CALTRANS STANDARD DETAIL A24D
- INSTALL LIMIT STOP LINE MARKING FROM CENTERLINE TO LIP OF GUTTER PER CALTRANS STANDARD DETAIL A24G
- 6 INSTALL BLUE REFLECTIVE HYDRANT MARKER PER CITY OF TURLOCK STD. W-3
- 7 REMAIN IN PLACE EXISTING POST AND SIGN
- 8 REMAIN IN PLACE EXISTING POST AND R2-1 SIGN PANEL
- REINSTALL EXISTING POST AND STREET NAME SIGN PANELS PER CITY OF TURLOCK STANDARD DETAILS ST-10 THRU ST-12
- REINSTALL EXISTING STREET NAME SIGN PANELS ON POST PER CITY OF TURLOCK
- STANDARD DETAILS ST-10 THRU ST-12
 INSTALL YIELD PAVEMENT MARKINGS AND R1-5
- SIGNAGE PER CA MUTCD FIGURE 3B-17

 INSTALL POST AND W11-2 & W16-7P SIGN PANELS PER CA MUTCD

(13) CONFORM TO EXISTING PAVEMENT. SEE DETAIL 2 ON SHEET 115.

NOTE:

FOR LAYOUT NOTES, REFER TO SHEET 47


0' 10' 20' 40' SCALE: 1"=20'



NOTE:
ALL REFERENCES AND WRITTEN
DIMENSIONS SHALL SUPERCEDE
ALL SCALED DISTANCES AND
SHALL BE VERIFIED IN THE
FIELD. ANY DISCREPANCY
SHALL BE BROUGHT TO THE
ATTENTION OF THE ENGINEER
PRIOR TO THE COMMENCEMENT
OF WORK






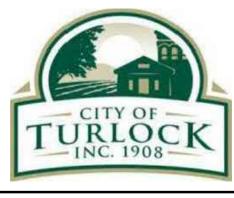


CITY OF TURLOCK
MUNICIPAL SERVICES DEPARTMENT
156 S. BROADWAY,
SUITE 150
(209) 668-5520

SIGNING AND STRIPING PLAN - S ORANGE STREET II

	SCALE	. 1 –20
ERIFY SCALE	DRAWN BY: JR	DRAWING NO
1 "	REV. BY: AKM	
	CH. BY: AKM	62
	DATE: 8/7/2025	
	SCALE: SEE SHEET	SHEET:
	SEI PROJ NO: 22157	62 OF 11

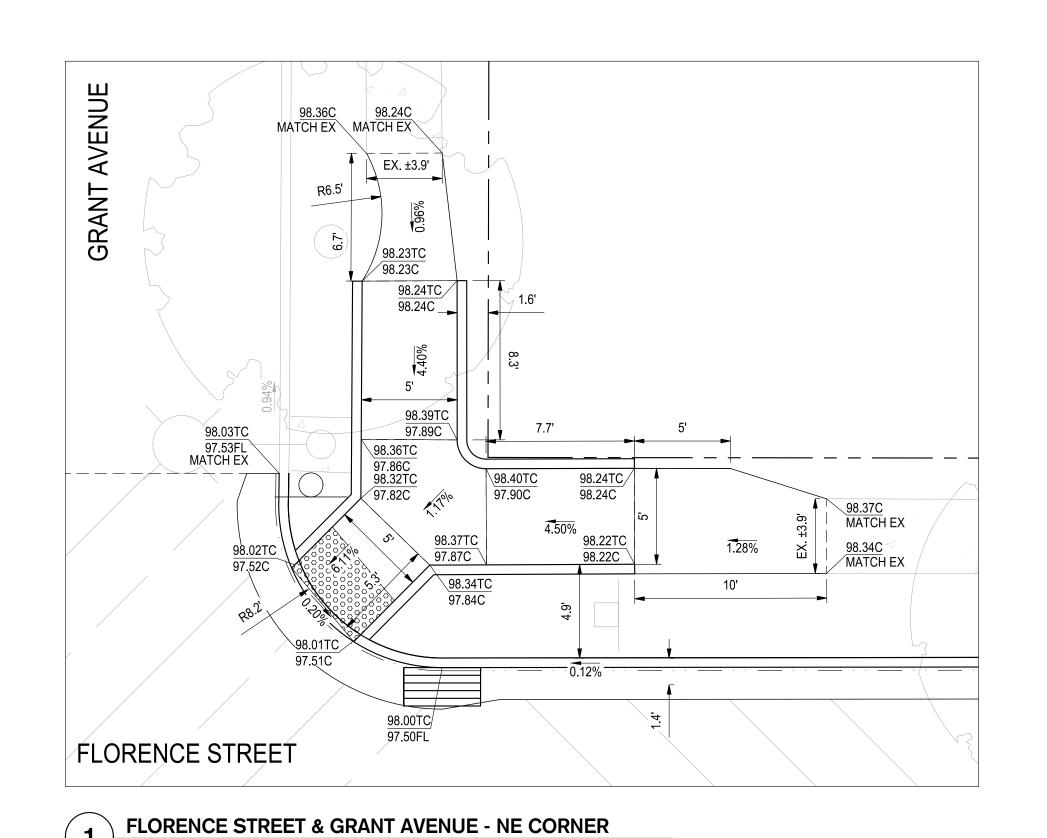


98.43TC 98.43C FLORENCE STREET 98.15TC/ 97.65FL

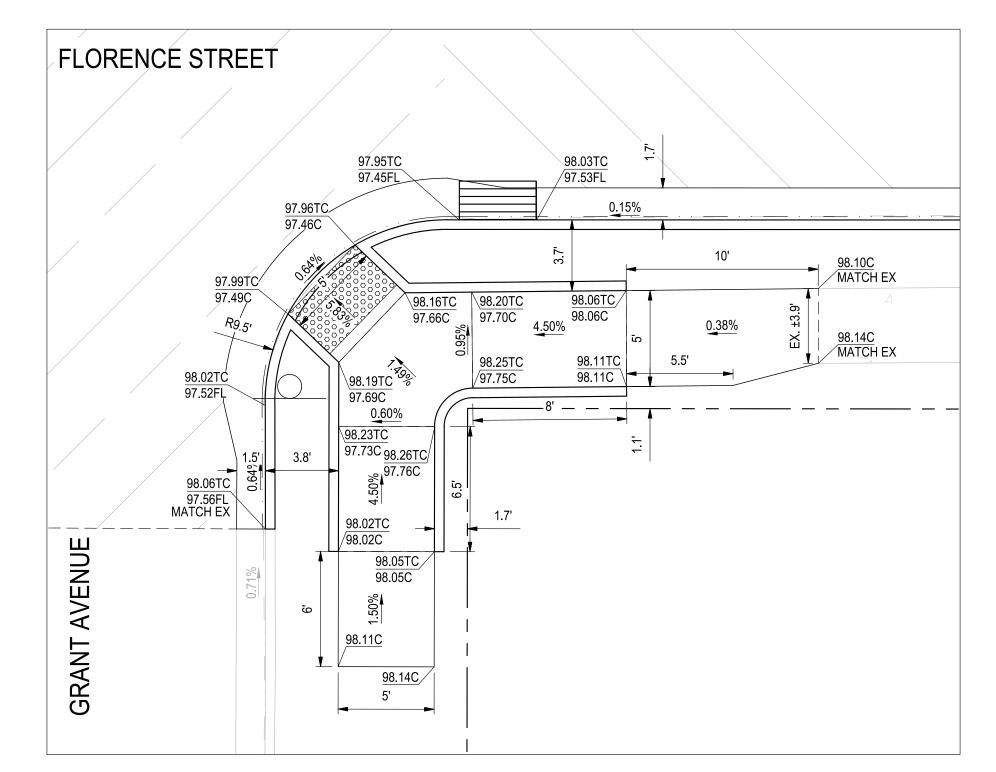



FLORENCE STREET & N. BEECH STREET - NW CORNER

SCALE: 1" = 5'

FLORENCE STREET & GRANT AVENUE - SE CORNER

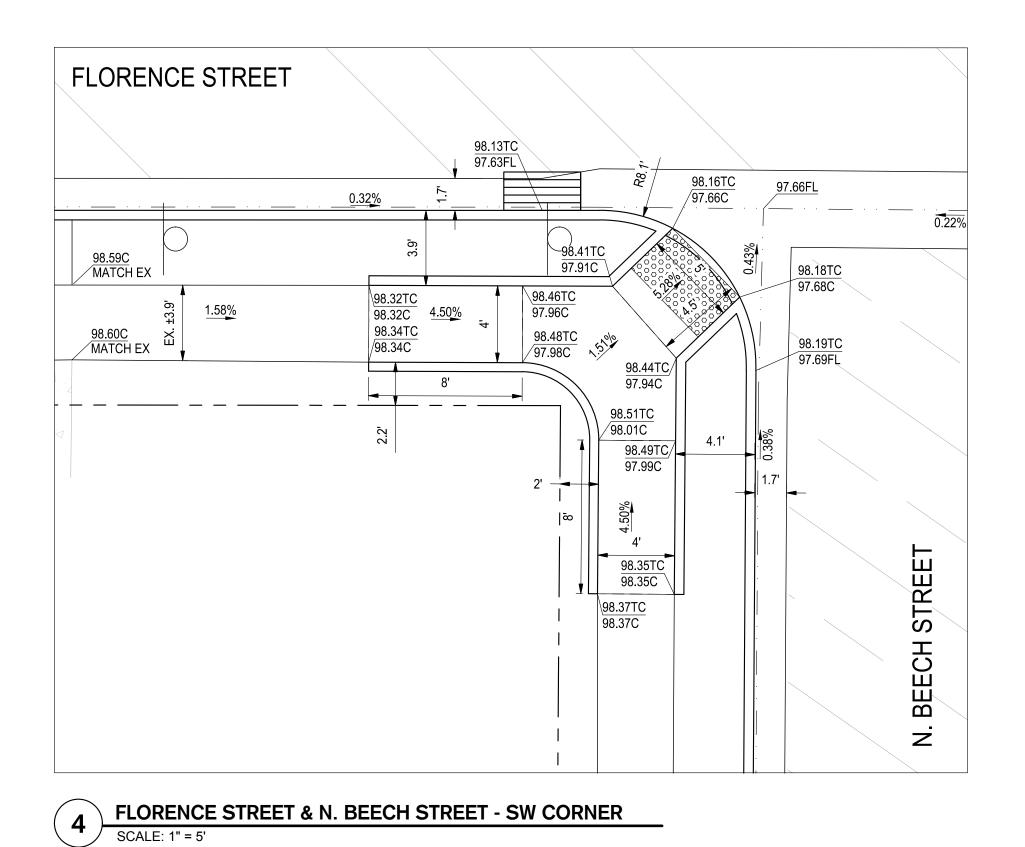

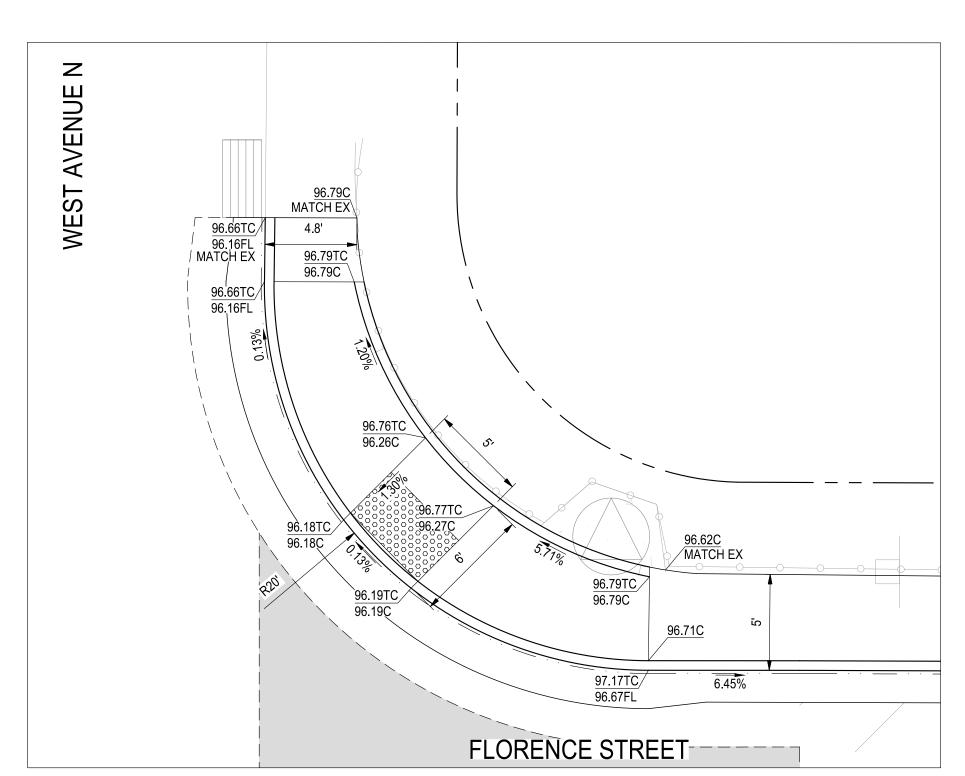

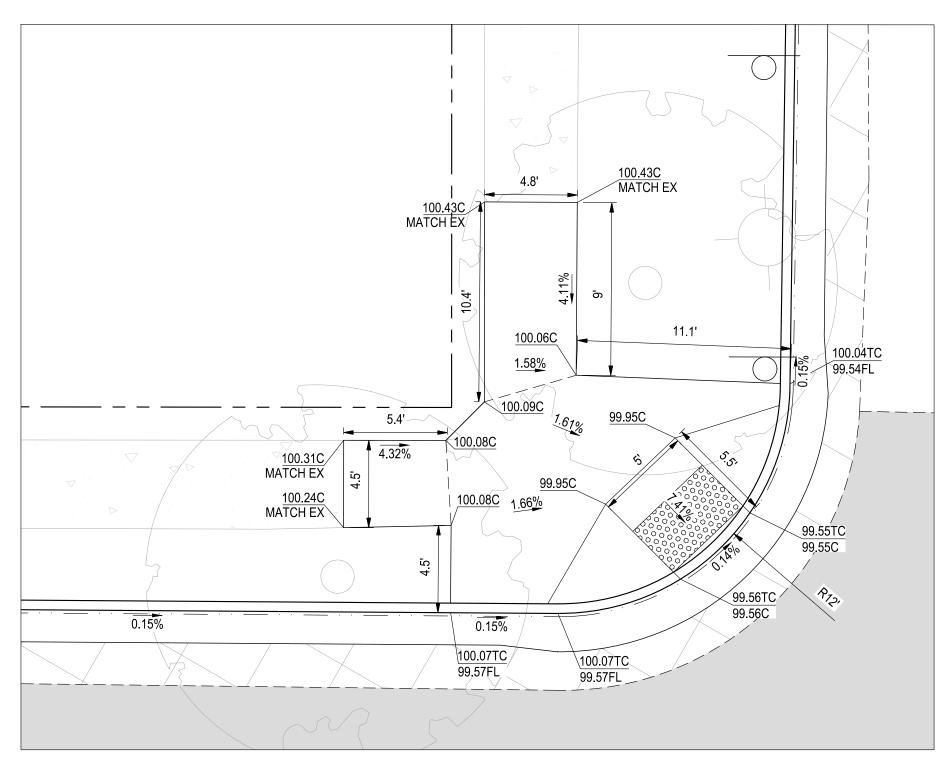



SCALE: 1" = 5' FLORENCE STREET & N BROADWAY- NW CORNER


SCALE: 1"=5'

Know what's **below. Call** before you dig.

ALL REFERENCES AND WRITTEN
DIMENSIONS SHALL SUPERCEDE
ALL SCALED DISTANCES AND
SHALL BE VERIFIED IN THE FIELD. ANY DISCREPANCY
SHALL BE BROUGHT TO THE
ATTENTION OF THE ENGINEER PRIOR TO THE COMMENCEMENT OF WORK

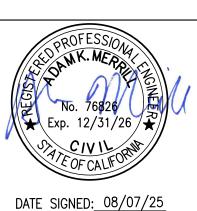

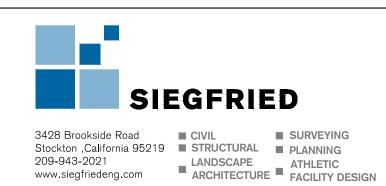

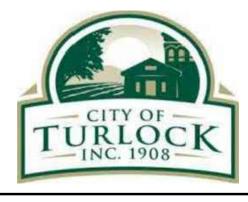



CITY OF TURLOCK MUNICIPAL SERVICES DEPARTMENT 156 S. BROADWAY, SUITE 150 (209) 668-5520


CURB RAMP DETAILS - FLORENCE STREET I PROJECT NO. 23-069

CITY OF TURLOCK ROADS PROGRAM

RIFY SCALE	DRAWN BY: JR	DRAWING NO
1"	REV. BY: AKM	
	CH. BY: AKM	63
	DATE: 8/7/2025	
	SCALE: SEE SHEET	SHEET:
	SEI PROJ NO: 22157	63 OF 11

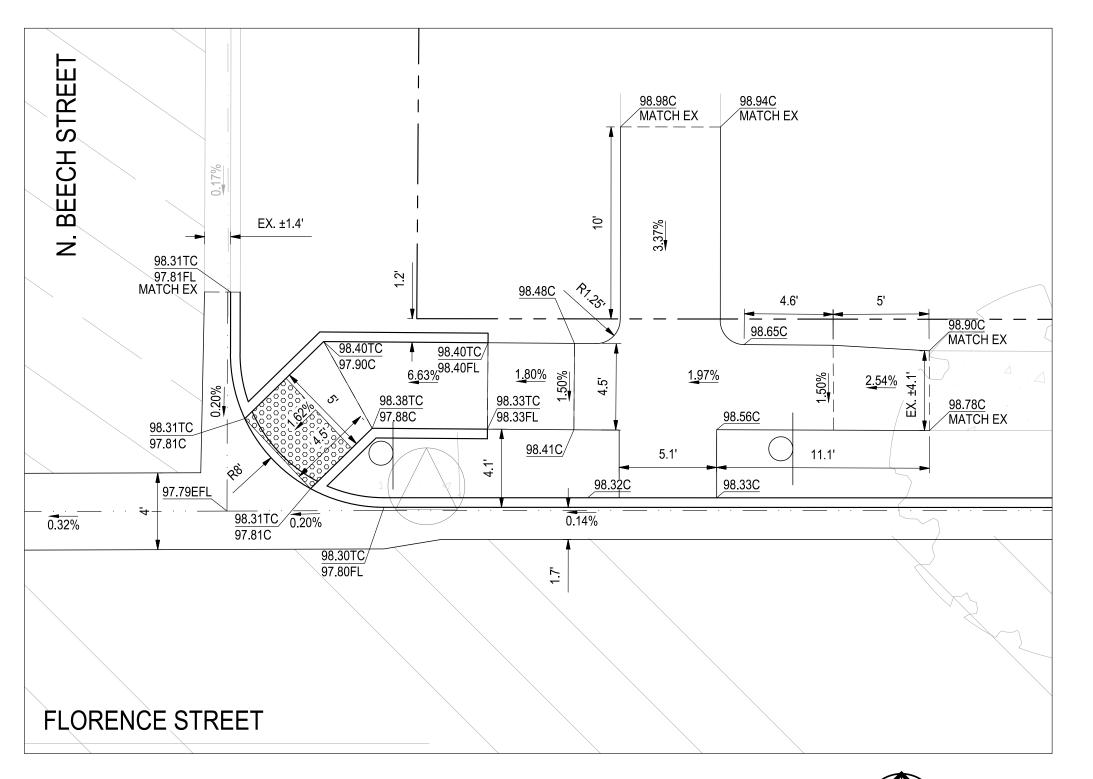

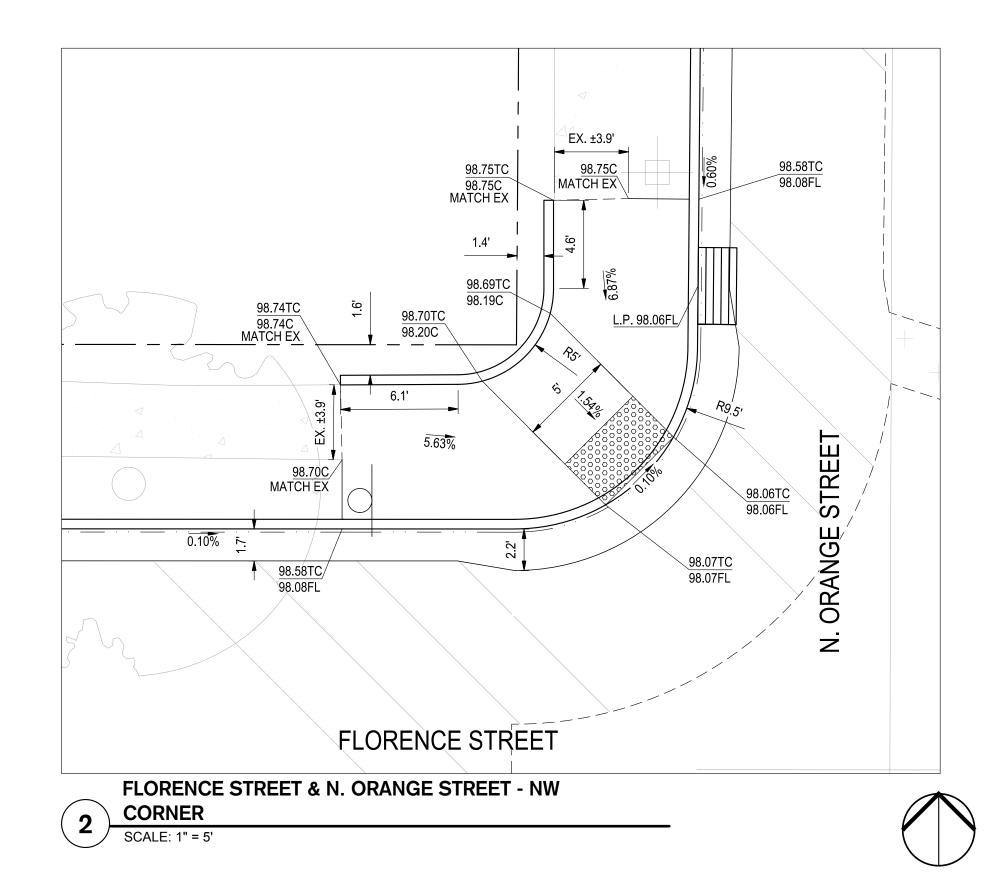

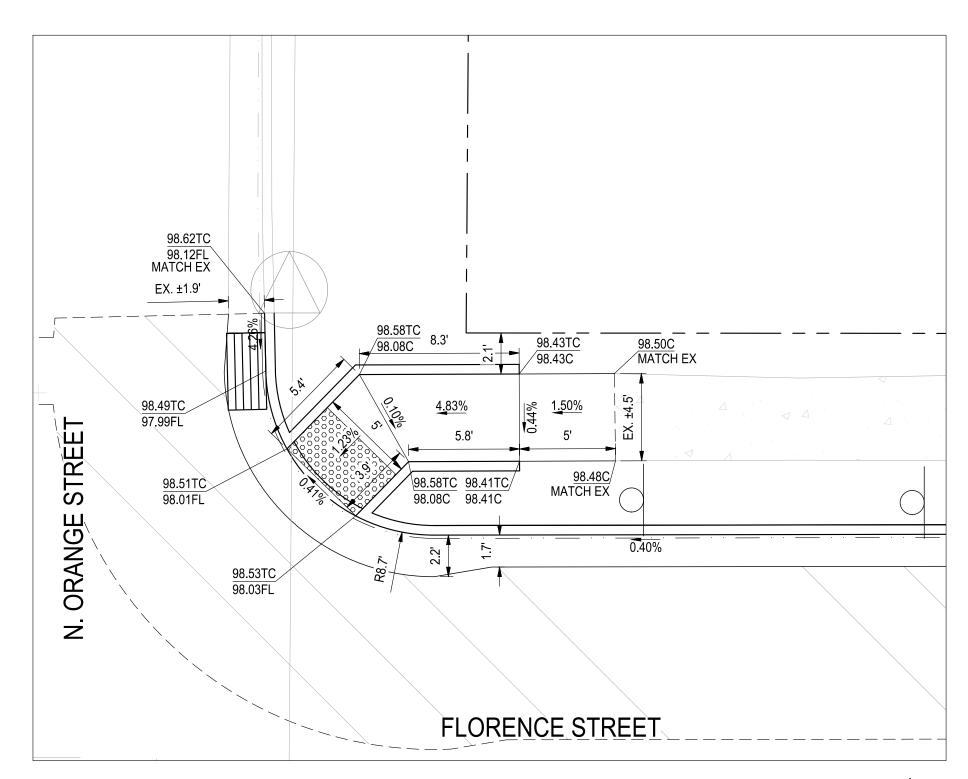


FLORENCE STREET & N. ORANGE STREET - NE CORNER

SCALE: 1" = 5'

FLORENCE STREET & N. BEECH STREET - NE CORNER




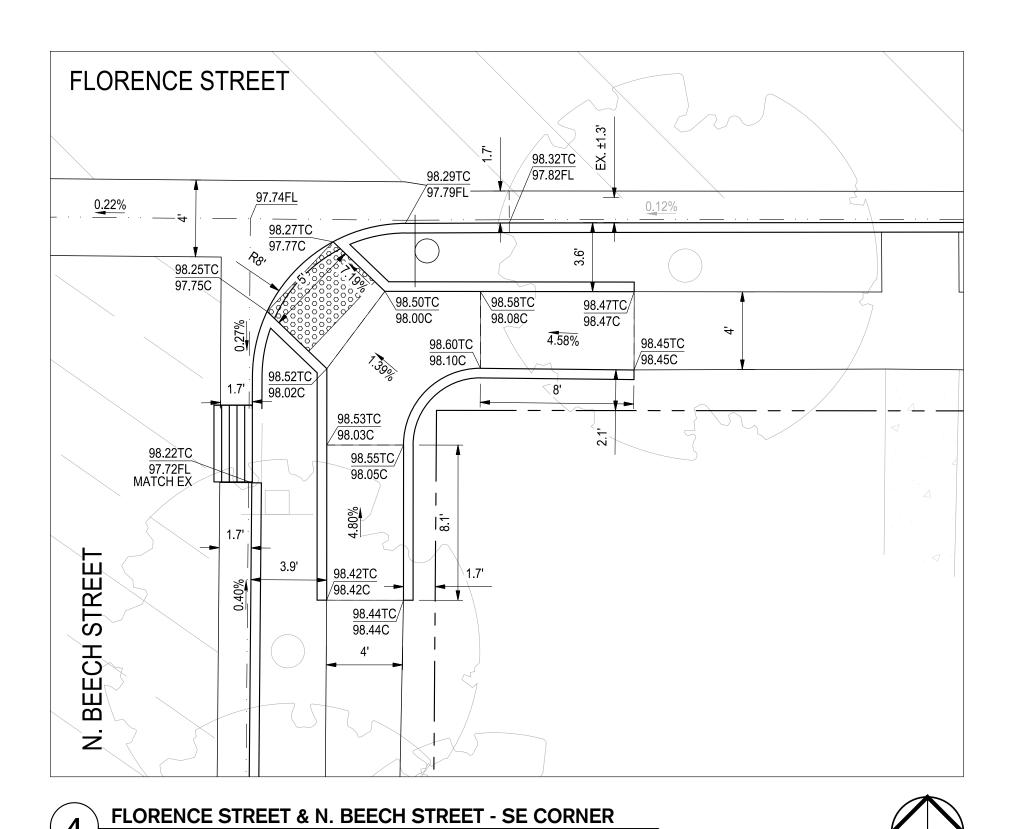


100.46TC 99.96FL MATCH EX 100.49C MATCH EX EX. ±5.2' EX. ±4.7' 100.35C 100.70C MATCH EX 10.4' 0.44% 100.58TC/ 100.08FL/ 100.12FL MATCH EX FLORENCE STREET 5 FLORENCE STREET & N. 1ST STREET - W CORNER
SCALE: 1" = 5'

Know what's **below. Call** before you dig.

ALL REFERENCES AND WRITTEN DIMENSIONS SHALL SUPERCEDE
ALL SCALED DISTANCES AND
SHALL BE VERIFIED IN THE
FIELD. ANY DISCREPANCY
SHALL BE BROUGHT TO THE
ATTENTION OF THE ENGINEER PRIOR TO THE COMMENCEMENT OF WORK

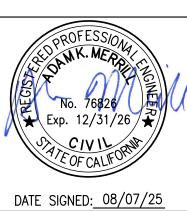



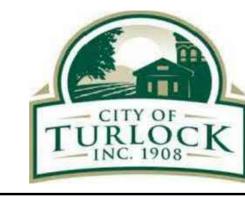


CITY OF TURLOCK MUNICIPAL SERVICES DEPARTMENT 156 S. BROADWAY, SUITE 150 (209) 668-5520

CURB RAMP DETAILS - FLORENCE STREET II PROJECT NO. 23-069 CITY OF TURLOCK ROADS PROGRAM


DRAWN BY: JR	DRAWING NO.
REV. BY: AKM	
CH. BY: AKM	64
DATE: 8/7/2025	
SCALE: SEE SHEET	SHEET:
SEI PROJ NO: 22157	64 OF 117
	REV. BY: AKM CH. BY: AKM DATE: 8/7/2025 SCALE: SEE SHEET



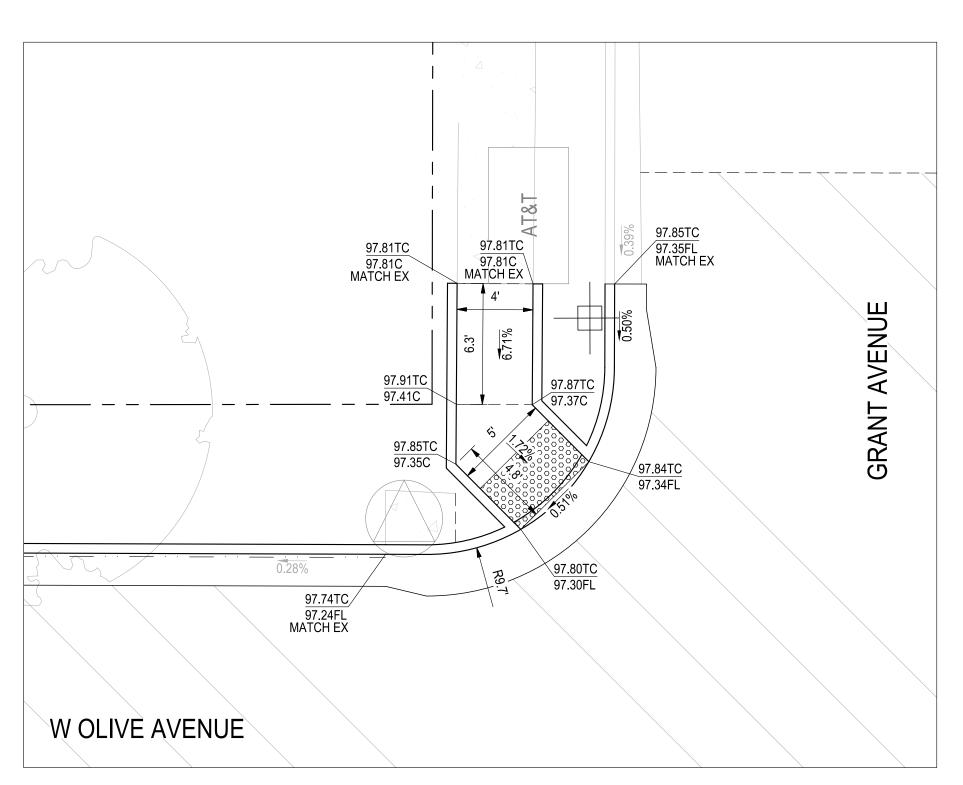


W OLIVE AVENUE & GRANT AVENUE - NW CORNER

SCALE: 1" = 5'

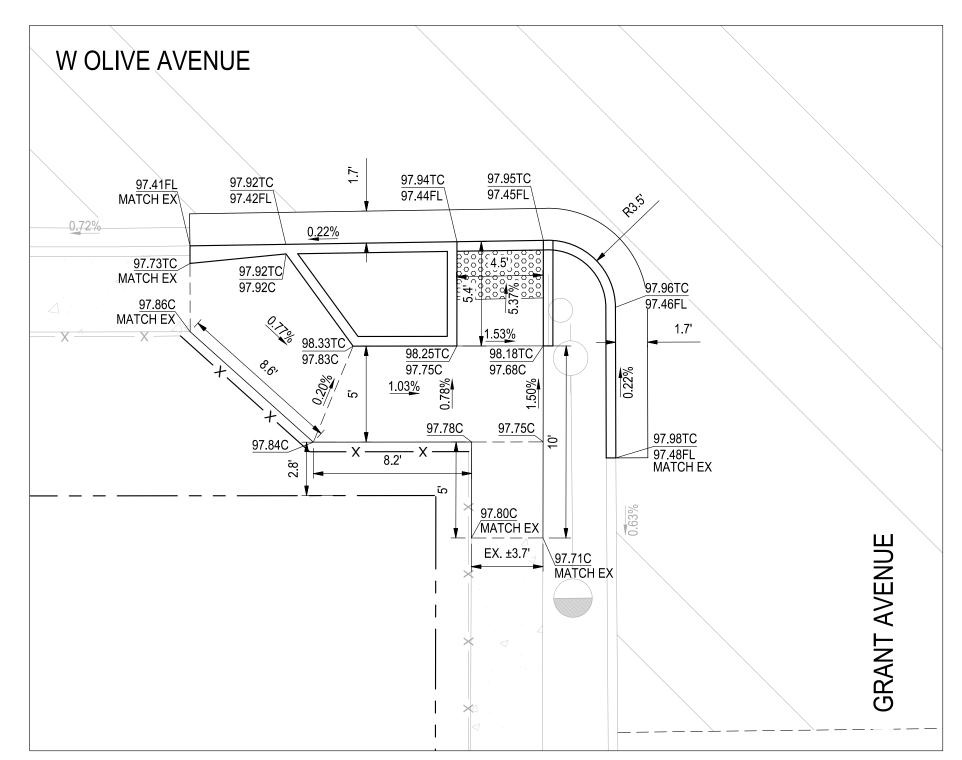

W OLIVE AVENUE & GRANT AVENUE - SW CORNER

SCALE: 1" = 5'

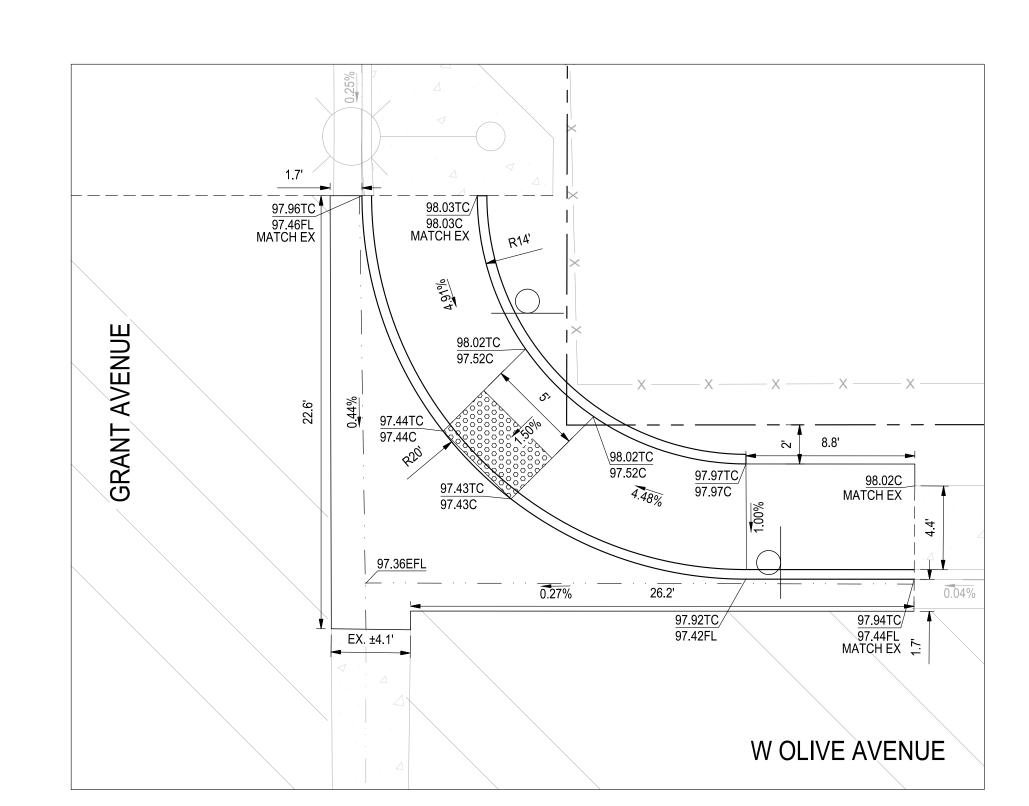

W OLIVE AVENUE & GRANT AVENUE - NE CORNER


SCALE: 1" = 5'



ALL REFERENCES AND WRITTEN DIMENSIONS SHALL SUPERCEDE
ALL SCALED DISTANCES AND
SHALL BE VERIFIED IN THE
FIELD. ANY DISCREPANCY
SHALL BE BROUGHT TO THE
ATTENTION OF THE ENGINEER PRIOR TO THE COMMENCEMENT





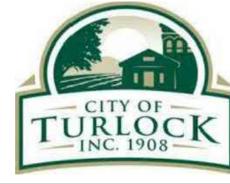

CITY OF TURLOCK MUNICIPAL SERVICES DEPARTMENT 156 S. BROADWAY, SUITE 150 (209) 668-5520

CURB RAMP DETAILS - W OLIVE AVENUE I PROJECT NO. 23-069 CITY OF TURLOCK ROADS PROGRAM


VERIFY SCALE	DRAWN BY: JR	DRAWING NO.
0 1"	REV. BY: AKM	
	CH. BY: AKM	65
	DATE: 8/7/2025	
	SCALE: SEE SHEET	SHEET:
	SEI PROJ NO: 22157	65 OF 117

OF WORK


LANDSCAPE ATHLETIC FACILITY DESIGN www.siegfriedeng.com

SCALE: 1"=5'

W OLIVE AVENUE & N BEECH STREET - NW CORNER

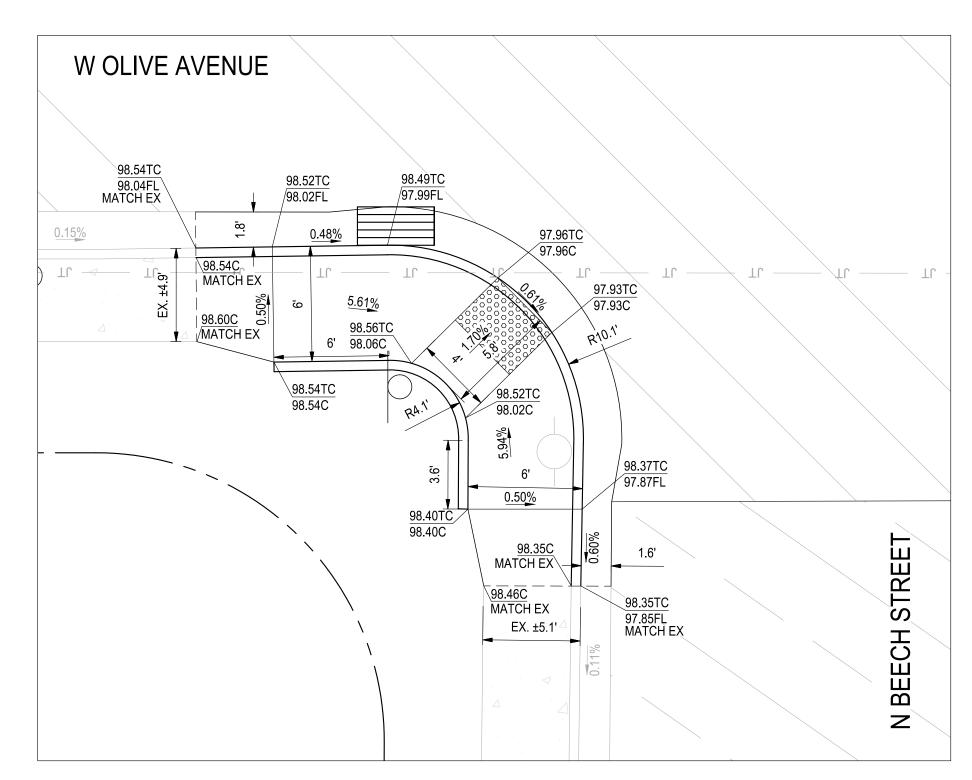


W OLIVE AVENUE & N BEECH STREET - SW CORNER SCALE: 1" = 5'

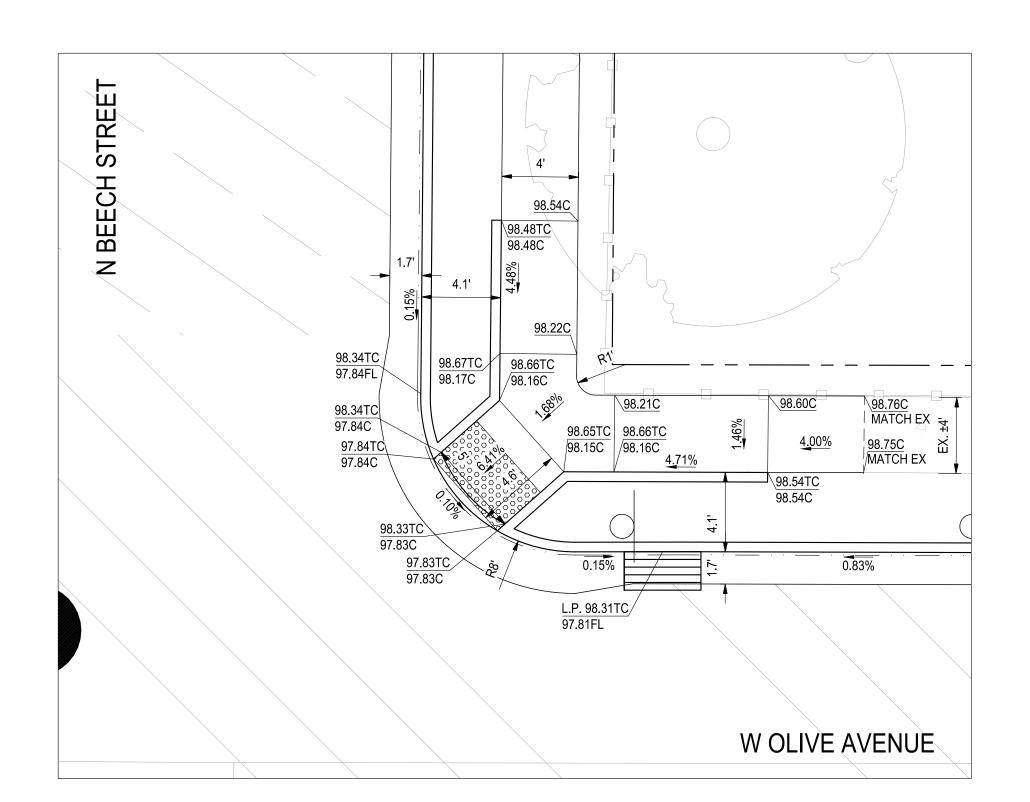


W OLIVE AVENUE & N BEECH STREET - NE CORNER

SCALE: 1" = 5"

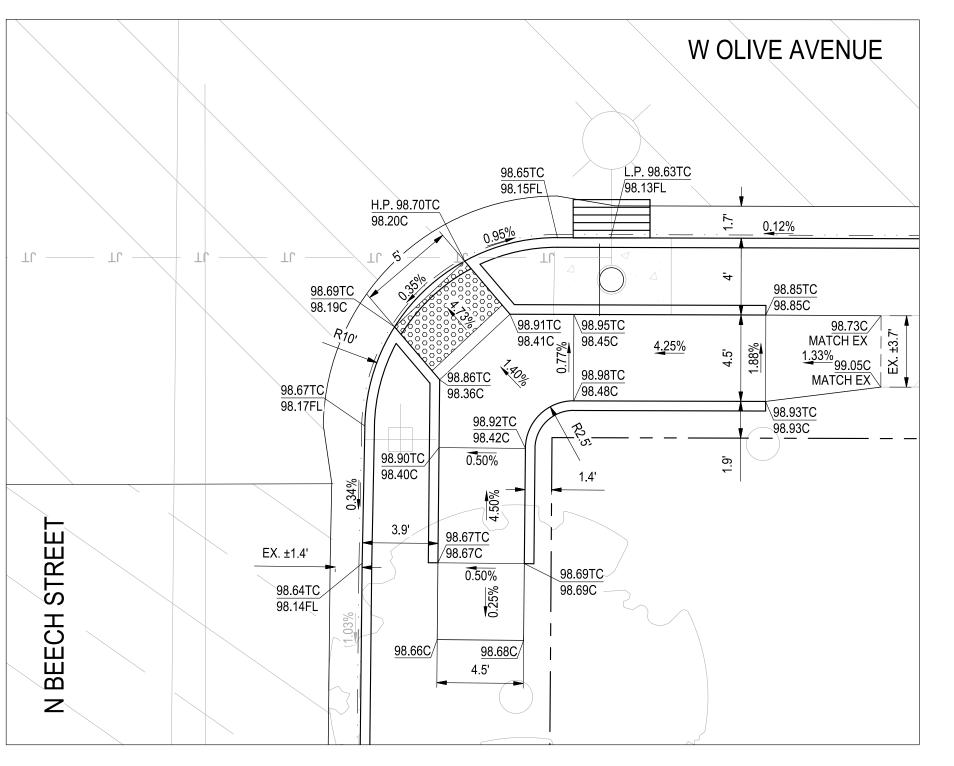


W OLIVE AVENUE & N BEECH STREET - SE CORNER

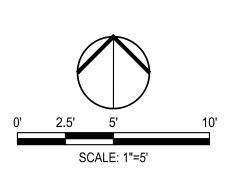


Know what's **below. Call** before you dig.

ALL REFERENCES AND WRITTEN
DIMENSIONS SHALL SUPERCEDE
ALL SCALED DISTANCES AND
SHALL BE VERIFIED IN THE
FIELD. ANY DISCREPANCY
SHALL BE BROUGHT TO THE
ATTENTION OF THE ENGINEER PRIOR TO THE COMMENCEMENT OF WORK

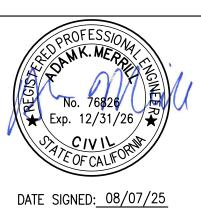




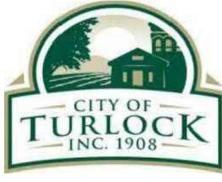

CITY OF TURLOCK MUNICIPAL SERVICES DEPARTMENT 156 S. BROADWAY, SUITE 150 (209) 668-5520

CURB RAMP DETAILS - W OLIVE AVENUE II PROJECT NO. 23-069

VERIFY SCALE	DRAWN BY: JR	DRAWING N
0 1"	REV. BY: AKM	
	CH. BY: AKM	66
	DATE: 8/7/2025	
	SCALE: SEE SHEET	SHEET:
	SEI PROJ NO: 22157	66 OF 1

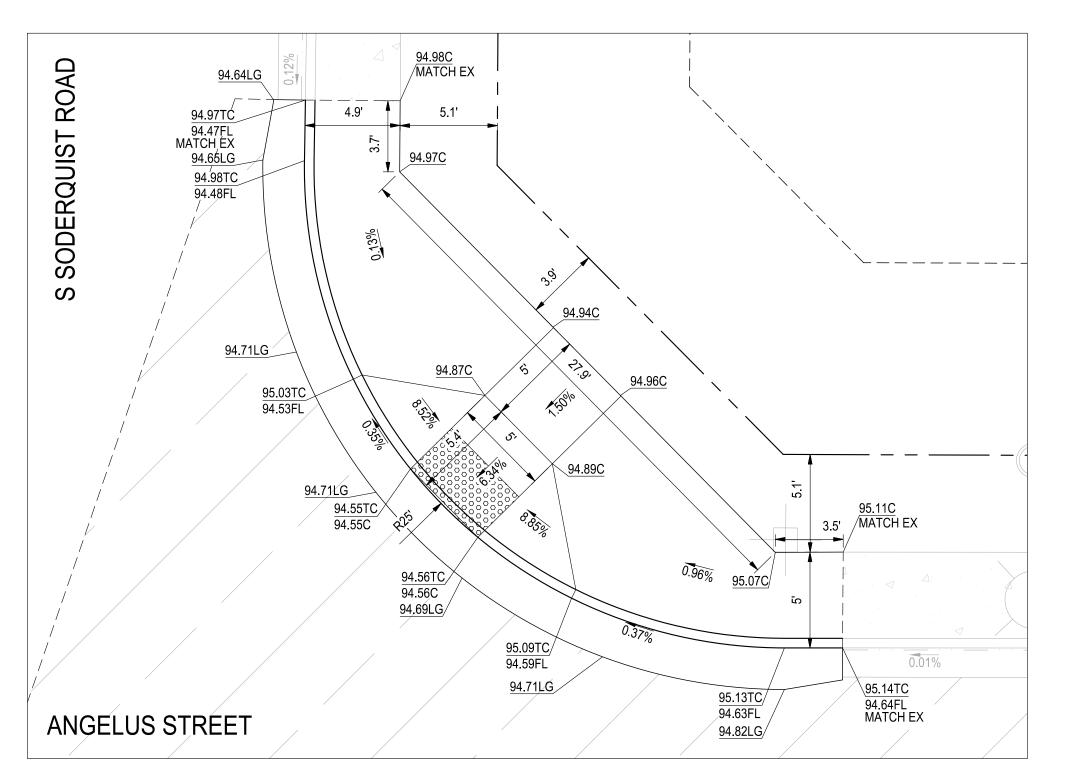


23.3' 96.82C 6' 96.85TC 96.85T


96.11C 96


ANGELUS STREET & ANGELUS COURT - NW CORNER

SCALE: 1" = 5'

ANGELUS STREET & LANDER AVENUE - NW CORNER

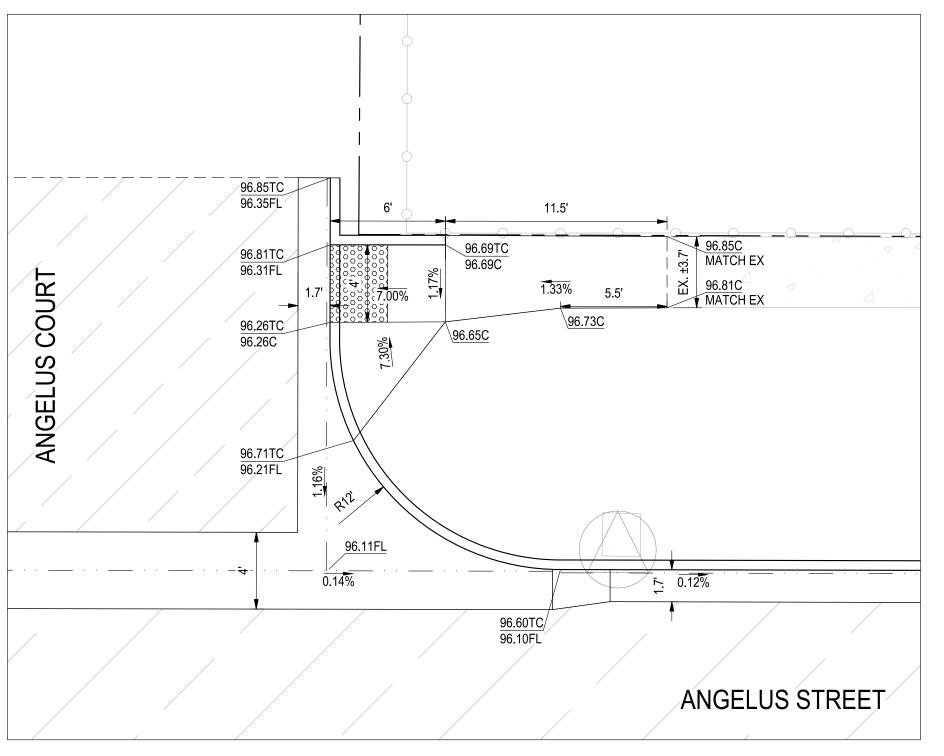

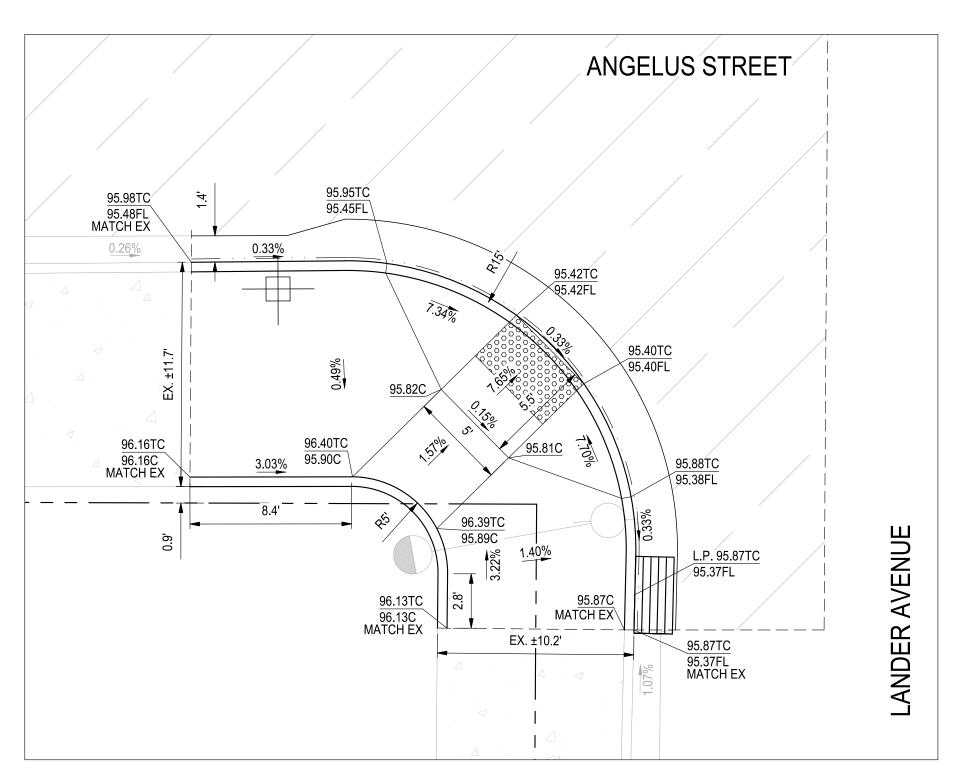

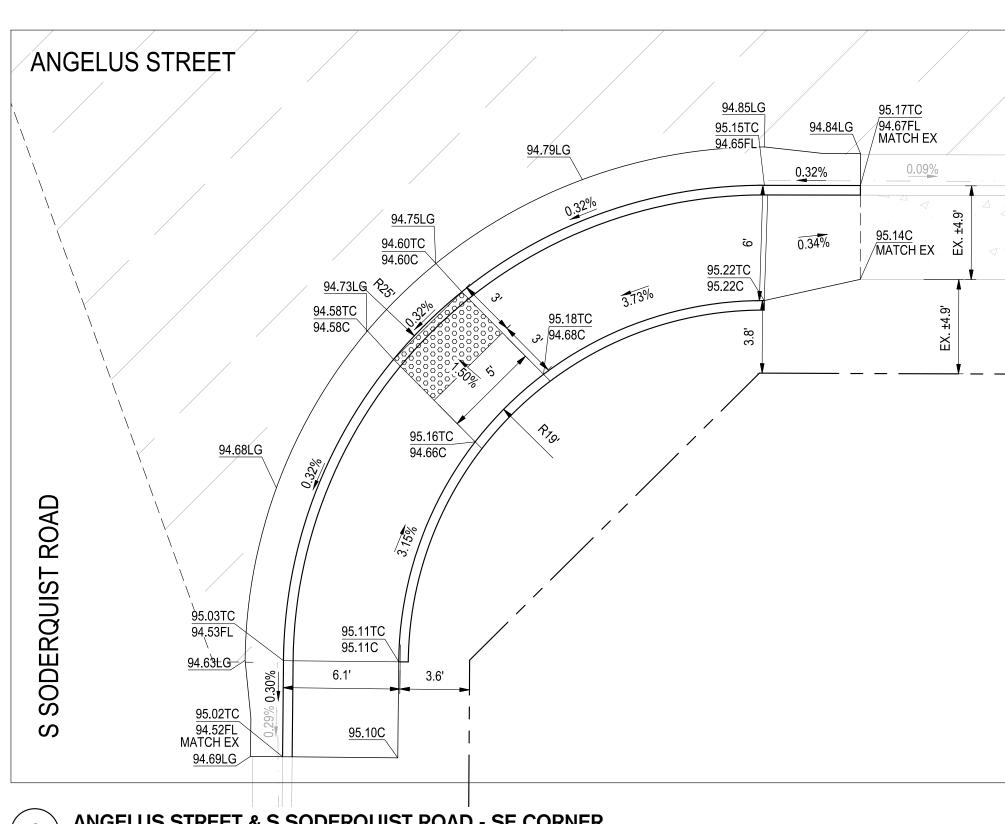

4 ANGELUS STREET & ANGELUS COURT - NE CORNER

SCALE: 1" = 5'


ANGELUS STREET & S SODERQUIST ROAD - NE CORNER


5 ANGELUS STREET & LANDER AVENUE - SW CORNER
SCALE: 1" = 5'

6 ANGELUS STREET & S SODERQUIST ROAD - SE CORNER SCALE: 1" = 5'

Know what's below.
Call before you dig.

NOTE:
ALL REFERENCES AND WRITTEN
DIMENSIONS SHALL SUPERCEDE
ALL SCALED DISTANCES AND
SHALL BE VERIFIED IN THE
FIELD. ANY DISCREPANCY
SHALL BE BROUGHT TO THE
ATTENTION OF THE ENGINEER
PRIOR TO THE COMMENCEMENT
OF WORK

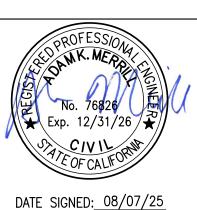

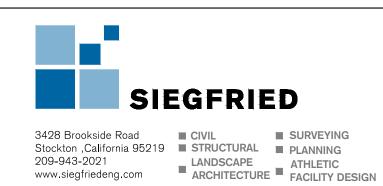




CITY OF TURLOCK MUNICIPAL SERVICES DEPARTMENT 156 S. BROADWAY, SUITE 150 (209) 668-5520

CURB RAMP DETAILS - ANGELUS STREET


PROJECT NO. 23-069
CITY OF TURLOCK ROADS PROGRAM

ERIFY SCALE	DRAWN BY: JR	DRAWING NO.
) 1"	REV. BY: AKM	
	CH. BY: AKM	67
	DATE: 8/7/2025	
	SCALE: SEE SHEET	SHEET:
	SEI PROJ NO: 22157	67 OF 117

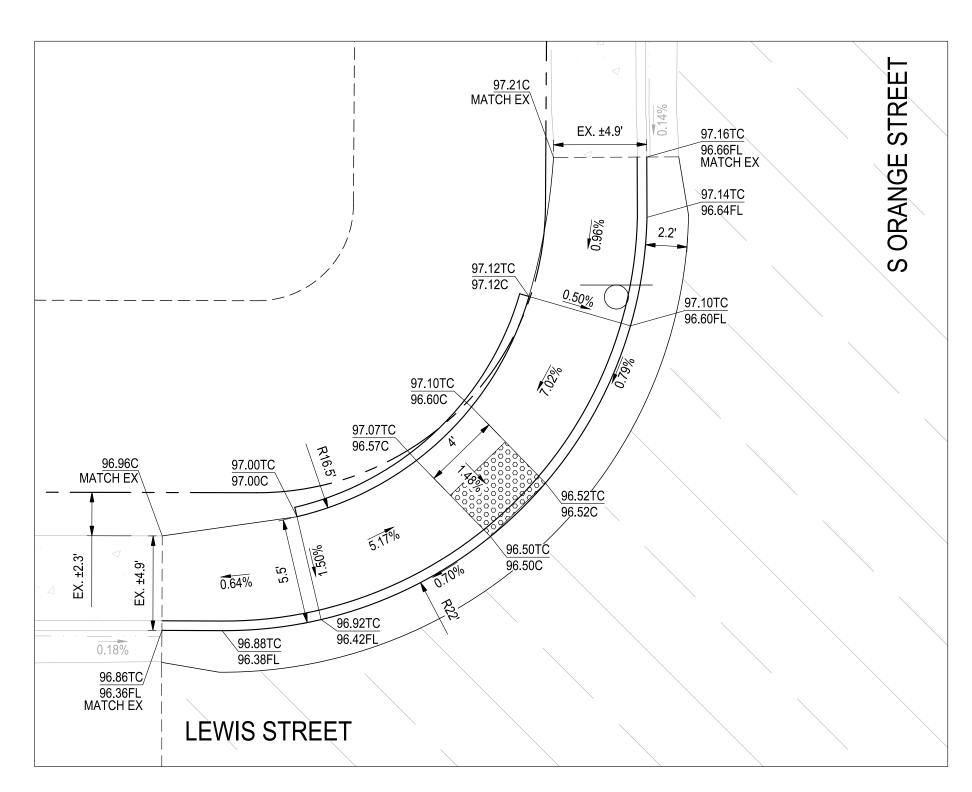


S ORANGE STREET & LEWIS STREET - NW CORNER

SCALE: 1" = 5'

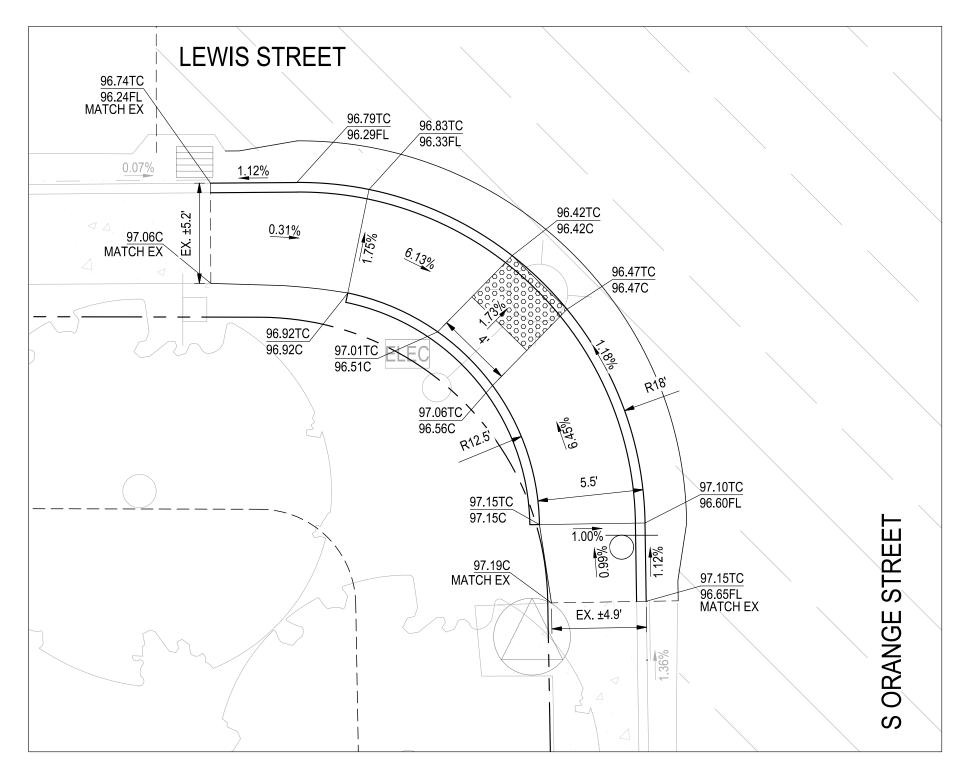


S ORANGE STREET & LEWIS STREET - SW CORNER


SCALE: 1" = 5'

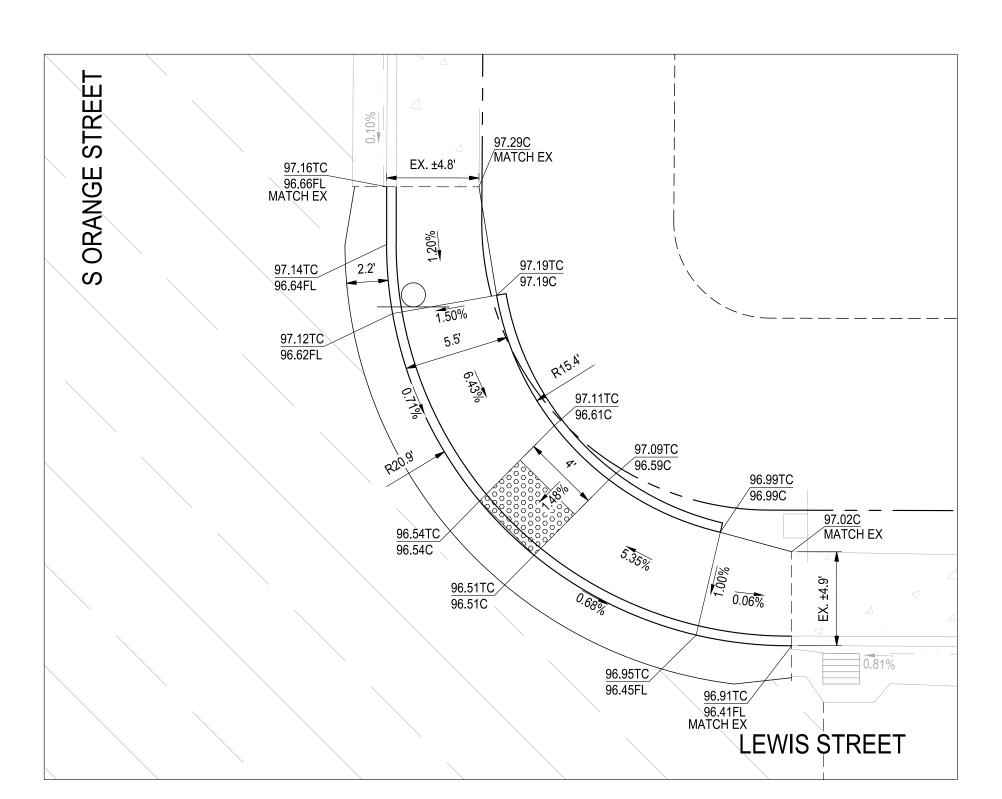

S ORANGE STREET & LEWIS STREET - NE CORNER

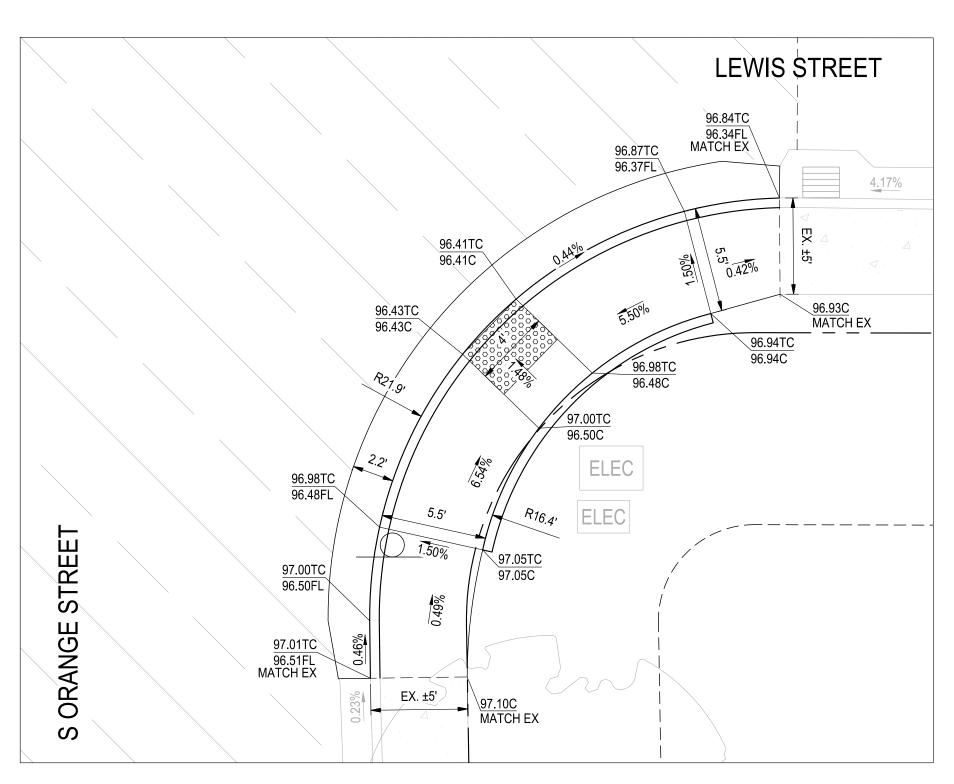

S ORANGE STREET & LEWIS STREET - SE CORNER

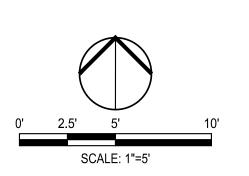


Know what's below.

Call before you dig.

ALL REFERENCES AND WRITTEN
DIMENSIONS SHALL SUPERCEDE
ALL SCALED DISTANCES AND
SHALL BE VERIFIED IN THE
FIELD. ANY DISCREPANCY
SHALL BE BROUGHT TO THE
ATTENTION OF THE ENGINEER
PRIOR TO THE COMMENCEMENT
OF WORK





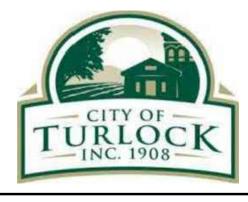


CITY OF TURLOCK
MUNICIPAL SERVICES DEPARTMENT
156 S. BROADWAY,
SUITE 150 (209) 668-5520


CURB RAMP DETAILS - S ORANGE STREET I PROJECT NO. 23-069 CITY OF TURLOCK ROADS PROGRAM

VERIFY SCALE	DRAWN BY: JR	DRAWING N
0 1"	REV. BY: AKM	
	CH. BY: AKM	68
	DATE: 8/7/2025	
	SCALE: SEE SHEET	SHEET:
	SEI PROJ NO: 22157	68 OF 1

DATE SIGNED: 08/07/25

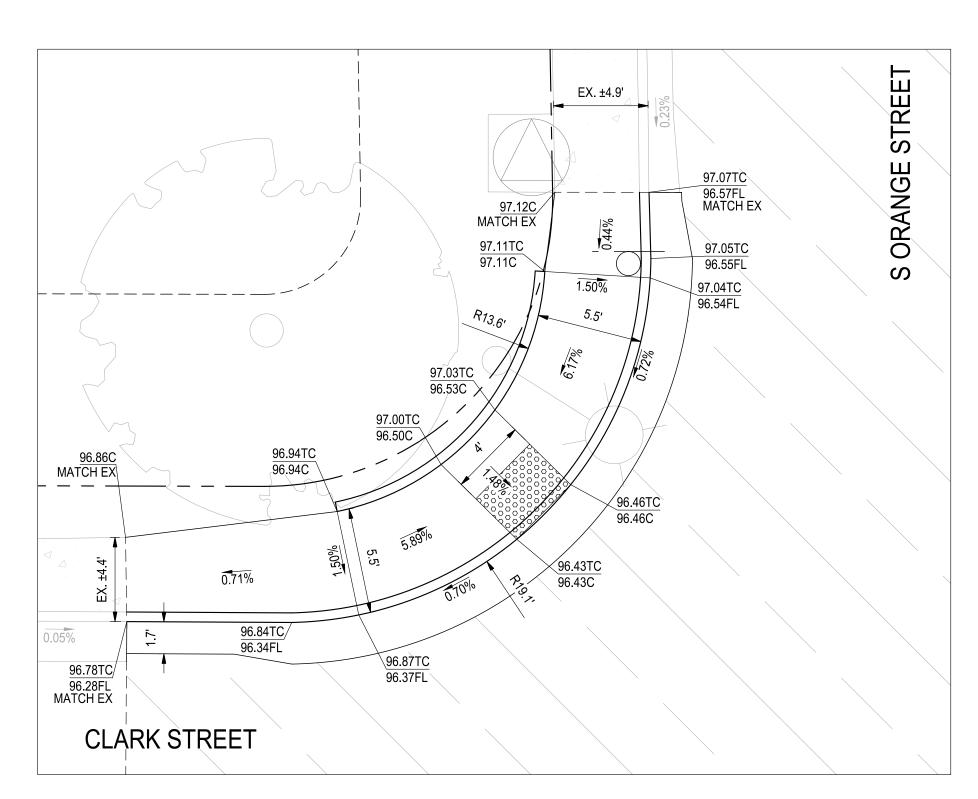


SCALE: 1" = 5'

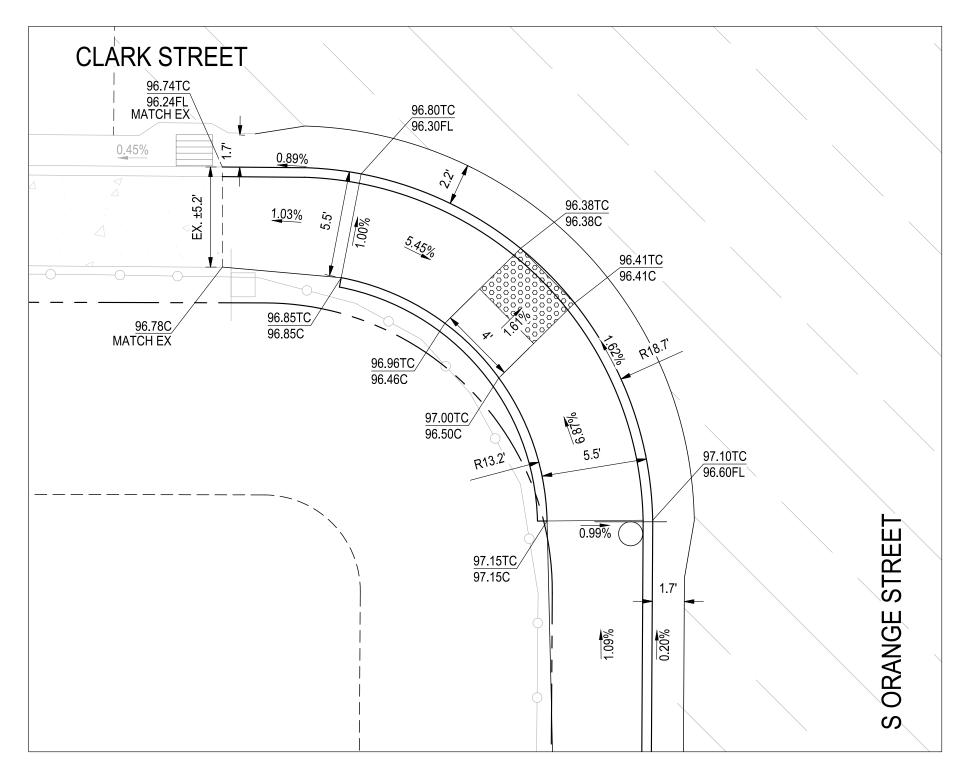


3 S ORANGE STREET & CLARK STREET - SW CORNER

SCALE: 1" = 5"

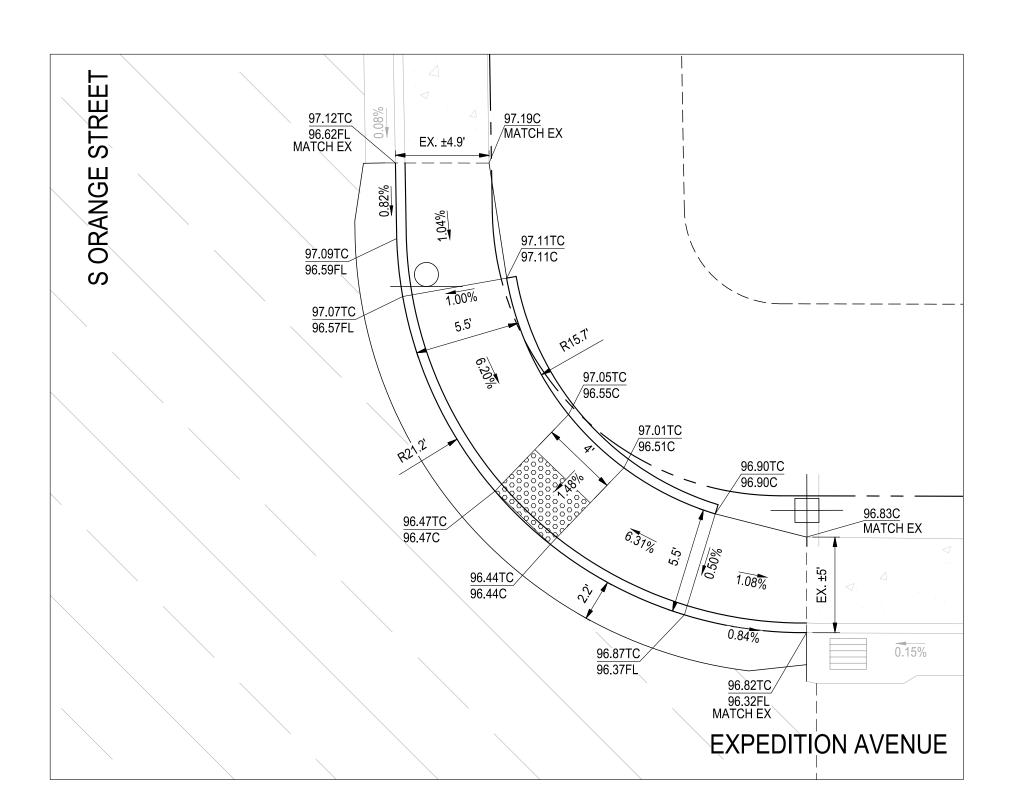


S ORANGE STREET & EXPEDITION AVENUE - NE CORNER

SCALE: 1" = 5'

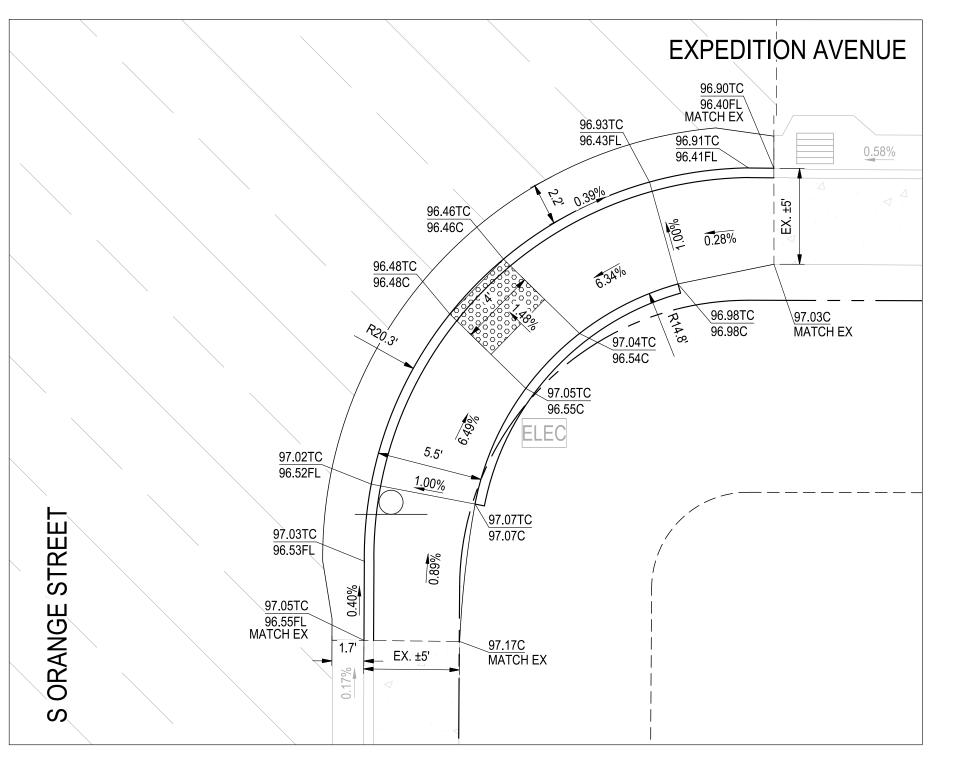


S ORANGE STREET & EXPEDITION AVENUE - SE CORNER

SCALE: 1" = 5'

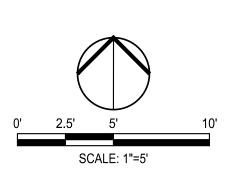


Know what's below.
Call before you dig.

NOTE:
ALL REFERENCES AND WRITTEN
DIMENSIONS SHALL SUPERCEDE
ALL SCALED DISTANCES AND
SHALL BE VERIFIED IN THE
FIELD. ANY DISCREPANCY
SHALL BE BROUGHT TO THE
ATTENTION OF THE ENGINEER
PRIOR TO THE COMMENCEMENT
OF WORK

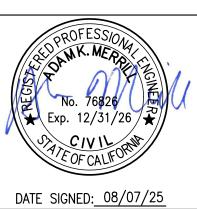



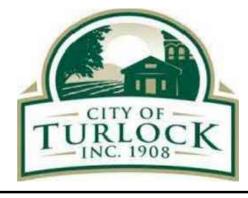


CITY OF TURLOCK MUNICIPAL SERVICES DEPARTMENT 156 S. BROADWAY, SUITE 150 (209) 668-5520


CURB RAMP DETAILS - S ORANGE STREET II

PROJECT NO. 23-069
CITY OF TURLOCK ROADS PROGRAM


verify scale	DRAWN BY: JR	DRAWING N
0 1"	REV. BY: AKM	
	CH. BY: AKM	69
	DATE: 8/7/2025	
	SCALE: SEE SHEET	SHEET:
	SEI PROJ NO: 22157	69 OF 1

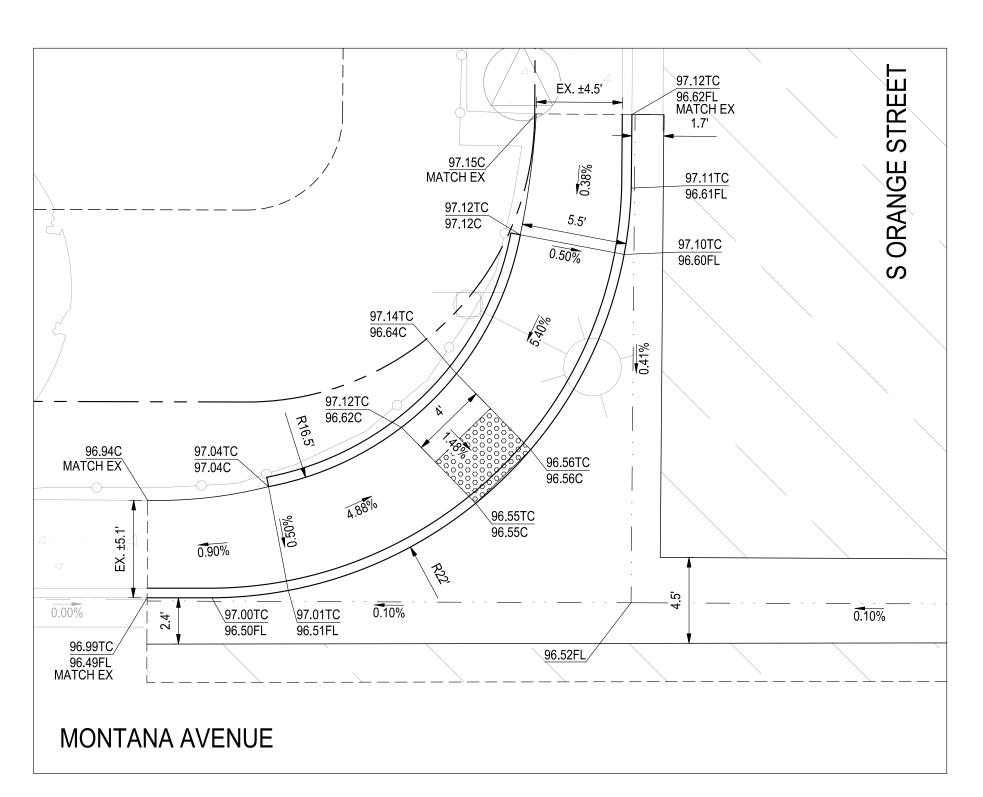


S ORANGE STREET & MONTANA AVENUE - NW CORNER

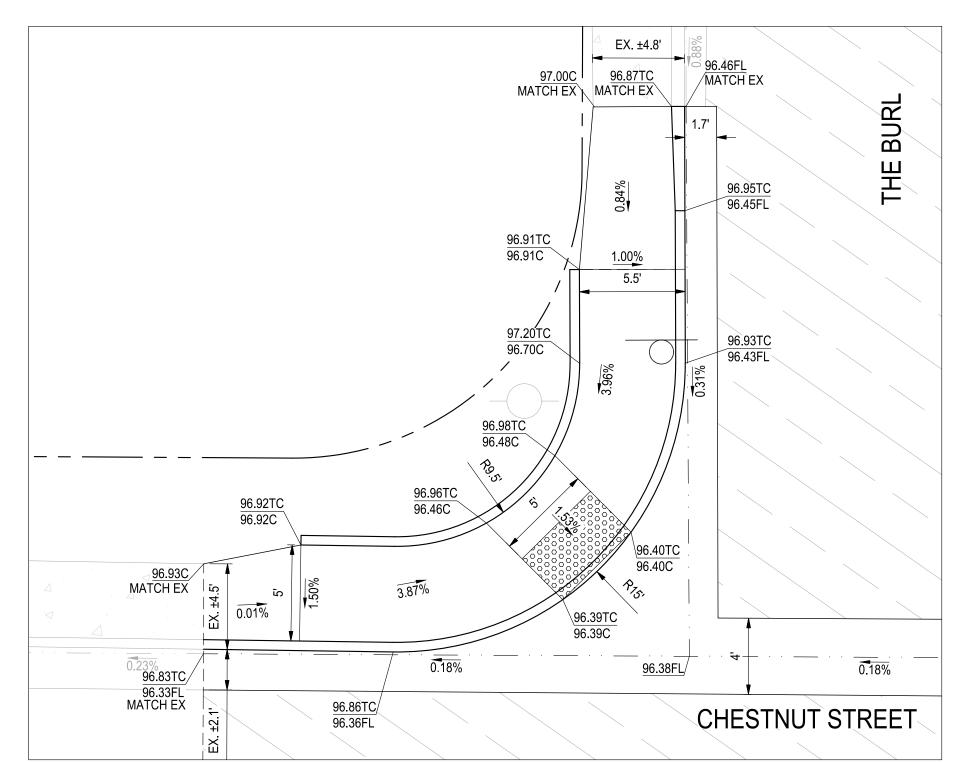

THE BURL & CHESTNUT STREET - NW CORNER SCALE: 1" = 5'

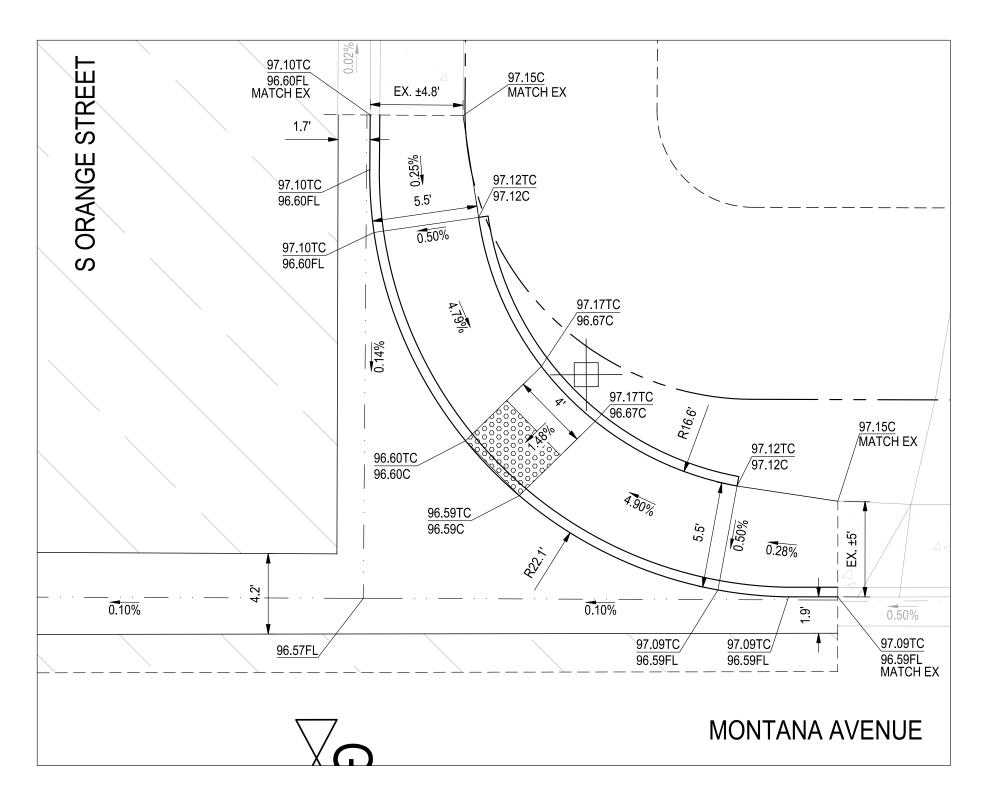


S ORANGE STREET & MONTANA AVENUE - NE CORNER

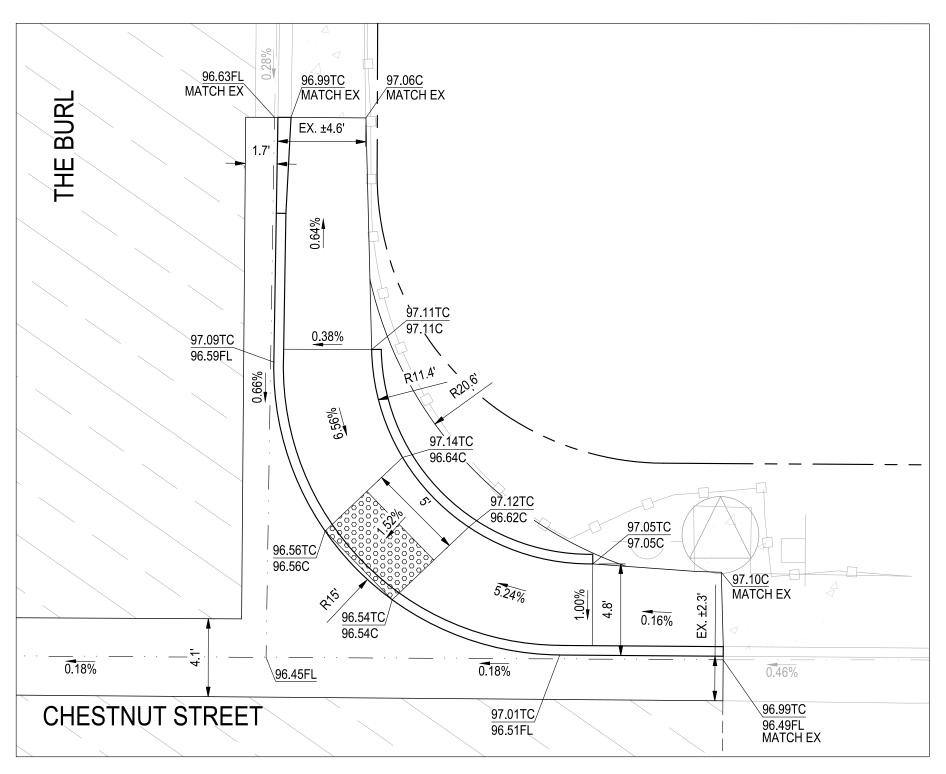


THE BURL & CHESTNUT STREET - NE CORNER

SCALE: 1" = 5'

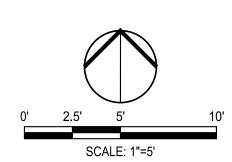

Know what's below.
Call before you dig.

ALL REFERENCES AND WRITTEN
DIMENSIONS SHALL SUPERCEDE
ALL SCALED DISTANCES AND
SHALL BE VERIFIED IN THE
FIELD. ANY DISCREPANCY
SHALL BE BROUGHT TO THE
ATTENTION OF THE ENGINEER PRIOR TO THE COMMENCEMENT OF WORK

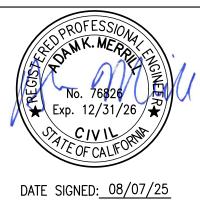






CITY OF TURLOCK MUNICIPAL SERVICES DEPARTMENT 156 S. BROADWAY, SUITE 150 (209) 668-5520

CURB RAMP DETAILS - S ORANGE III & THE BURL PROJECT NO. 23-069

CITY OF TURLOCK ROADS PROGRAM

ERIFY SCALE	DRAWN BY: JR	DRAWING NO.
1 "	REV. BY: AKM	
	CH. BY: AKM	70
	DATE: 8/7/2025	
	SCALE: SEE SHEET	SHEET:
	SEI PROJ NO: 22157	70 OF 117

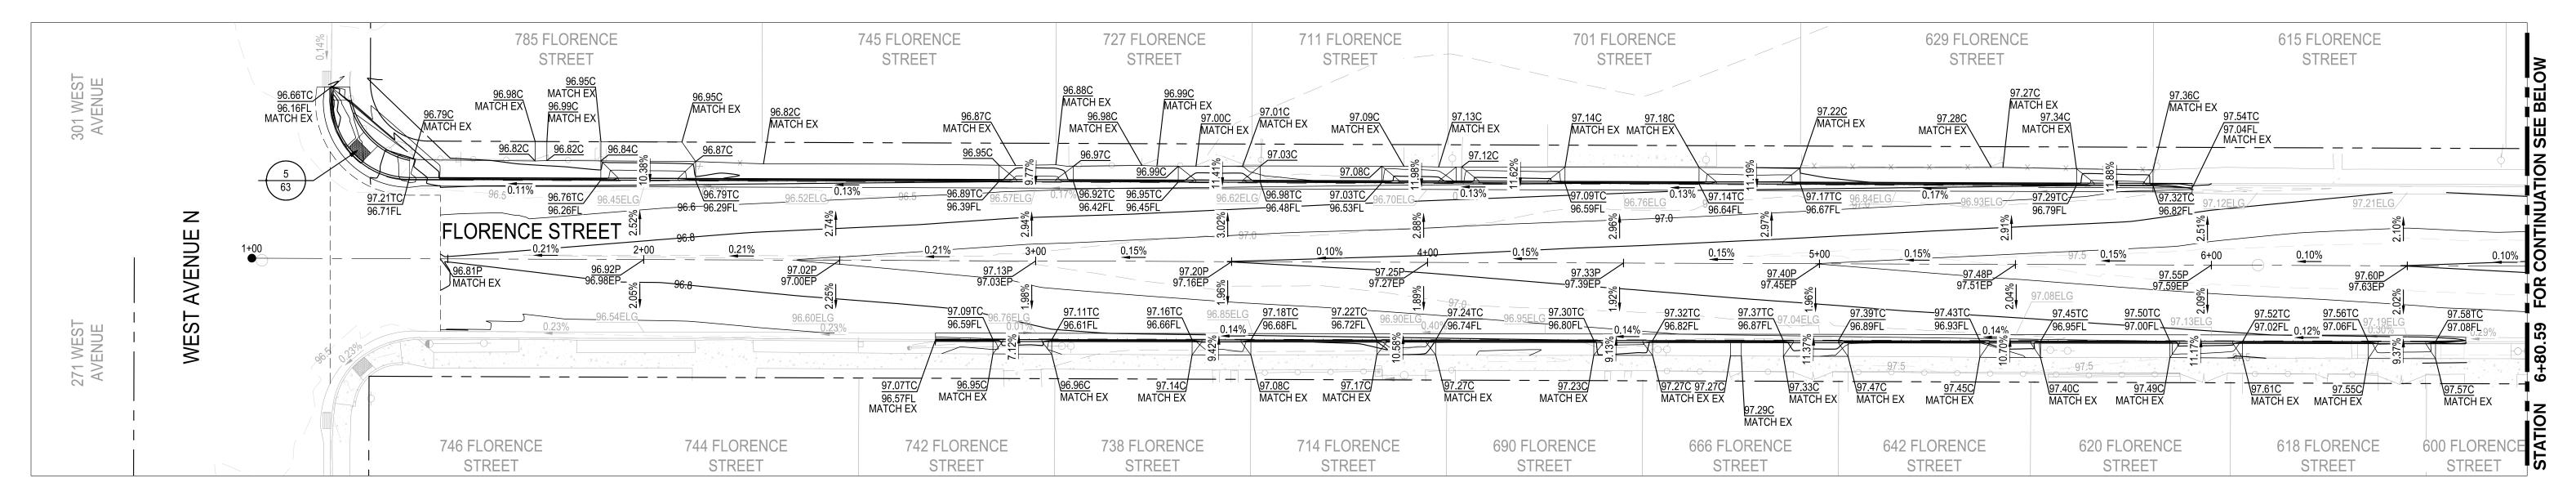

1 FLORENCE STREET STA: 1+00 TO 6+80.59

SEE SHEET 80 601/603 FLORENCE STREET 501 FLORENCE STREET M 589 FLORENCE 613 FLORENCE 557 FLORENCE 539 FLORENCE 525 FLORENCE STREET STREET STREET STREET STREET 98.370 MATCH EX 97.26ELG/ 98.9 98.46C 98.43C MATCH EX GRANT AVE_SDCB 1___98.09P_ 98.55C FL FLORENCE_SDCB 2 RIM 97.63 FLORENCE SDCB 3 594/596 FLORENCE 566 FLORENCE 552 FLORENCE 520 FLORENCE 600 FLORENCE 536 FLORENCE 500 FLORENCE STREET STREET STREET STREET STREET STREET STREET STREET N BEECH STREET FLORENCE STREET STA: 6+80.59 TO 13+17.53 SEE SHEET 80

ABBREVIATION	DESCRIPTION
BW	BACK OF WALK
С	CONCRETE
EC	EXISTING CONCRETE
EFL	EXISTING FLOWLINE
ELG	EXISTING LIP OF GUTTI
EG	EXISTING GROUND
EL	ELEVATION
EP	EXISTING PAVEMENT
EX.	EXISTING
FG	FINISH GROUND
FL	FLOWLINE
G	GROUND
GB	GRADE BREAK
HP	HIGH POINT

LOW POINT
MAXIMUM
MINIMUM
PAVEMENT
TOP OF CURB
TOP OF WALL
TYPICAL


GRADE SLOPE PERCENTAGE

**

EXISTING GRADE SLOPE PERCENTAGE


---- GRADE BREAK / RIDGE

LEGEND

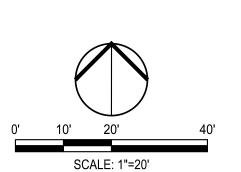




NOTE:
ALL REFERENCES AND WRITTEN
DIMENSIONS SHALL SUPERCEDE
ALL SCALED DISTANCES AND
SHALL BE VERIFIED IN THE
FIELD. ANY DISCREPANCY
SHALL BE BROUGHT TO THE
ATTENTION OF THE ENGINEER
PRIOR TO THE COMMENCEMENT
OF WORK

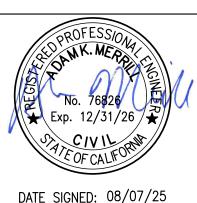



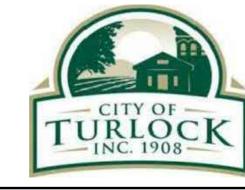


CITY OF TURLOCK
MUNICIPAL SERVICES DEPARTMENT
156 S. BROADWAY,
SUITE 150
(209) 668-5520

GRADING PLAN - FLORENCE STREET I PROJECT NO. 23-069

CITY OF TURLOCK ROADS PROGRAM

VERIFY SCALE	DRAWN BY: JR	DRAWING NO.
0 1"	REV. BY: AKM	
	CH. BY: AKM	71
	DATE: 8/7/2025	
	SCALE: SEE SHEET	SHFFT:
	SEI PROJ NO: 22157	71 OF 117
		ı.

N BEECH STREET

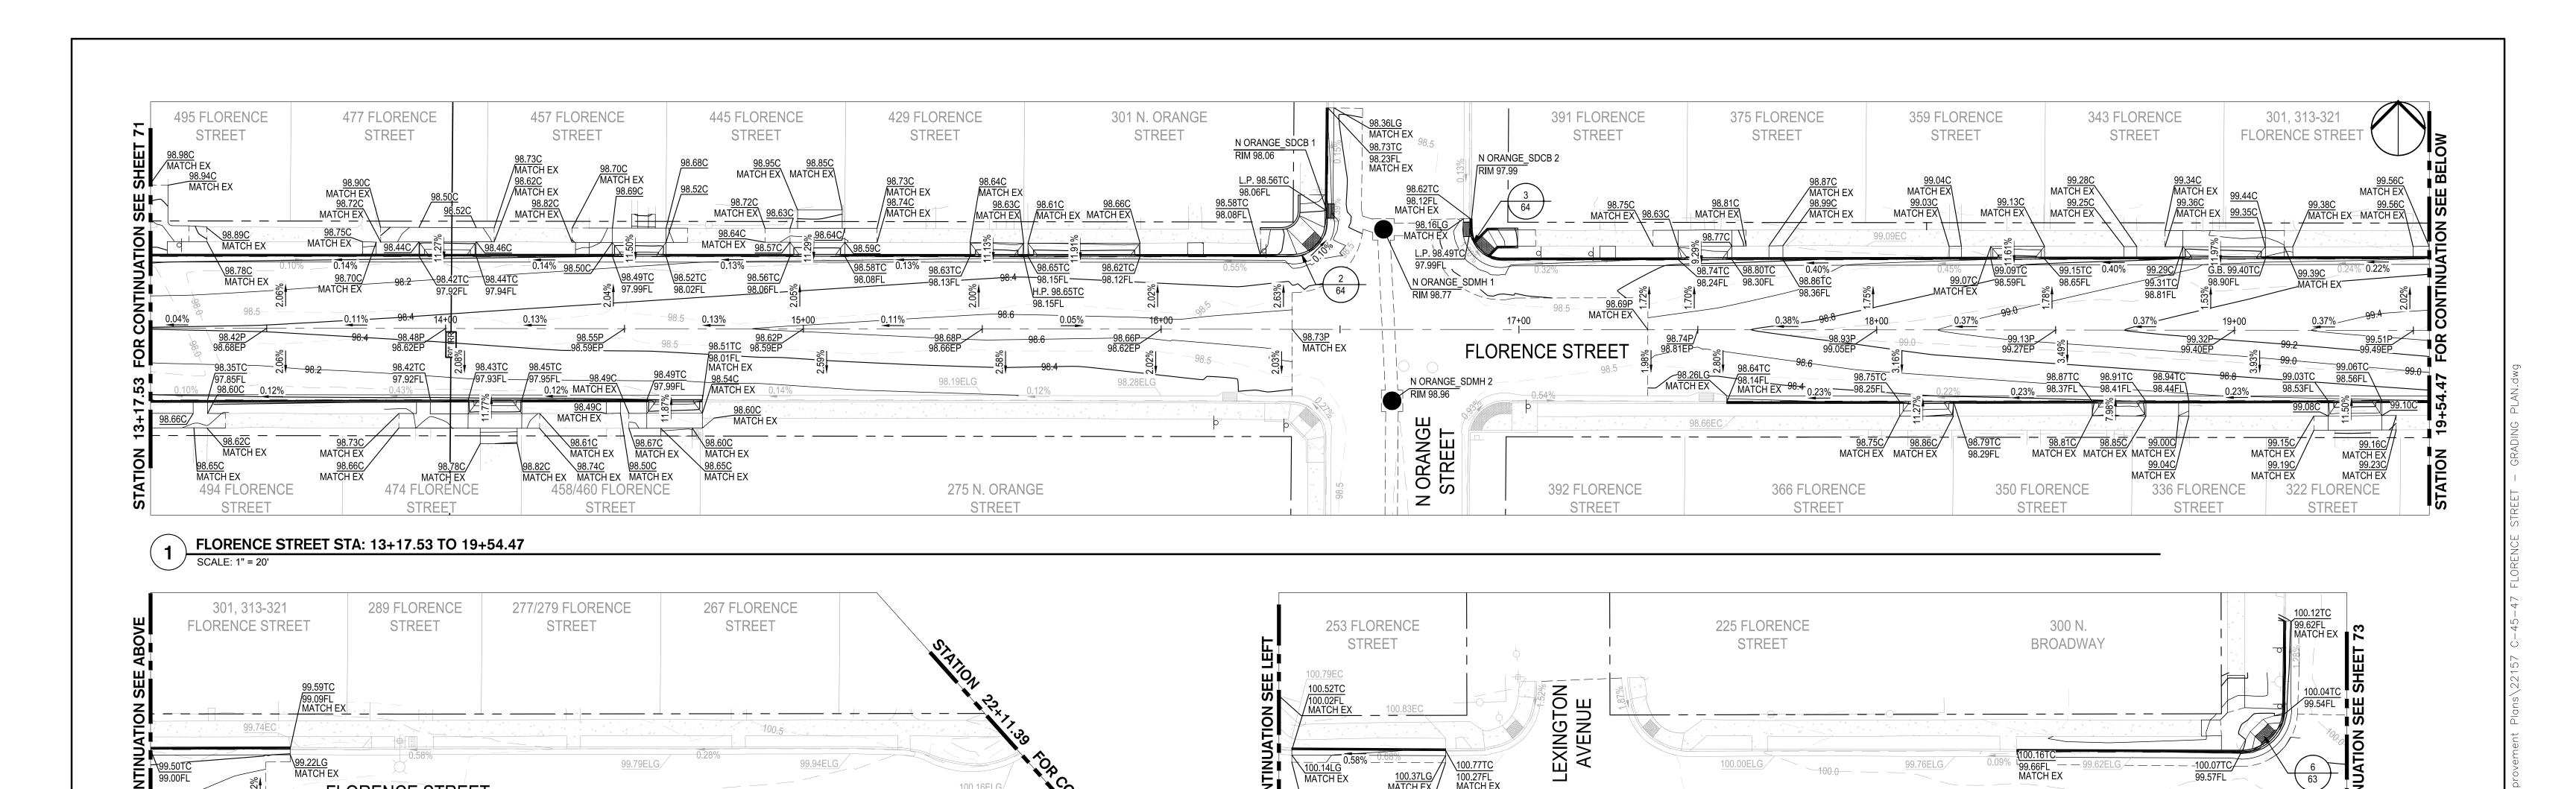

SEE SHEET 73 FLORENCE STREET STA: 19+54.47 TO 22+11.39

SCALE: 1" = 20'

300 FLORENCE

STREET

N LAUREL STREET

ARKING LOT FLORENCE STREET STA: 22+11.39 TO 25+09.95

FLORENCE STREET

GRADING LEGEND ABBREVIATION DESCRIPTION BACK OF WALK CONCRETE **EXISTING CONCRETE** EXISTING FLOWLINE EXISTING LIP OF GUTTER EXISTING GROUND ELEVATION **EXISTING PAVEMENT EXISTING** FINISH GROUND FLOWLINE GROUND GRADE BREAK HIGH POINT LOW POINT MAXIMUM MINIMUM **PAVEMENT** TOP OF CURB


TOP OF WALL TYPICAL

LEGEND GRADE SLOPE PERCENTAGE EXISTING GRADE SLOPE PERCENTAGE ---- GRADE BREAK / RIDGE

99.99ELG



ALL REFERENCES AND WRITTEN DIMENSIONS SHALL SUPERCEDE ALL SCALED DISTANCES AND SHALL BE VERIFIED IN THE FIELD. ANY DISCREPANCY
SHALL BE BROUGHT TO THE
ATTENTION OF THE ENGINEER PRIOR TO THE COMMENCEMENT OF WORK

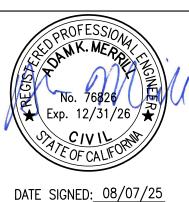


99.60ELG



244 N.

BROADWAY

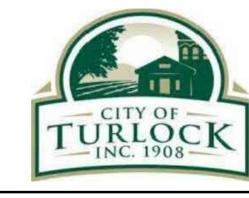

CITY OF TURLOCK MUNICIPAL SERVICES DEPARTMENT 156 S. BROADWAY, SUITE 150 (209) 668-5520

GRADING PLAN - FLORENCE STREET II PROJECT NO. 23-069 CITY OF TURLOCK ROADS PROGRAM


DRAWN BY: JR	DRAWING NO.
REV. BY: AKM	
CH. BY: AKM	72
DATE: 8/7/2025	
SCALE: SEE SHEET	SHFFT:
SEI PROJ NO: 22157	72 OF 117
	REV. BY: AKM CH. BY: AKM DATE: 8/7/2025 SCALE: SEE SHEET

SCALE: 1"=20'


100.21ELG

250 N.

BROADWAY

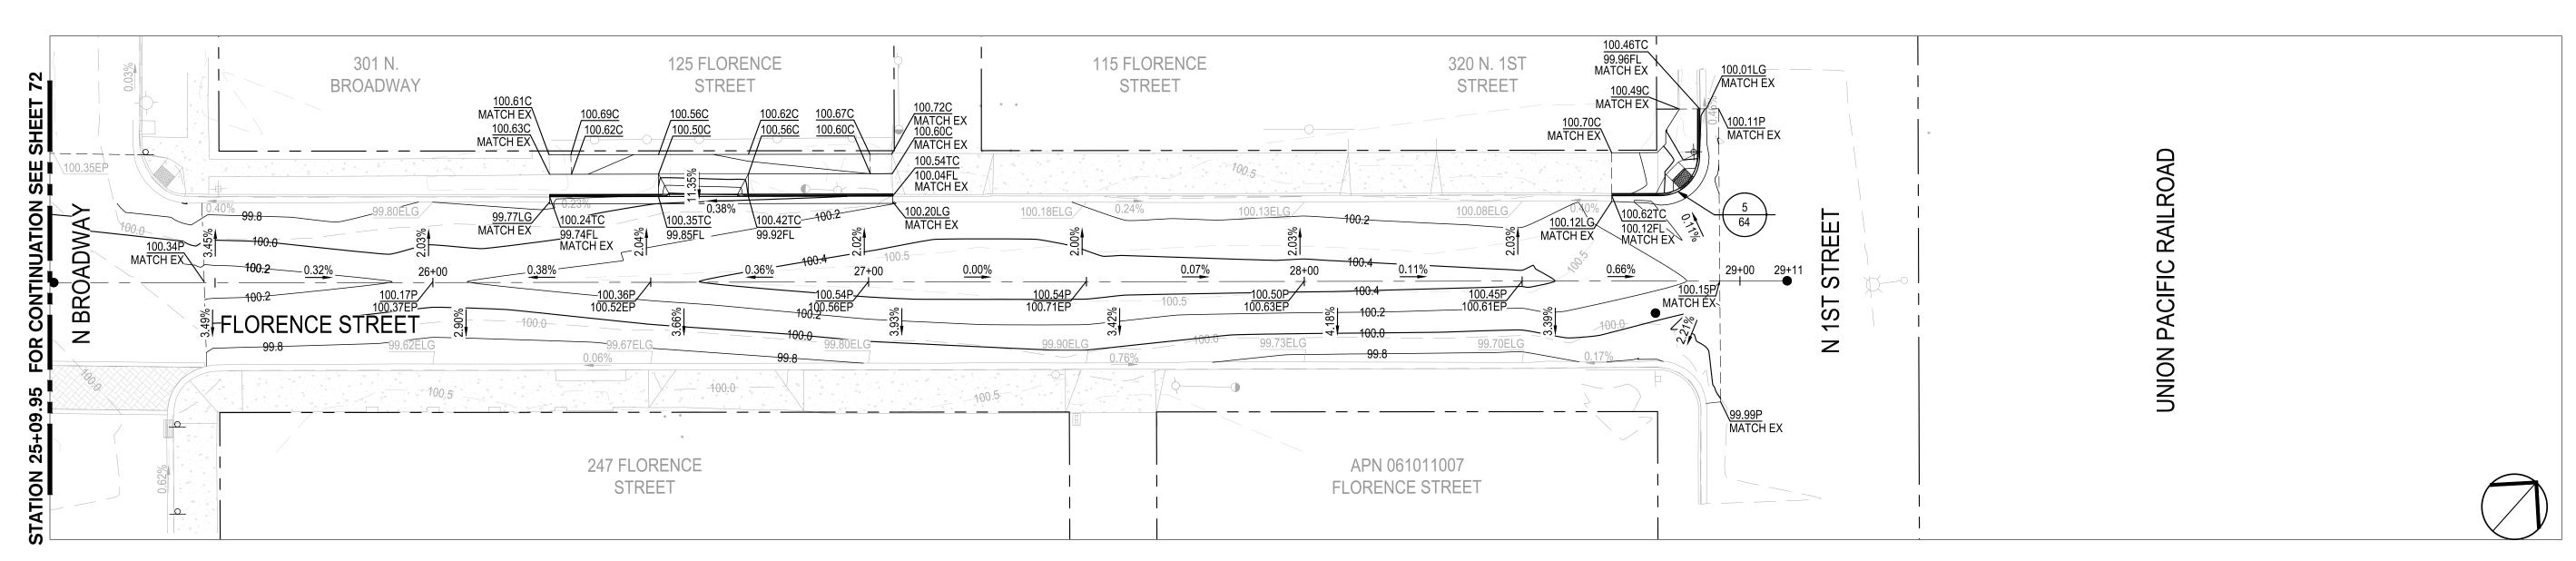

1 FLORENCE STREET STA: 25+09.95 TO END

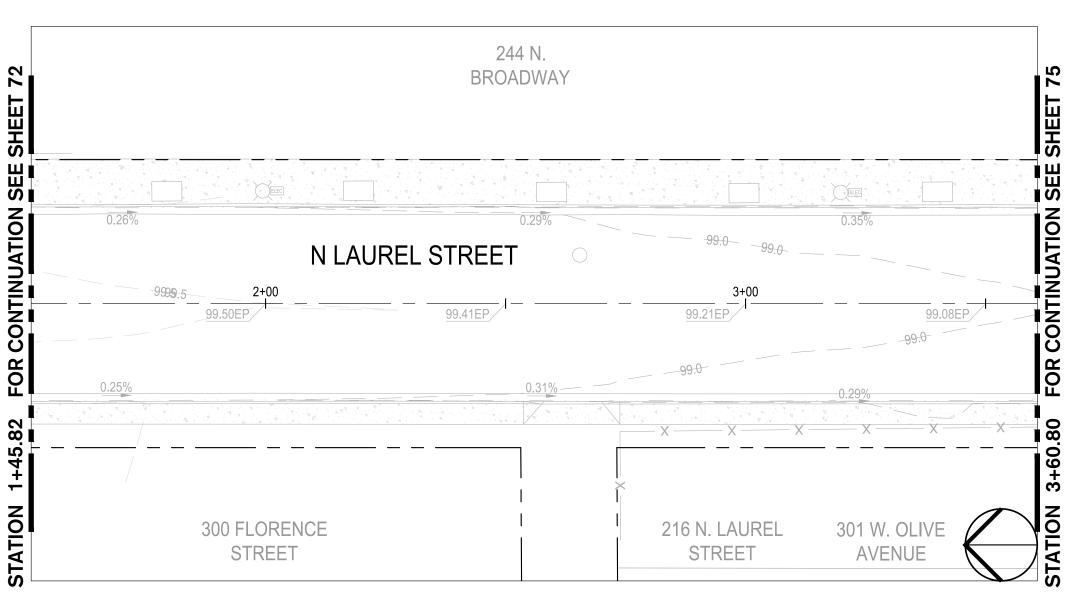

N. LAUREL STREET STA: 1+45.82 TO 3+60.80

SCALE: 1" = 20'

GRADING LEGEND	
ABBREVIATION	DESCRIPTION
BW	BACK OF WALK
С	CONCRETE
EC	EXISTING CONCRETE
EFL	EXISTING FLOWLINE
ELG	EXISTING LIP OF GUTTER
EG	EXISTING GROUND
EL	ELEVATION
EP	EXISTING PAVEMENT
EX.	EXISTING
FG	FINISH GROUND
FL	FLOWLINE
G	GROUND
GB	GRADE BREAK
HP	HIGH POINT
LP	LOW POINT
MAX	MAXIMUM
MIN	MINIMUM
Р	PAVEMENT
TC	TOP OF CURB
TOW	TOP OF WALL
TYP	TYPICAL

	F	G	F	N	ח
느	_	<u> </u>	_	1.4	_


GRADE SLOPE PERCENTAGE

**


EXISTING GRADE SLOPE PERCENTAGE



NOTE:
ALL REFERENCES AND WRITTEN
DIMENSIONS SHALL SUPERCEDE
ALL SCALED DISTANCES AND
SHALL BE VERIFIED IN THE
FIELD. ANY DISCREPANCY
SHALL BE BROUGHT TO THE
ATTENTION OF THE ENGINEER
PRIOR TO THE COMMENCEMENT
OF WORK

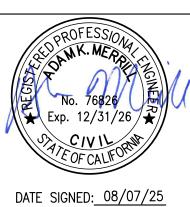



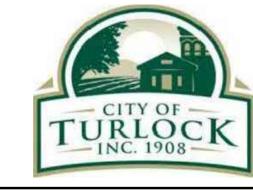


CITY OF TURLOCK MUNICIPAL SERVICES DEPARTMENT 156 S. BROADWAY, SUITE 150 (209) 668-5520

RIFY SCALE	DRAWN BY: JR	DRAWING NO.
1 "	REV. BY: AKM	
	CH. BY: AKM	73
	DATE: 8/7/2025	
	SCALE: SEE SHEET	SHEET:
	SEI PROJ NO: 22157	73 OF 117

SCALE: 1"=20'

GRADING PLAN - FLORENCE STREET III
PROJECT NO. 23-069

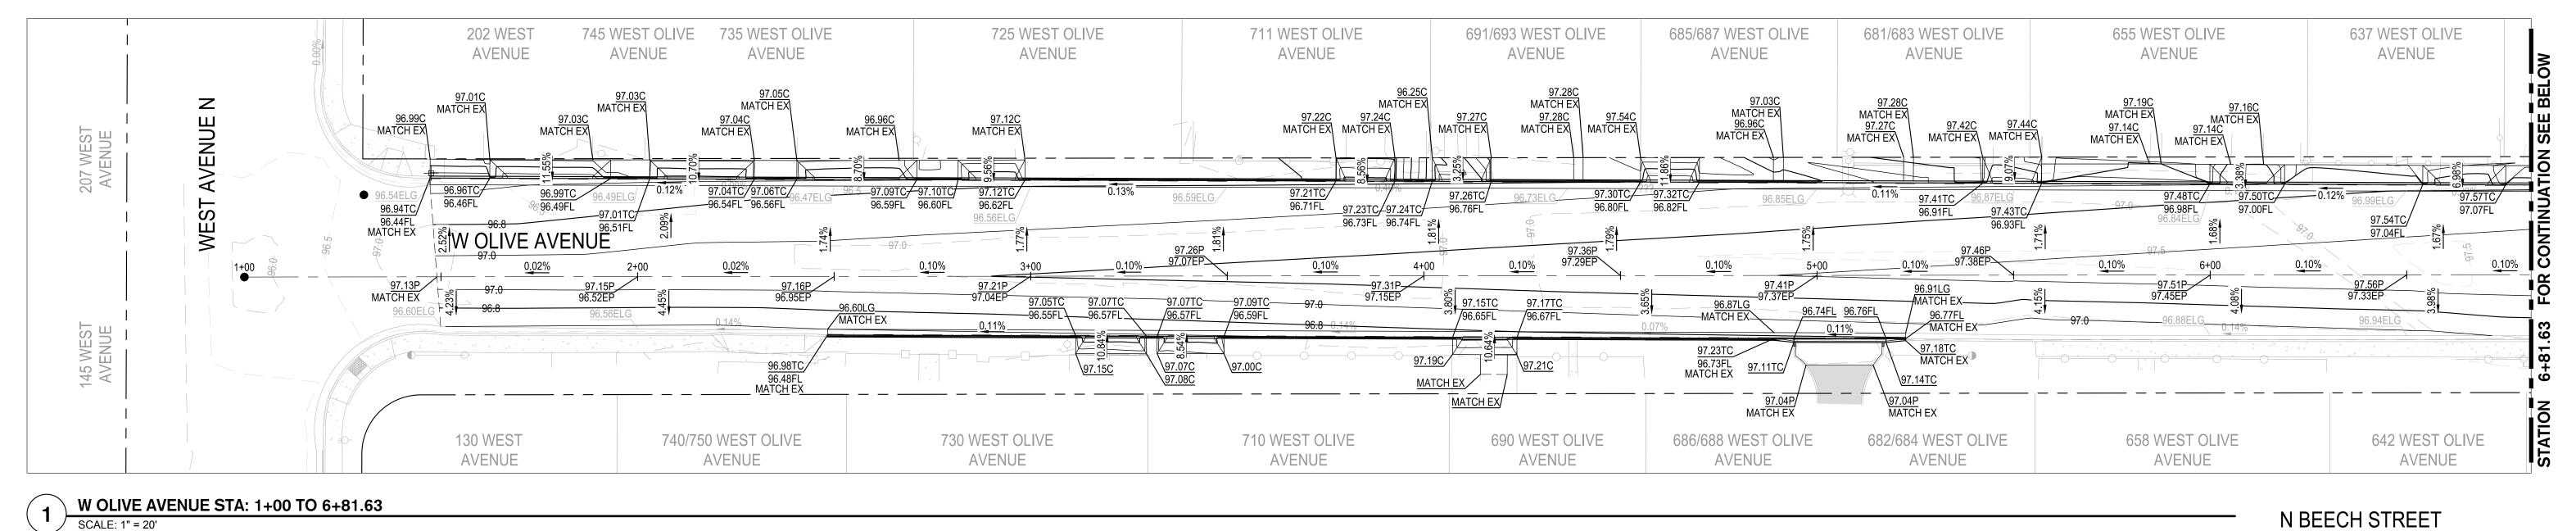

W OLIVE AVENUE STA: 1+00 TO 6+81.63

SEE SHEET 80 601 WEST OLIVE 589 WEST OLIVE 525 WEST OLIVE 605 WEST OLIVE 567 WEST OLIVE 553 WEST OLIVE 537 WEST OLIVE 501 WEST OLIVE **AVENUE AVENUE AVENUE AVENUE AVENUE AVENUE AVENUE AVENUE WOLIVE AVENUE** 97.86C, MATCH EX 500 WEST OLIVE 109 GRANT 586 WEST OLIVE 572 WEST OLIVE 546 WEST OLIVE 524 WEST OLIVE 630 WEST OLIVE 560 WEST OLIVE **AVENUE AVENUE AVENUE AVENUE AVENUE AVENUE AVENUE AVENUE** N BEECH STREET

W OLIVE AVENUE STA: 6+81.63 TO 13+18.57

ABBREVIATION DESCRIPTION BACK OF WALK CONCRETE **EXISTING CONCRETE** EXISTING FLOWLINE EXISTING LIP OF GUTTER EXISTING GROUND ELEVATION **EXISTING PAVEMENT EXISTING** FINISH GROUND FLOWLINE GROUND GRADE BREAK HIGH POINT LOW POINT MAXIMUM MINIMUM

PAVEMENT TOP OF CURB TOP OF WALL TYPICAL

GRADING LEGEND

LEGEND

GRADE SLOPE PERCENTAGE

EXISTING GRADE SLOPE PERCENTAGE


GRADE BREAK / RIDGE




SCALE: 1"=20'



ALL REFERENCES AND WRITTEN DIMENSIONS SHALL SUPERCEDE ALL SCALED DISTANCES AND SHALL BE VERIFIED IN THE FIELD. ANY DISCREPANCY SHALL BE BROUGHT TO THE ATTENTION OF THE ENGINEER PRIOR TO THE COMMENCEMENT OF WORK

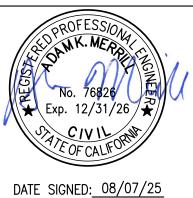



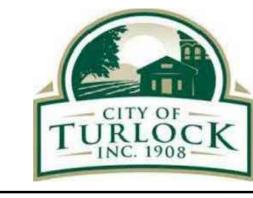


CITY OF TURLOCK MUNICIPAL SERVICES DEPARTMENT 156 S. BROADWAY, SUITE 150 (209) 668 - 5520


GRADING PLAN - W OLIVE AVE I

PROJECT NO. 23-069 CITY OF TURLOCK ROADS PROGRAM


VERIFY SCALE	DRAWN BY: JR	DRAWING NO
0 1"	REV. BY: AKM	
	CH. BY: AKM	74
	DATE: 8/7/2025	
	SCALE: SEE SHEET	SHEET:
	SEI PROJ NO: 22157	74 OF 11

SEE SHEET 80

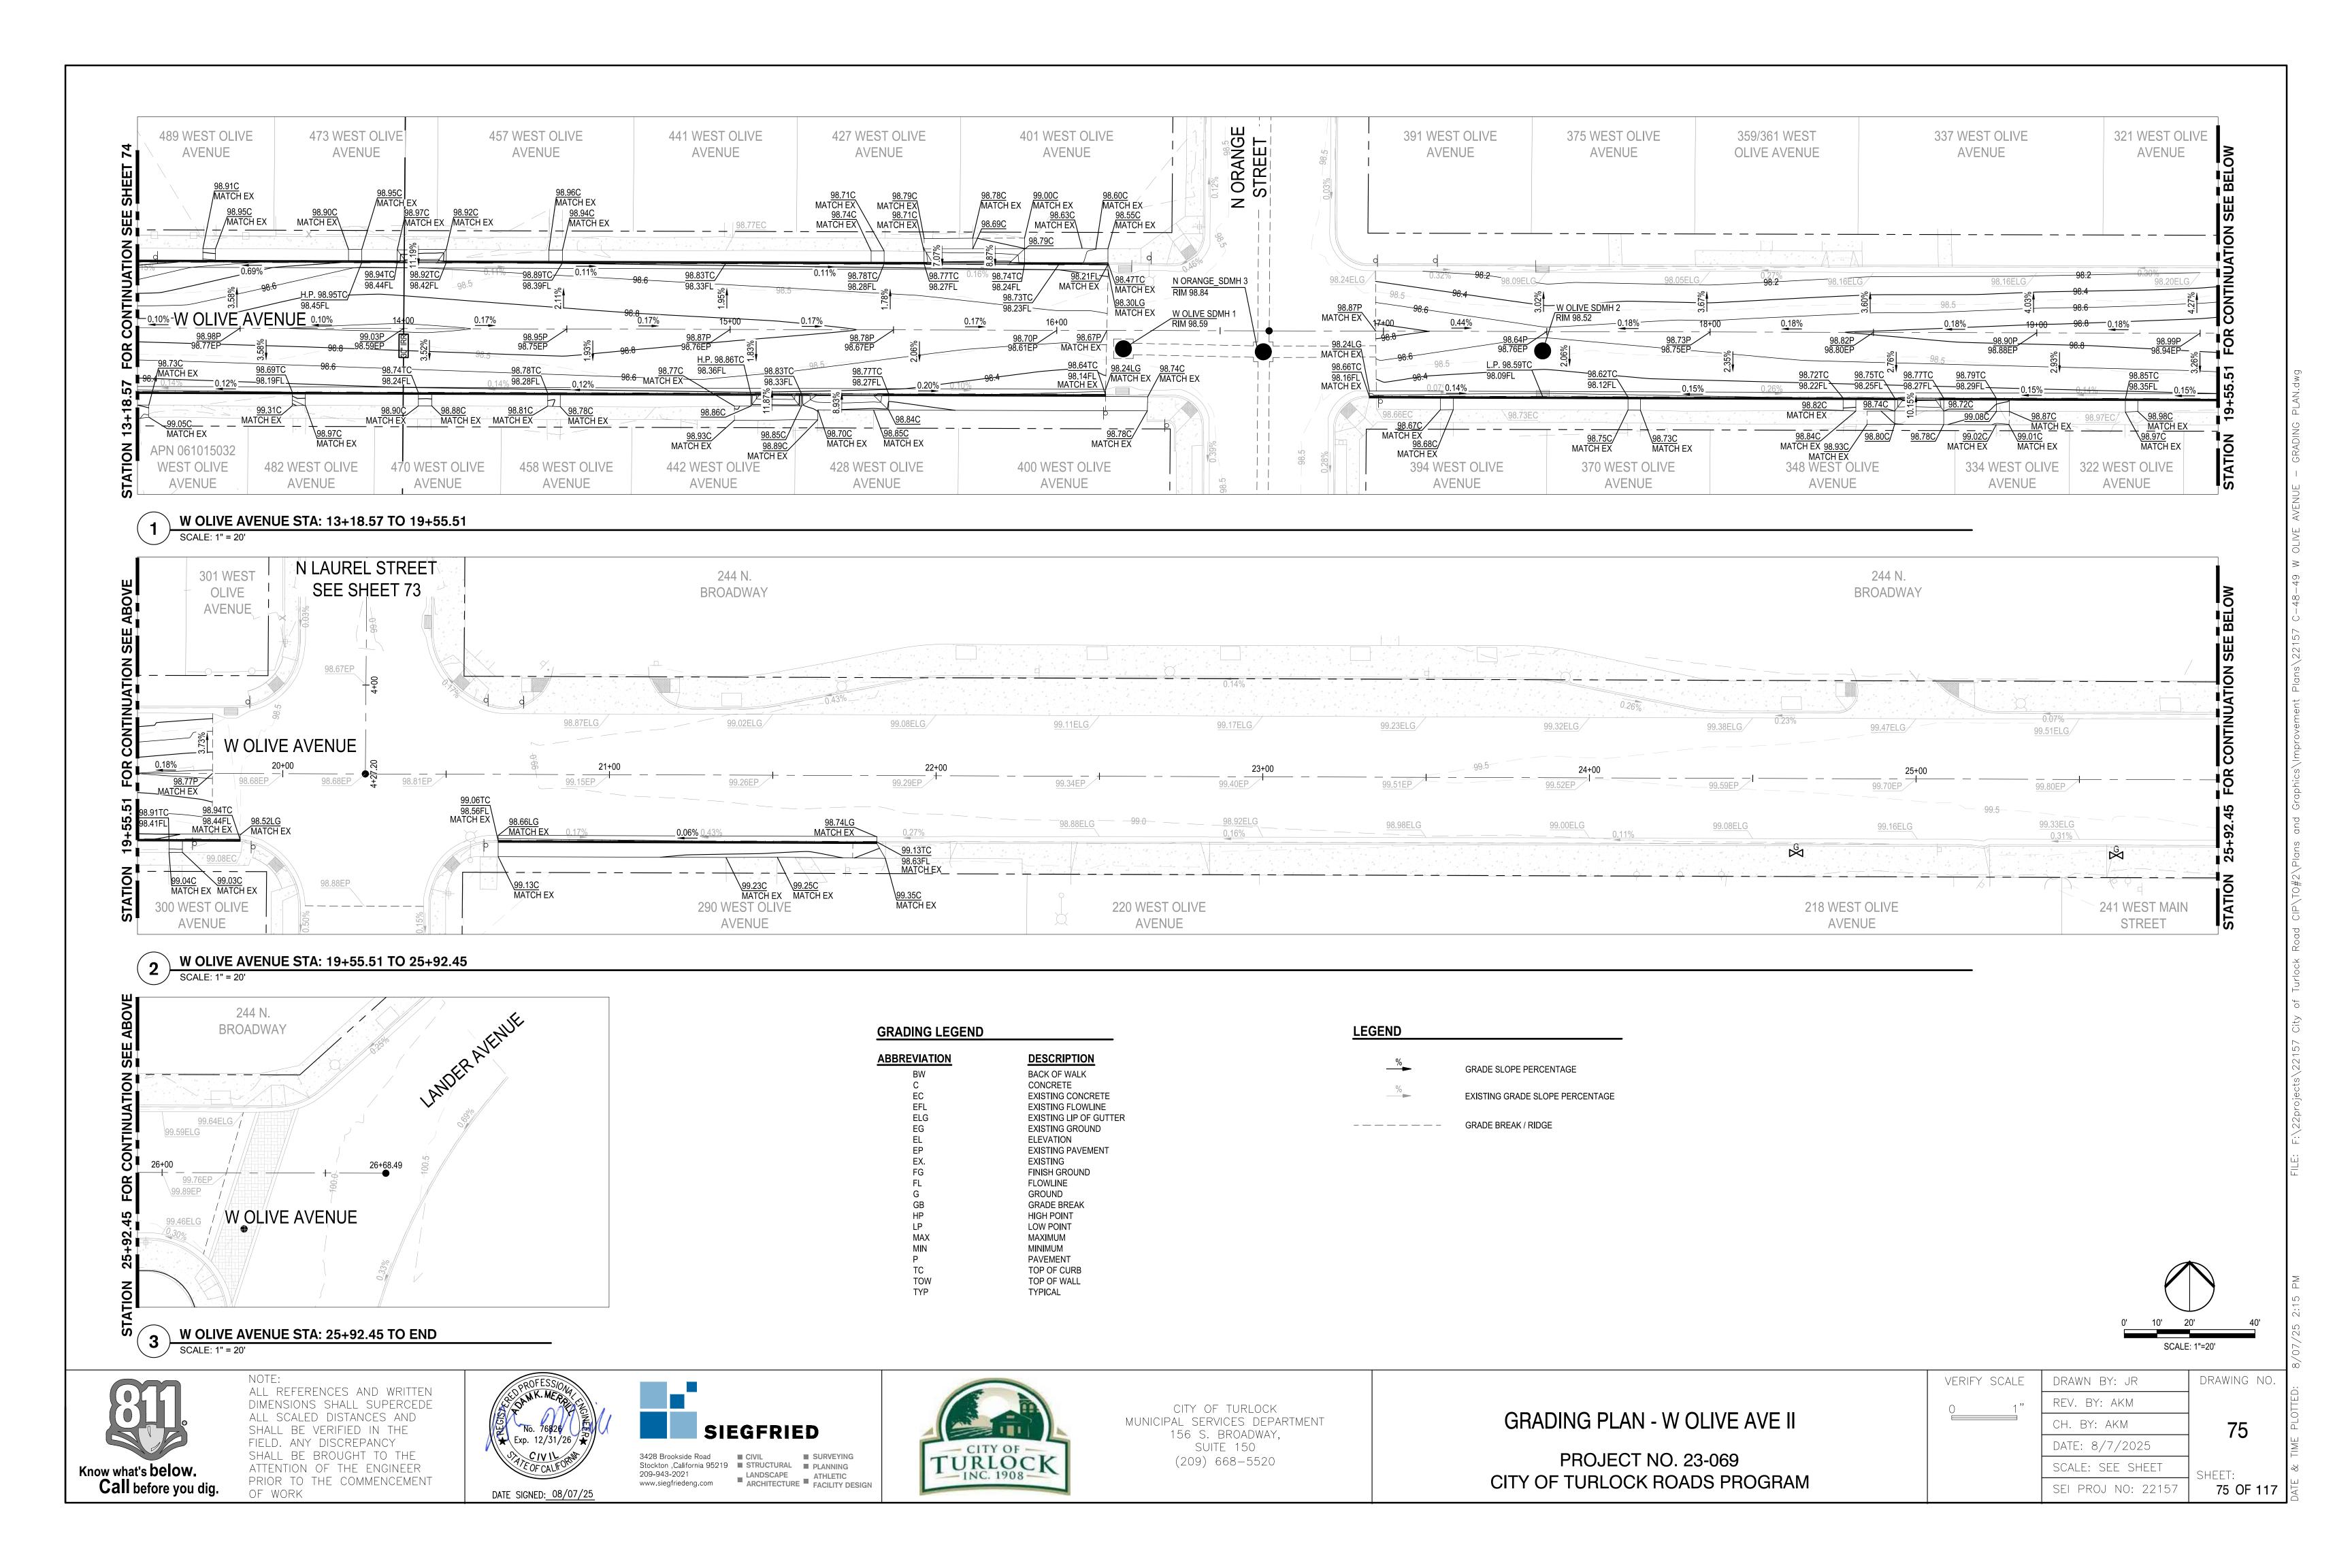

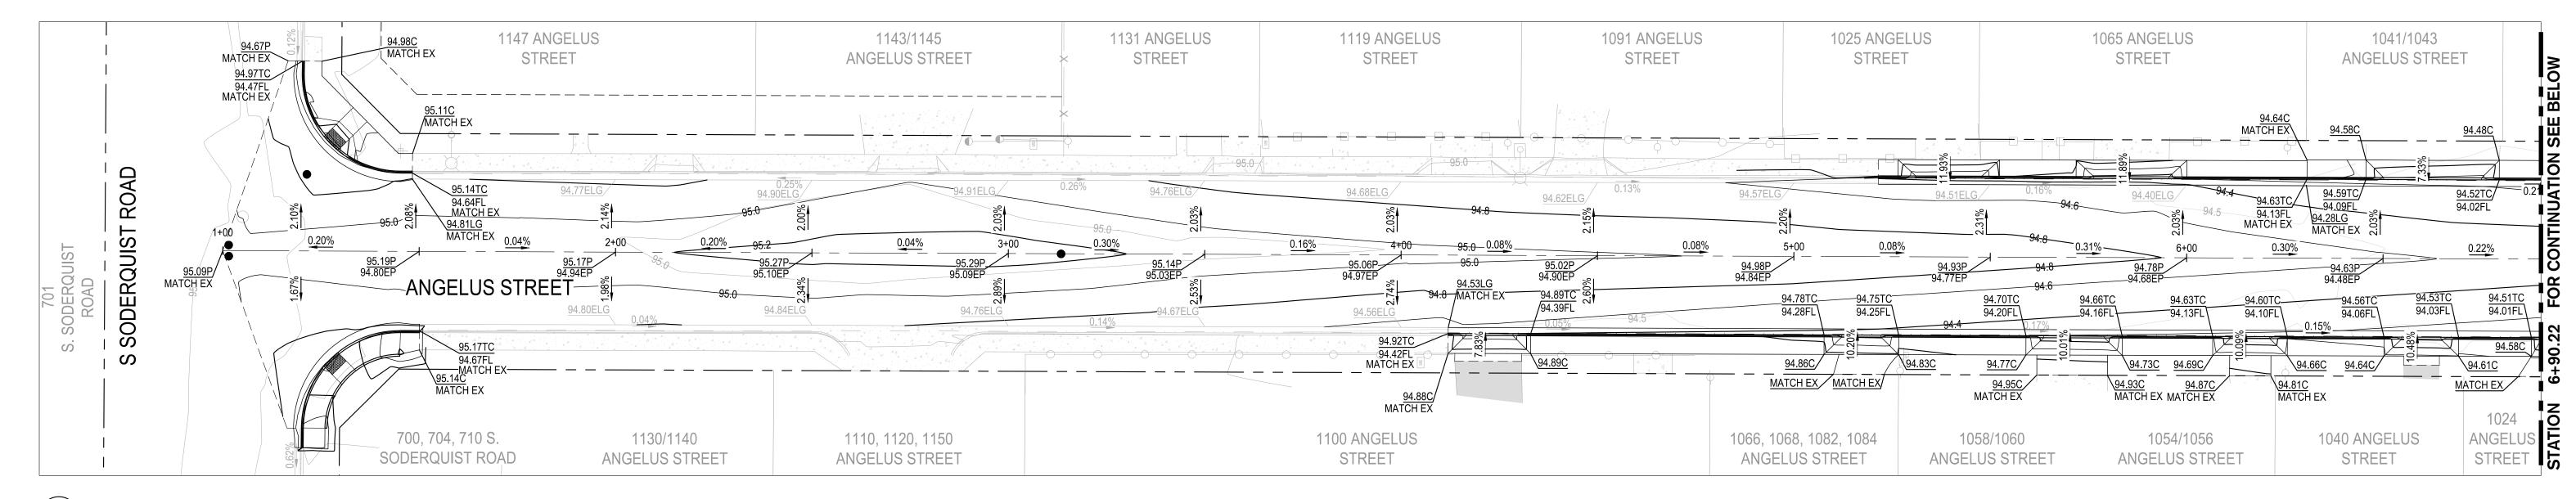

1 ANGELUS STREET STA: 1+00 TO 6+90.22

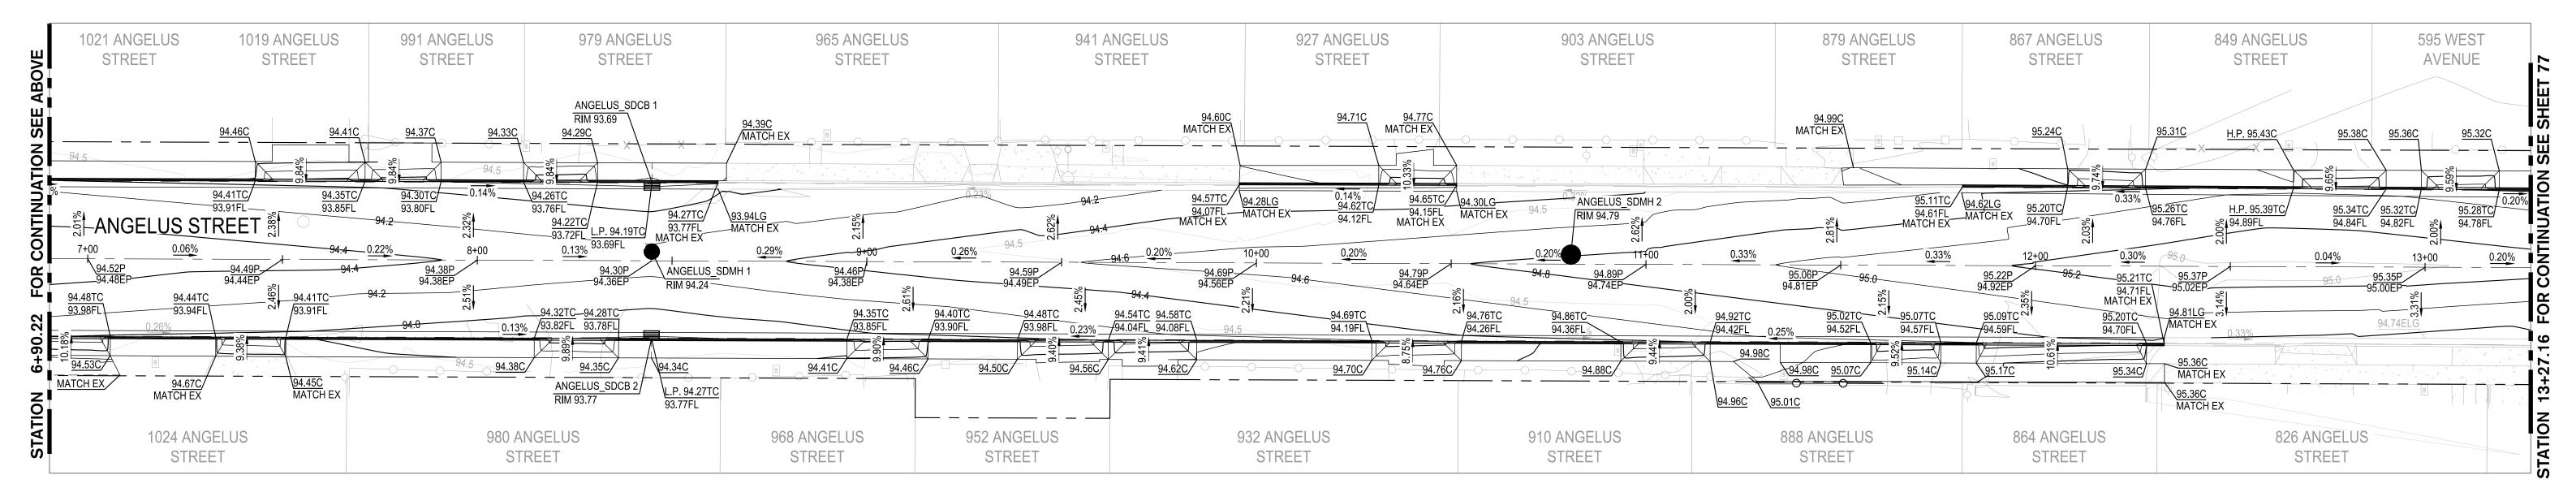

2 ANGELUS STREET STA: 6+90.22 TO 13+27.16


GRADING LEGEND	
ABBREVIATION	DESCRIPTION
BW	BACK OF WALK
С	CONCRETE
EC	EXISTING CONCRETE
EFL	EXISTING FLOWLINE
ELG	EXISTING LIP OF GUTTER
EG	EXISTING GROUND
EL	ELEVATION
EP	EXISTING PAVEMENT
EX.	EXISTING
FG	FINISH GROUND
FL	FLOWLINE
G	GROUND
GB	GRADE BREAK
HP	HIGH POINT
LP	LOW POINT
MAX	MAXIMUM
MIN	MINIMUM
Р	PAVEMENT
TC	TOP OF CURB
TOW	TOP OF WALL

TYPICAL

LEGEND


GRADE SLOPE PERCENTAGE

EXISTING GRADE SLOPE PERCENTAGE

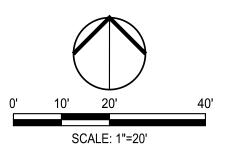


Know what's below.
Call before you dig.

NOTE:
ALL REFERENCES AND WRITTEN
DIMENSIONS SHALL SUPERCEDE
ALL SCALED DISTANCES AND
SHALL BE VERIFIED IN THE
FIELD. ANY DISCREPANCY
SHALL BE BROUGHT TO THE
ATTENTION OF THE ENGINEER
PRIOR TO THE COMMENCEMENT
OF WORK

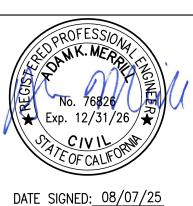



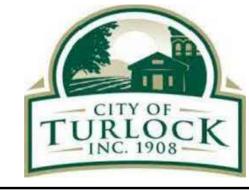


CITY OF TURLOCK
MUNICIPAL SERVICES DEPARTMENT
156 S. BROADWAY,
SUITE 150
(209) 668-5520

GRADING PLAN - ANGELUS STREET I


PROJECT NO. 23-069
CITY OF TURLOCK ROADS PROGRAM

ERIFY SCALE	DRAWN BY: JR	DRAWING NO
) 1"	REV. BY: AKM	
	CH. BY: AKM	76
	DATE: 8/7/2025	
	SCALE: SEE SHEET	SHEET:
	SEI PROJ NO: 22157	76 OF 117

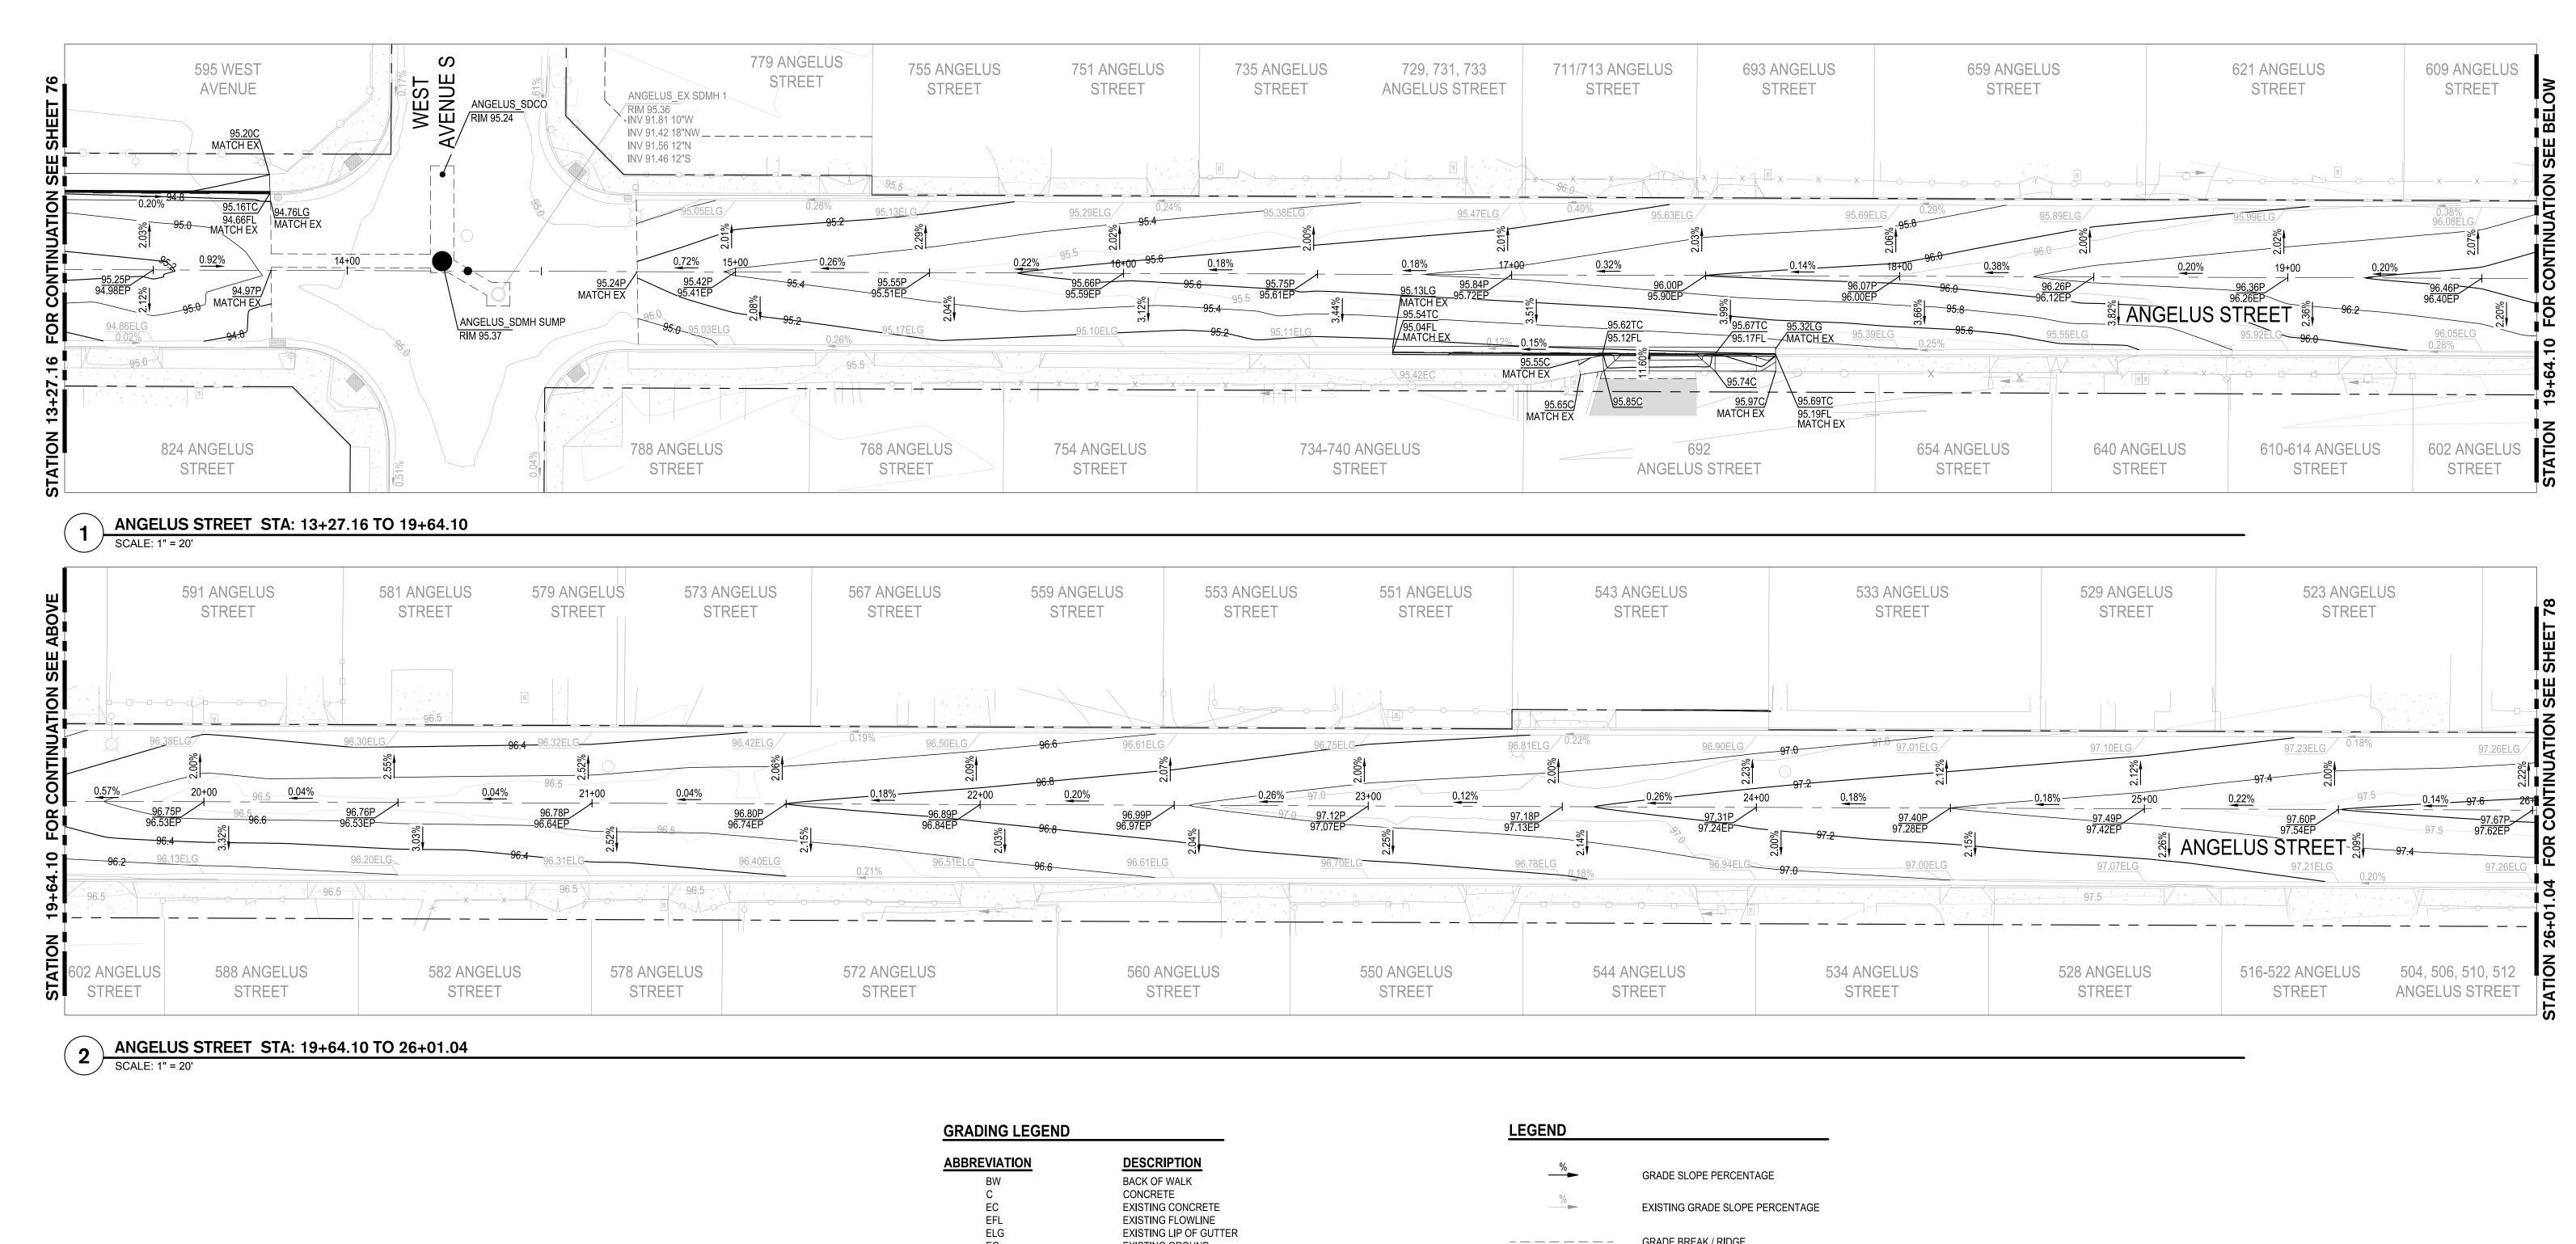


EXISTING GROUND ELEVATION EXISTING PAVEMENT **EXISTING** FINISH GROUND FLOWLINE GROUND GRADE BREAK HIGH POINT LOW POINT MAXIMUM MINIMUM PAVEMENT TOP OF CURB TOP OF WALL TYPICAL

GRADE BREAK / RIDGE

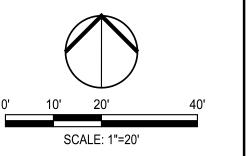




NOTE:
ALL REFERENCES AND WRITTEN
DIMENSIONS SHALL SUPERCEDE
ALL SCALED DISTANCES AND
SHALL BE VERIFIED IN THE
FIELD. ANY DISCREPANCY
SHALL BE BROUGHT TO THE
ATTENTION OF THE ENGINEER
PRIOR TO THE COMMENCEMENT
OF WORK

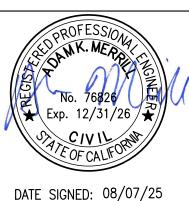



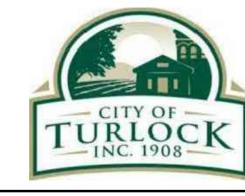


CITY OF TURLOCK
MUNICIPAL SERVICES DEPARTMENT
156 S. BROADWAY,
SUITE 150
(209) 668-5520

GRADING PLAN - ANGELUS STREET II

PROJECT NO. 23-069
CITY OF TURLOCK ROADS PROGRAM

VERIFY SCALE	DRAWN BY: JR	DRAWING NO
0 1"	REV. BY: AKM	
	CH. BY: AKM	77
	DATE: 8/7/2025	
	SCALE: SEE SHEET	SHEET:
	SEI PROJ NO: 22157	77 OF 11

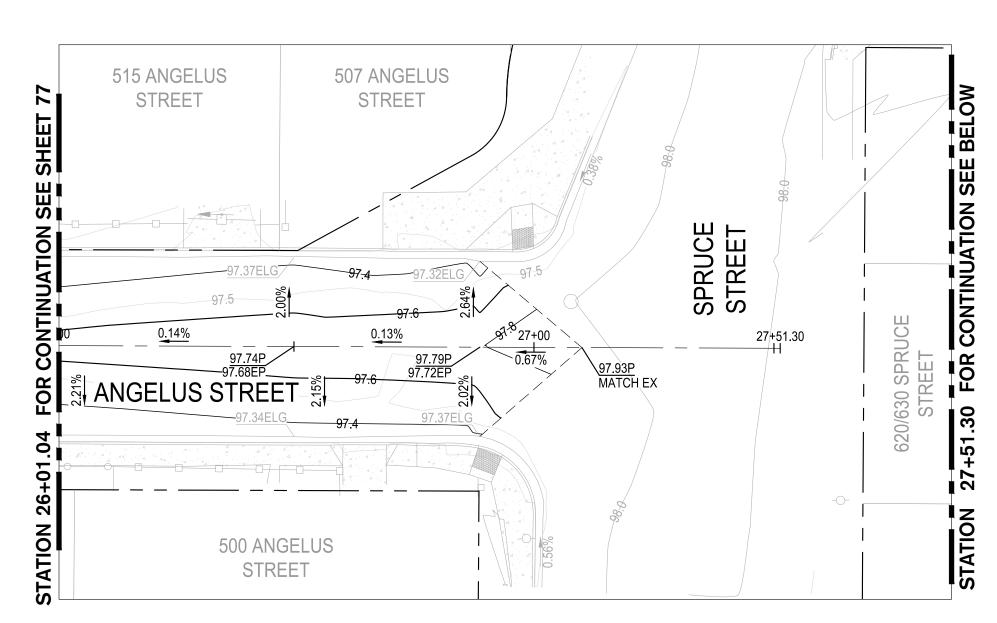

ANGELUS STREET STA: 26+01.04 TO 27+51.30

333 ANGELUS STREET 495 ANGELUS 591 S. ORANGE 387 ANGELUS 375 ANGELUS 353 ANGELUS 319 ANGELUS 303 ANGELUS STREET STREET STREET STREET STREET STREET 97.49C MATCH EX\ <u>97.58C</u> MATCH EX 97.55EC 97.82P 98.15EP NANGELUS STREET 97.56C 97.59C MATCH EX S ORANGE STREET 97.82EC X X 97.81C MATCH EX SPRUCE STREET 306 ANGELUS 600 SPRUCE 601 S. ORANGE 320 ANGELUS 392 ANGELUS 380/382 ANGELUS 344 ANGELUS 364 ANGELUS 334/336 ANGELUS STREET STREET STREET STREET STREET STREET STREET STREET STREET

ANGELUS STREET STA: 27+51.30 TO 33+29.78

GRADING LEGEND	
ABBREVIATION	DESCRIPTION
BW	BACK OF WALK
C	CONCRETE
EC	EXISTING CONCRETE
EFL	EXISTING FLOWLINE
ELG	EXISTING LIP OF GUTTER
EG	EXISTING GROUND
EL	ELEVATION
EP	EXISTING PAVEMENT
EX.	EXISTING
FG	FINISH GROUND
FL	FLOWLINE
G	GROUND
GB	GRADE BREAK
HP	HIGH POINT
LP	LOW POINT
MAX	MAXIMUM
MIN	MINIMUM
Р	PAVEMENT
TC	TOP OF CURB
TOW	TOP OF WALL
TYP	TYPICAL

LEGEND


GRADE SLOPE PERCENTAGE

EXISTING GRADE SLOPE PERCENTAGE

---- GRADE BREAK / RIDGE



ALL REFERENCES AND WRITTEN DIMENSIONS SHALL SUPERCEDE
ALL SCALED DISTANCES AND
SHALL BE VERIFIED IN THE
FIELD. ANY DISCREPANCY
SHALL BE BROUGHT TO THE
ATTENTION OF THE ENGINEER PRIOR TO THE COMMENCEMENT OF WORK

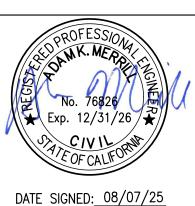






CITY OF TURLOCK MUNICIPAL SERVICES DEPARTMENT 156 S. BROADWAY,
SUITE 150 (209) 668-5520


GRADING PLAN - ANGELUS STREET III

ERIFY SCALE	DRAWN BY: JR	DRAWING NO
) 1"	REV. BY: AKM	
·	CH. BY: AKM	78
	DATE: 8/7/2025	
	SCALE: SEE SHEET	SHEET:
	SEI PROJ NO: 22157	78 OF 117

PROJECT NO. 23-069 CITY OF TURLOCK ROADS PROGRAM SCALE: 1"=20'

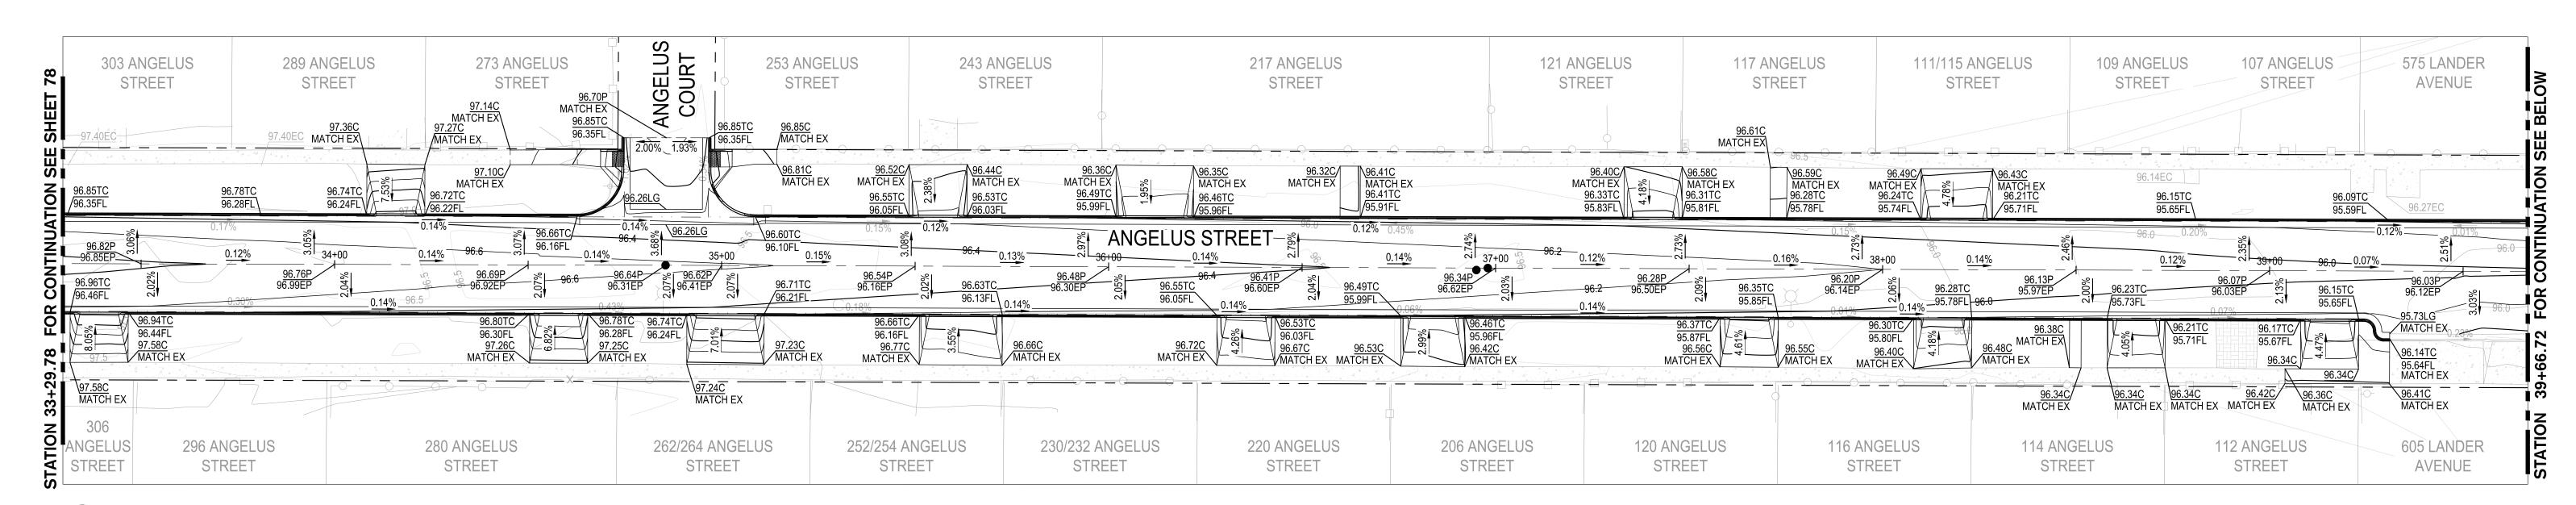

1 ANGELUS STREET STA: 33+29.78 TO 39+66.72

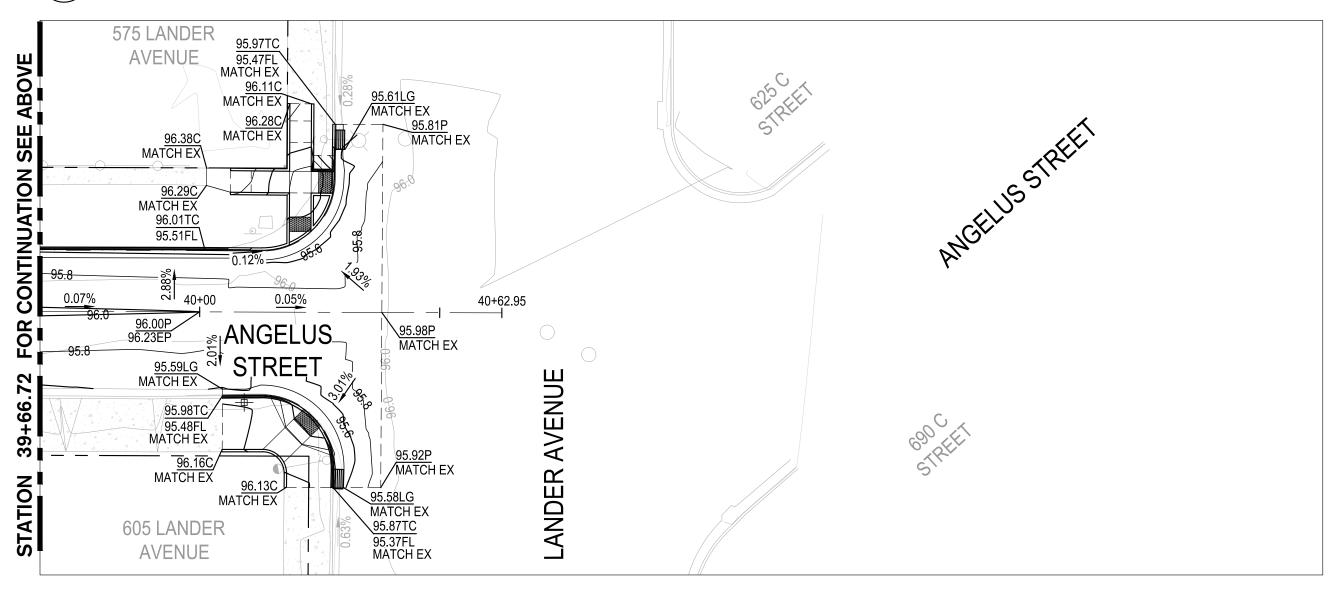

ANGELUS STREET STA: 39+66.72 TO END

SCALE: 1" = 20


GRADING LEGEND	
ABBREVIATION	DESCRIPTION
BW	BACK OF WALK
С	CONCRETE
EC	EXISTING CONCRETE
EFL	EXISTING FLOWLINE
ELG	EXISTING LIP OF GUTTER
EG	EXISTING GROUND
EL	ELEVATION
EP	EXISTING PAVEMENT
EX.	EXISTING
FG	FINISH GROUND
FL	FLOWLINE
G	GROUND
GB	GRADE BREAK
HP	HIGH POINT
LP	LOW POINT
MAX	MAXIMUM
MIN	MINIMUM
Р	PAVEMENT
TC	TOP OF CURB
TOW	TOP OF WALL
TYP	TYPICAL

LEGEND

% GRADE SLOPE PERCENTAGE


---- GRADE BREAK / RIDGE

EXISTING GRADE SLOPE PERCENTAGE

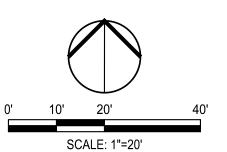


Know what's below.
Call before you dig.

NOTE:
ALL REFERENCES AND WRITTEN
DIMENSIONS SHALL SUPERCEDE
ALL SCALED DISTANCES AND
SHALL BE VERIFIED IN THE
FIELD. ANY DISCREPANCY
SHALL BE BROUGHT TO THE
ATTENTION OF THE ENGINEER
PRIOR TO THE COMMENCEMENT
OF WORK

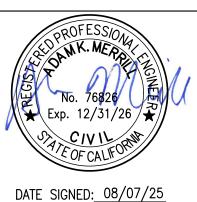




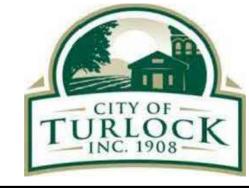

CITY OF TURLOCK
MUNICIPAL SERVICES DEPARTMENT
156 S. BROADWAY,
SUITE 150
(209) 668-5520

GRADING PLAN - ANGELUS STREET IV
PROJECT NO. 23-069


VERIFY SCALE	DRAWN BY: JR	DRAWING N
0 1"	REV. BY: AKM	
	CH. BY: AKM	79
	DATE: 8/7/2025	
	SCALE: SEE SHEET	SHEET:
	SEI PROJ NO: 22157	79 OF 1

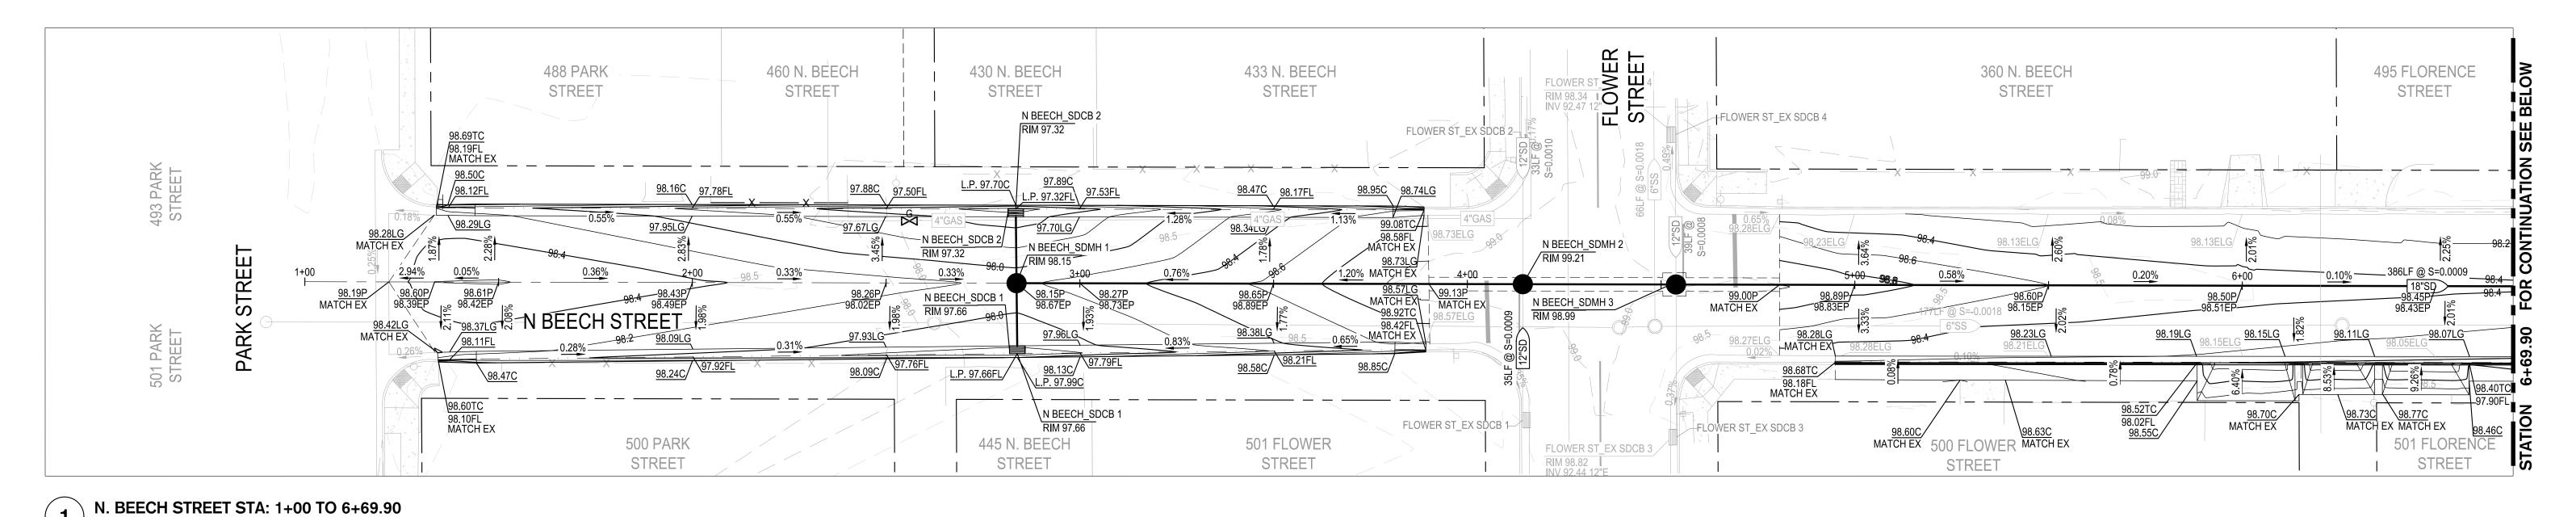

W OLIVE STREET FLORENCE STREET 495 FLORENCE 489 WEST OLIVE APN 061015032 494 FLORENCE STREET **AVENUE** STREET WEST OLIVE STREET OLIVE AVE_SDCB 3 N BEECH STREET <u>98.54C</u> <u>98.62C</u> MATCH EX MATCH EX 98.41C FLORENCE_SDCB 1 FLORENCE_SDCB 2 98.63C FLORENCE_SDCB 2 MATCH EX RIM 97.63 FLORENCE_SDCB 1 RIM 97.65 98.60 OLIVE AVE_SDCB 2 MATCRIM 97.99 7 500 WEST OLIVE OLIVE AVE_SDCB 136 RIM 97.96 MATCH EX 500 FLORENCE 501 WEST OLIVE 151 N. BEECH AVENUE STREET STREET STREET **AVENUE** 98.65C MATCH EX FLORENCE STREET SEE SHEET 71 SEE SHEET 74 N. BEECH STREET STA: 6+69.90 TO 13+06.84


GRADING LEGEND	
ABBREVIATION	DESCRIPTION
BW	BACK OF WALK
С	CONCRETE
EC	EXISTING CONCRETE
EFL	EXISTING FLOWLINE
ELG	EXISTING LIP OF GUTTER
EG	EXISTING GROUND
EL	ELEVATION
EP	EXISTING PAVEMENT
EX.	EXISTING
FG	FINISH GROUND
FL	FLOWLINE
G	GROUND
GB	GRADE BREAK
HP	HIGH POINT
LP	LOW POINT
MAX	MAXIMUM
MIN	MINIMUM
Р	PAVEMENT
TC	TOP OF CURB
TOW	TOP OF WALL

TYPICAL

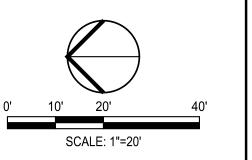




NOTE:
ALL REFERENCES AND WRITTEN
DIMENSIONS SHALL SUPERCEDE
ALL SCALED DISTANCES AND
SHALL BE VERIFIED IN THE
FIELD. ANY DISCREPANCY
SHALL BE BROUGHT TO THE
ATTENTION OF THE ENGINEER
PRIOR TO THE COMMENCEMENT
OF WORK

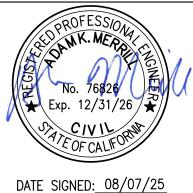




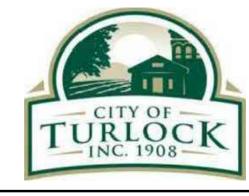

CITY OF TURLOCK
MUNICIPAL SERVICES DEPARTMENT
156 S. BROADWAY,
SUITE 150
(209) 668-5520

GRADING PLAN - N BEECH STREET I
PROJECT NO. 23-069

ERIFY SCALE	DRAWN BY: JR	DRAWING NO
1 "	REV. BY: AKM	
	CH. BY: AKM	80
	DATE: 8/7/2025	
	SCALE: SEE SHEET	SHEET:
	SEI PROJ NO: 22157	80 OF 11

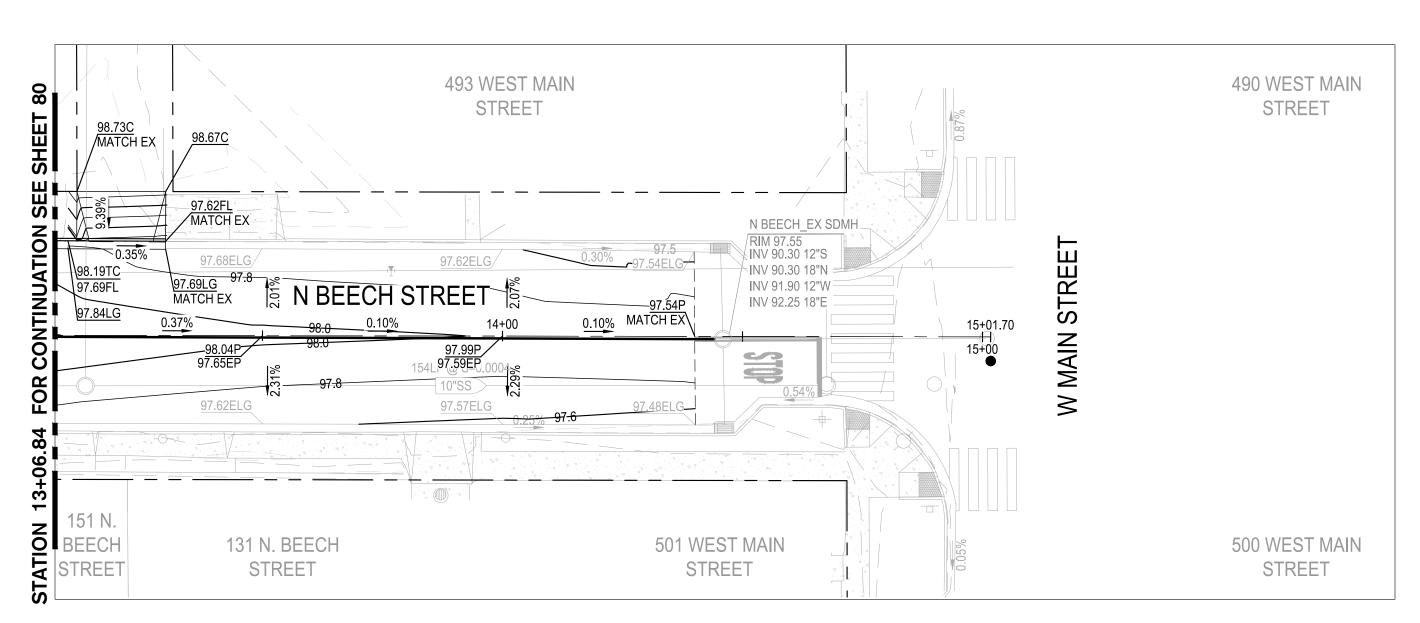

N. BEECH STREET STA: 13+06.84 TO END


GRADING LEGEND

DESCRIPTION ABBREVIATION BACK OF WALK CONCRETE EXISTING CONCRETE EXISTING FLOWLINE EXISTING LIP OF GUTTER EXISTING GROUND ELEVATION EXISTING PAVEMENT **EXISTING** FINISH GROUND FLOWLINE GROUND GRADE BREAK HIGH POINT LOW POINT MAXIMUM MINIMUM PAVEMENT TOP OF CURB TOP OF WALL TYPICAL

LEGEND


GRADE SLOPE PERCENTAGE EXISTING GRADE SLOPE PERCENTAGE


---- GRADE BREAK / RIDGE

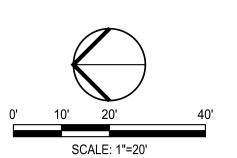


Know what's **below. Call** before you dig.

ALL REFERENCES AND WRITTEN DIMENSIONS SHALL SUPERCEDE ALL SCALED DISTANCES AND SHALL BE VERIFIED IN THE FIELD. ANY DISCREPANCY SHALL BE BROUGHT TO THE ATTENTION OF THE ENGINEER PRIOR TO THE COMMENCEMENT OF WORK

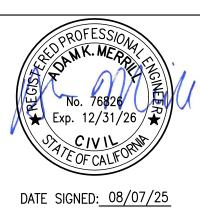

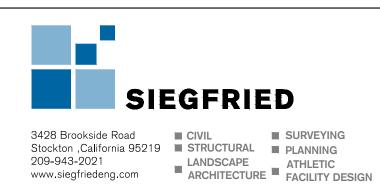

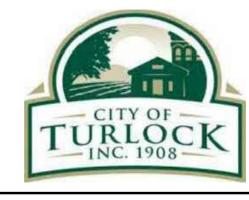


CITY OF TURLOCK MUNICIPAL SERVICES DEPARTMENT 156 S. BROADWAY, SUITE 150 (209) 668-5520

GRADING PLAN - N BEECH STREET II PROJECT NO. 23-069


CITY OF TURLOCK ROADS PROGRAM

Q_	

DRAWING NO. VERIFY SCALE DRAWN BY: JR REV. BY: AKM CH. BY: AKM DATE: 8/7/2025 SCALE: SEE SHEET SHEET: SEI PROJ NO: 22157 81 OF 117

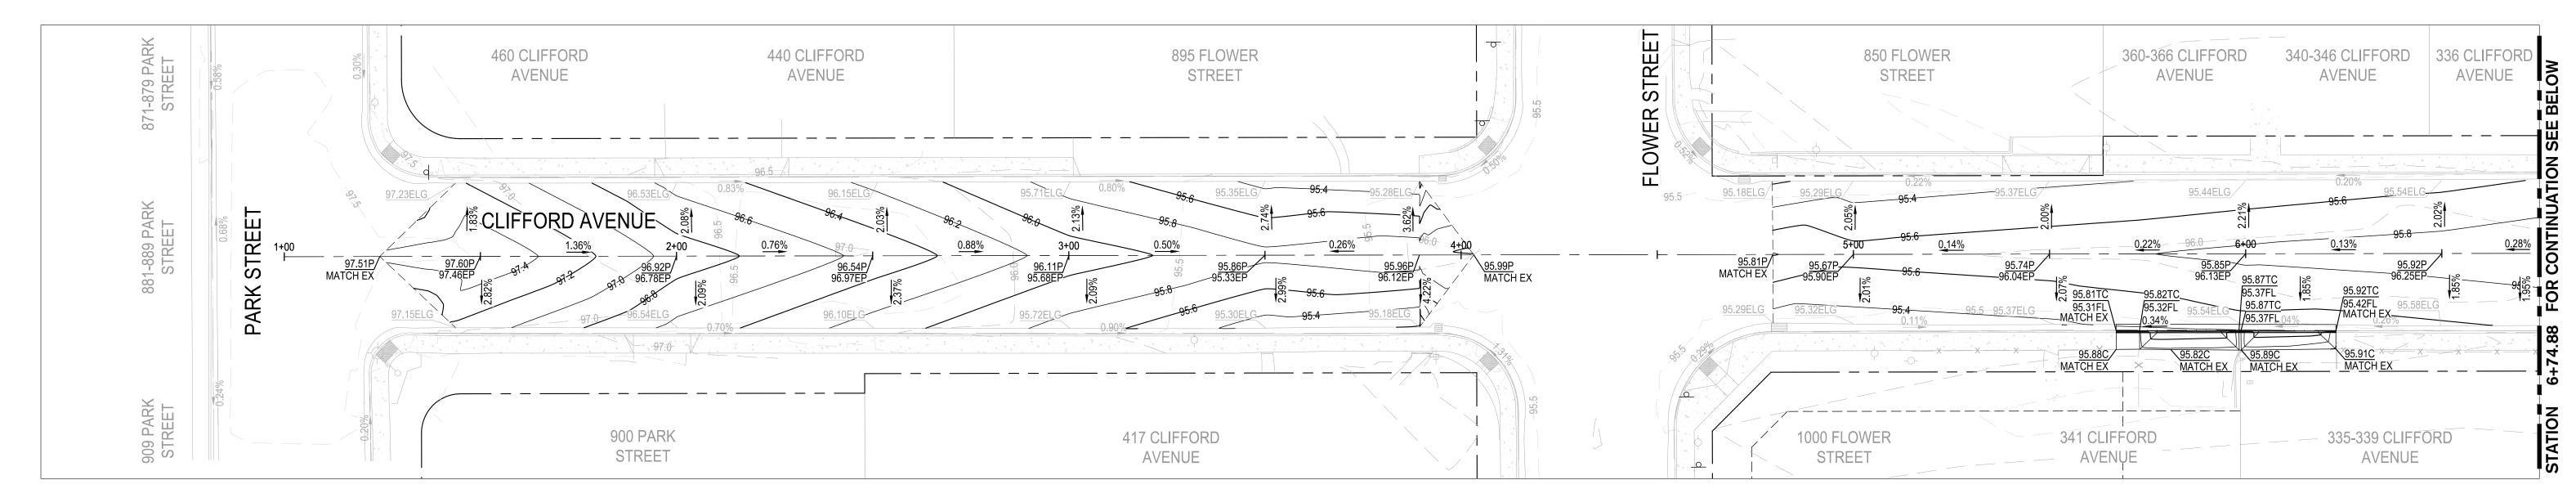

1 CLIFFORD AVENUE STA: 1+00 TO 6+74.88

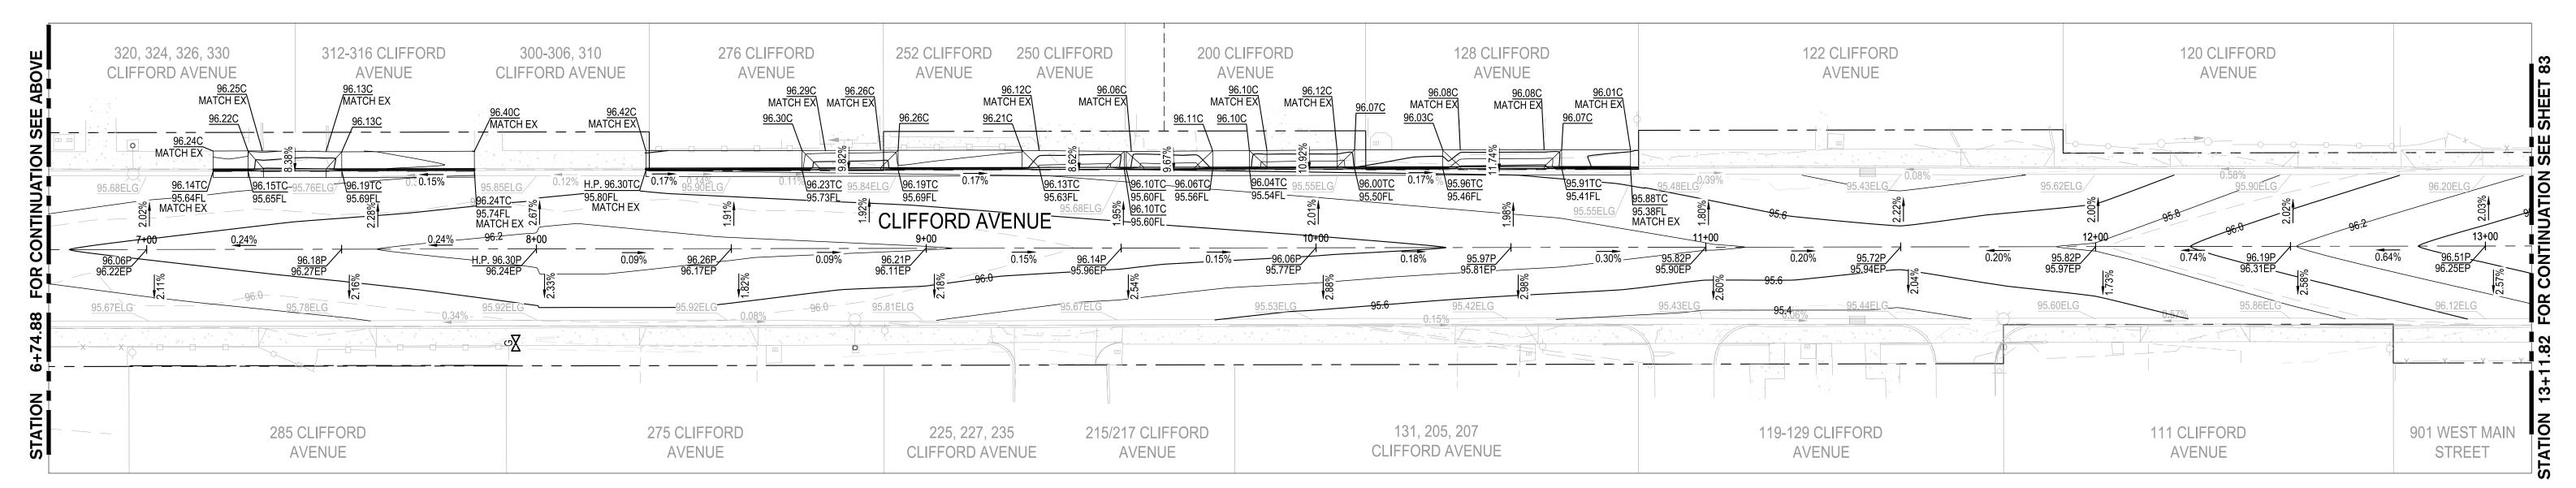

2 CLIFFORD AVENUE STA: 6+74.88 TO 13+11.82


GRADING LEGEND		
ABBREVIATION	DESCRIPTION	
BW	BACK OF WALK	
С	CONCRETE	
EC	EXISTING CONCRETE	
EFL	EXISTING FLOWLINE	
ELG	EXISTING LIP OF GUTTER	
EG	EXISTING GROUND	
EL	ELEVATION	
EP	EXISTING PAVEMENT	
EX.	EXISTING	
FG	FINISH GROUND	
FL	FLOWLINE	
G	GROUND	
GB	GRADE BREAK	
HP	HIGH POINT	
LP	LOW POINT	
MAX	MAXIMUM	
MIN	MINIMUM	
Р	PAVEMENT	
TC	TOP OF CURB	
TOW	TOP OF WALL	
TYP	TYPICAL	

LEGEND

GRADE SLOPE PERCENTAGE


EXISTING GRADE SLOPE PERCENTAGE

---- GRADE BREAK / RIDGE

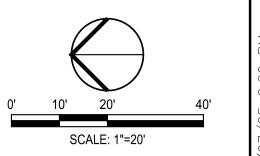




NOTE:
ALL REFERENCES AND WRITTEN
DIMENSIONS SHALL SUPERCEDE
ALL SCALED DISTANCES AND
SHALL BE VERIFIED IN THE
FIELD. ANY DISCREPANCY
SHALL BE BROUGHT TO THE
ATTENTION OF THE ENGINEER
PRIOR TO THE COMMENCEMENT
OF WORK

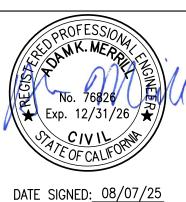




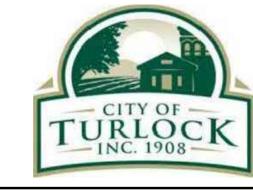

CITY OF TURLOCK
MUNICIPAL SERVICES DEPARTMENT
156 S. BROADWAY,
SUITE 150
(209) 668-5520

GRADING PLAN - CLIFFORD AVENUE I

DRAWING N	DRAWN BY: JR	VERIFY SCALE	
	REV. BY: AKM	0 1"	
82	CH. BY: AKM		
	DATE: 8/7/2025		
] SHEET:	SCALE: SEE SHEET		
82 OF 1	SEI PROJ NO: 22157		

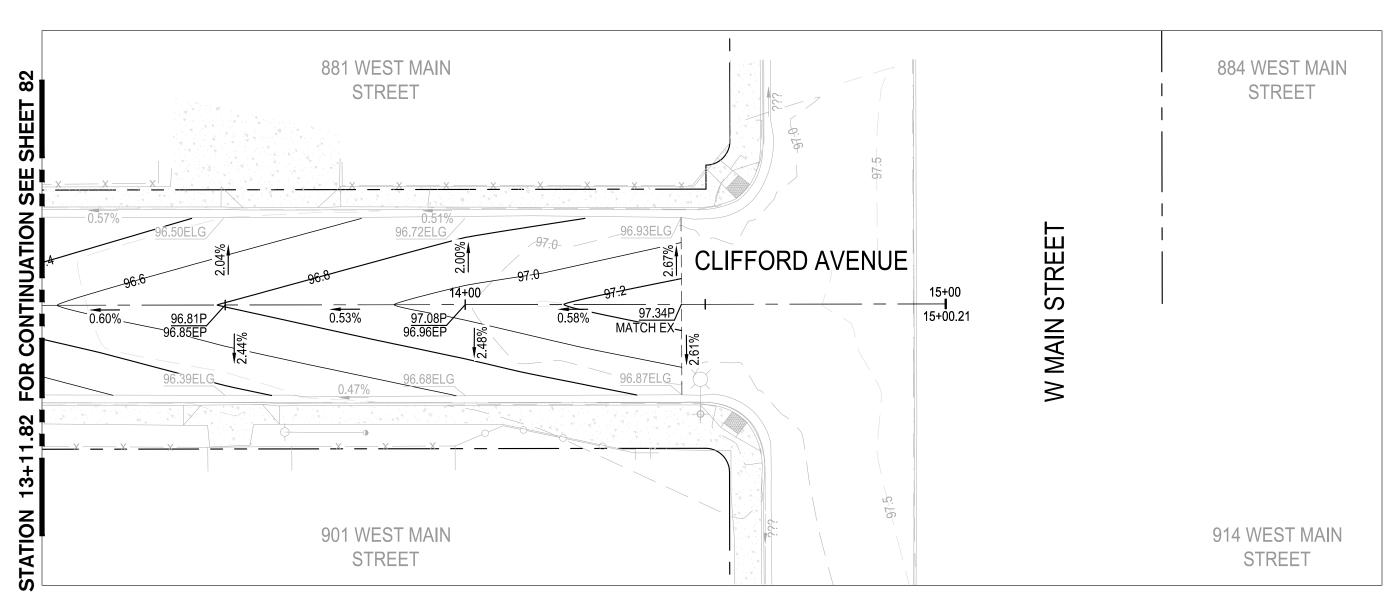

CLIFFORD AVENUE STA: 13+11.82 TO END


GRADING LEGEND

ABBREVIATION DESCRIPTION BACK OF WALK CONCRETE EXISTING CONCRETE EXISTING FLOWLINE EXISTING LIP OF GUTTER EXISTING GROUND ELEVATION EXISTING PAVEMENT EXISTING FINISH GROUND FLOWLINE GROUND GRADE BREAK HIGH POINT LOW POINT MAXIMUM MINIMUM PAVEMENT TOP OF CURB TOP OF WALL TYPICAL

LEGEND


GRADE SLOPE PERCENTAGE

EXISTING GRADE SLOPE PERCENTAGE

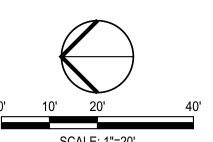



NOTE:
ALL REFERENCES AND WRITTEN
DIMENSIONS SHALL SUPERCEDE
ALL SCALED DISTANCES AND
SHALL BE VERIFIED IN THE
FIELD. ANY DISCREPANCY
SHALL BE BROUGHT TO THE
ATTENTION OF THE ENGINEER
PRIOR TO THE COMMENCEMENT
OF WORK

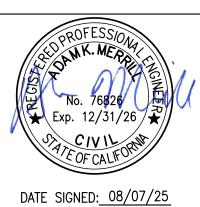





CITY OF TURLOCK
MUNICIPAL SERVICES DEPARTMENT
156 S. BROADWAY,
SUITE 150
(209) 668-5520

GRADING PLAN - CLIFFORD AVENUE II


PROJECT NO. 23-069
CITY OF TURLOCK ROADS PROGRAM

ERIFY SCALE	DRAWN BY: JR	drawing no.
1"	REV. BY: AKM	
	CH. BY: AKM	83
	DATE: 8/7/2025	
	SCALE: SEE SHEET	SHEET:
	SEI PROJ NO: 22157	83 OF 117

10' 20' 40'

SCALE: 1"=20'

JR DRAWING NO.

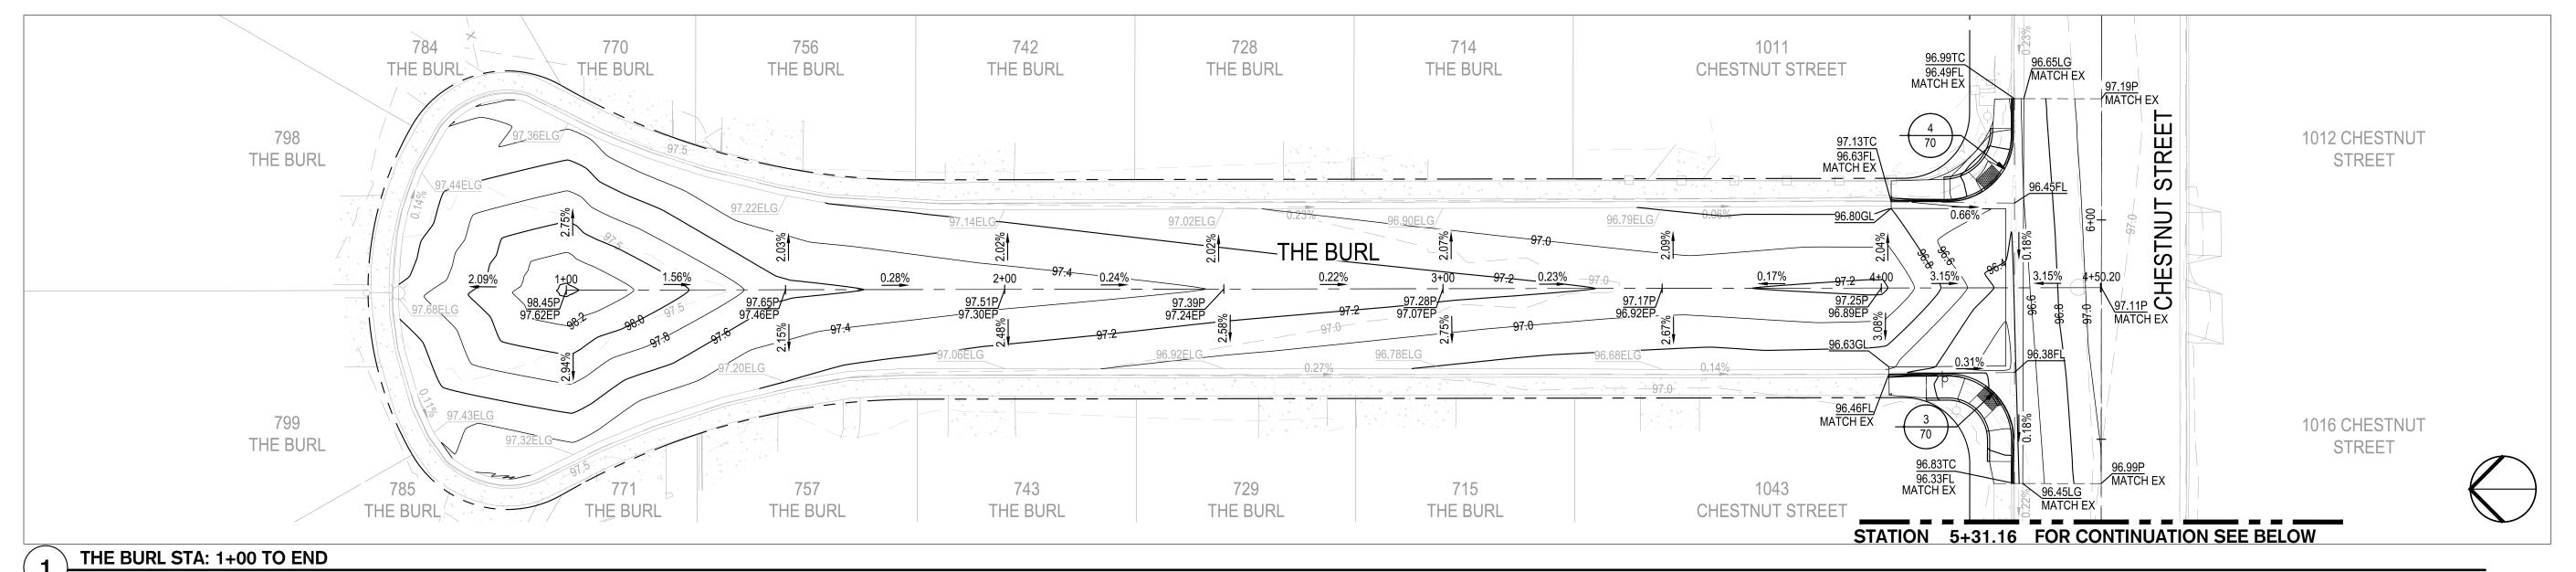


1043 CHESTNUT 1063 CHESTNUT 1083 CHESTNUT 1127 CHESTNUT STREET 1125 CHESTNUT 1129 CHESTNUT 700 SODERQUIST STREET STREET STREET STREET STREET ROAD CHESTNUT STREET 1060 CHESTNUT 1098 CHESTNUT 1088 CHESTNUT 1116 CHESTNUT 674 SODERQUIST STREET STREET STREET STREET ROAD

CHESTNUT STREET STA: 1+00 TO 5+31.16

SCALE: 1" = 20'


GRADING LEGEND	
ABBREVIATION	DESCRIPTION
BW	BACK OF WALK
С	CONCRETE
EC	EXISTING CONCRETE
EFL	EXISTING FLOWLINE
ELG	EXISTING LIP OF GUTTER
EG	EXISTING GROUND
EL	ELEVATION
EP	EXISTING PAVEMENT
EX.	EXISTING
FG	FINISH GROUND
FL	FLOWLINE
G	GROUND
GB	GRADE BREAK
HP	HIGH POINT
LP	LOW POINT
MAX	MAXIMUM
MIN	MINIMUM
Р	PAVEMENT
TC	TOP OF CURB
TOW	TOP OF WALL
TYP	TYPICAL

LEGEND	
<u>%</u>	GRADE SLOPE PERCENTAGE
	EXISTING GRADE SLOPE PERCENTAGE
	GRADE BREAK / RIDGE

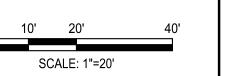




ALL REFERENCES AND WRITTEN DIMENSIONS SHALL SUPERCEDE ALL SCALED DISTANCES AND SHALL BE VERIFIED IN THE FIELD. ANY DISCREPANCY SHALL BE BROUGHT TO THE ATTENTION OF THE ENGINEER PRIOR TO THE COMMENCEMENT OF WORK

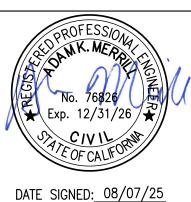




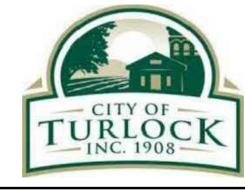


CITY OF TURLOCK MUNICIPAL SERVICES DEPARTMENT 156 S. BROADWAY, SUITE 150 (209) 668-5520

PROJECT NO. 23-069
11100E01110.20-003
CITY OF TURLOCK ROADS PROGRAM

DRAWN BY: JR	DRAWING NO.
REV. BY: AKM	
CH. BY: AKM	84
DATE: 8/7/2025	
SCALE: SEE SHEET	SHFFT:
SEI PROJ NO: 22157	84 OF 117
	REV. BY: AKM CH. BY: AKM DATE: 8/7/2025 SCALE: SEE SHEET

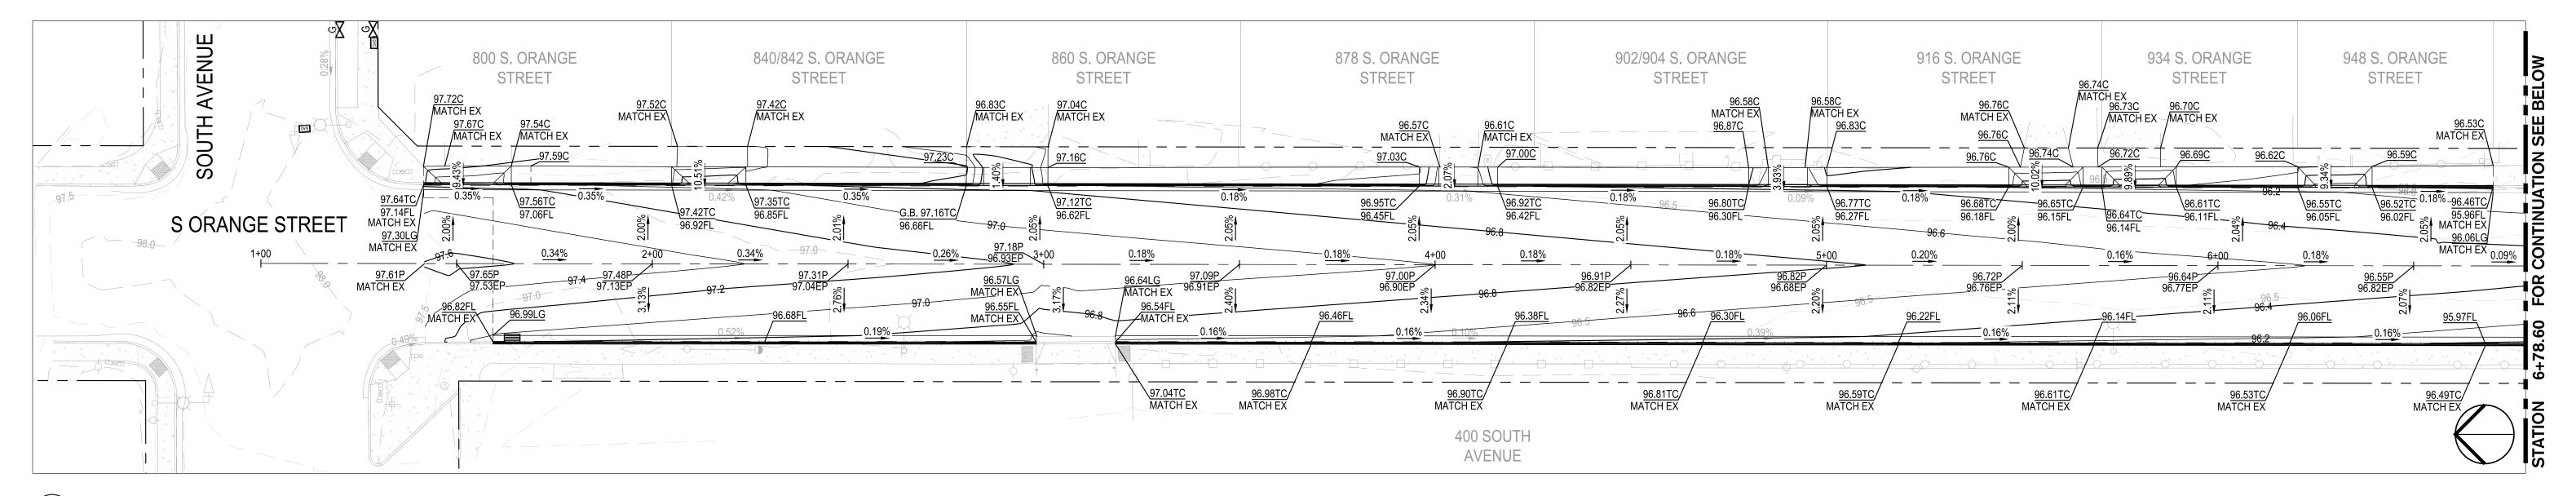

S. ORANGE STREET STA: 1+00 TO 6+78.60

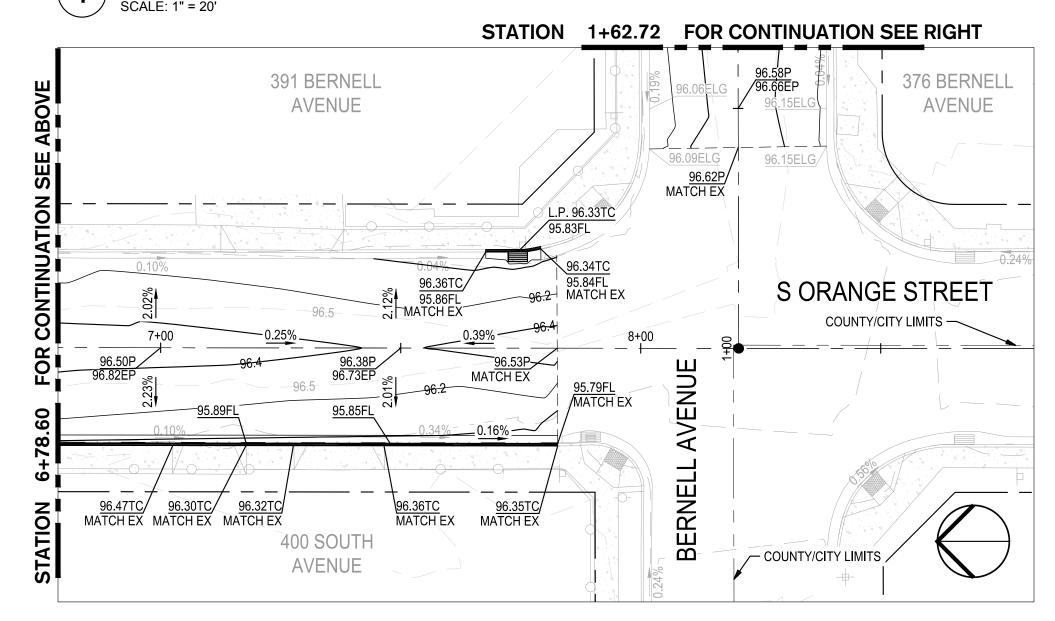

313 BERNELL 391 BERNELL 361 BERNELL 351 BERNELL **AVENUE AVENUE AVENUE AVENUE** BERNELL AVENUE 376 BERNELL 354 BERNELL 332/334 BERNELL 1001, 1003, 1003, 1035 **AVENUE AVENUE AVENUE** BETHANY AVENUE

2 S. ORANGE STA: 6+78.60 TO 8+81.94

SCALE: 1" = 20'

BERNELL AVENUE STA: 1+62.72 TO END

SCALE: 1" = 20'


GRADING LEGEND	
ABBREVIATION	DESCRIPTION
BW	BACK OF WALK
С	CONCRETE
EC	EXISTING CONCRETE
EFL	EXISTING FLOWLINE
ELG	EXISTING LIP OF GUTTER
EG	EXISTING GROUND
EL	ELEVATION
EP	EXISTING PAVEMENT
EX.	EXISTING
FG	FINISH GROUND
FL	FLOWLINE
G	GROUND
GB	GRADE BREAK
HP	HIGH POINT
LP	LOW POINT
MAX	MAXIMUM
MIN	MINIMUM
Р	PAVEMENT
TC	TOP OF CURB
TOW	TOP OF WALL
TYP	TYPICAL

GRADE SLOPE PERCENTAGE

**


EXISTING GRADE SLOPE PERCENTAGE

LEGEND

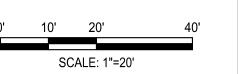



NOTE:
ALL REFERENCES AND WRITTEN
DIMENSIONS SHALL SUPERCEDE
ALL SCALED DISTANCES AND
SHALL BE VERIFIED IN THE
FIELD. ANY DISCREPANCY
SHALL BE BROUGHT TO THE
ATTENTION OF THE ENGINEER
PRIOR TO THE COMMENCEMENT
OF WORK

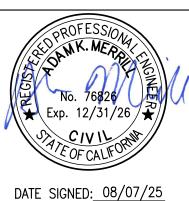






CITY OF TURLOCK MUNICIPAL SERVICES DEPARTMENT 156 S. BROADWAY, SUITE 150 (209) 668-5520 GRADING PLAN - S ORANGE STREET &

BERNELL AVENUE


PROJECT NO. 23-069

CITY OF TURLOCK ROADS PROGRAM

ERIFY SCALE	DRAWN BY: JR	DRAWING NO.
0 1"	REV. BY: AKM	
	CH. BY: AKM	85
	DATE: 8/7/2025	
	SCALE: SEE SHEET	SHEET:
	SEI PROJ NO: 22157	85 OF 117

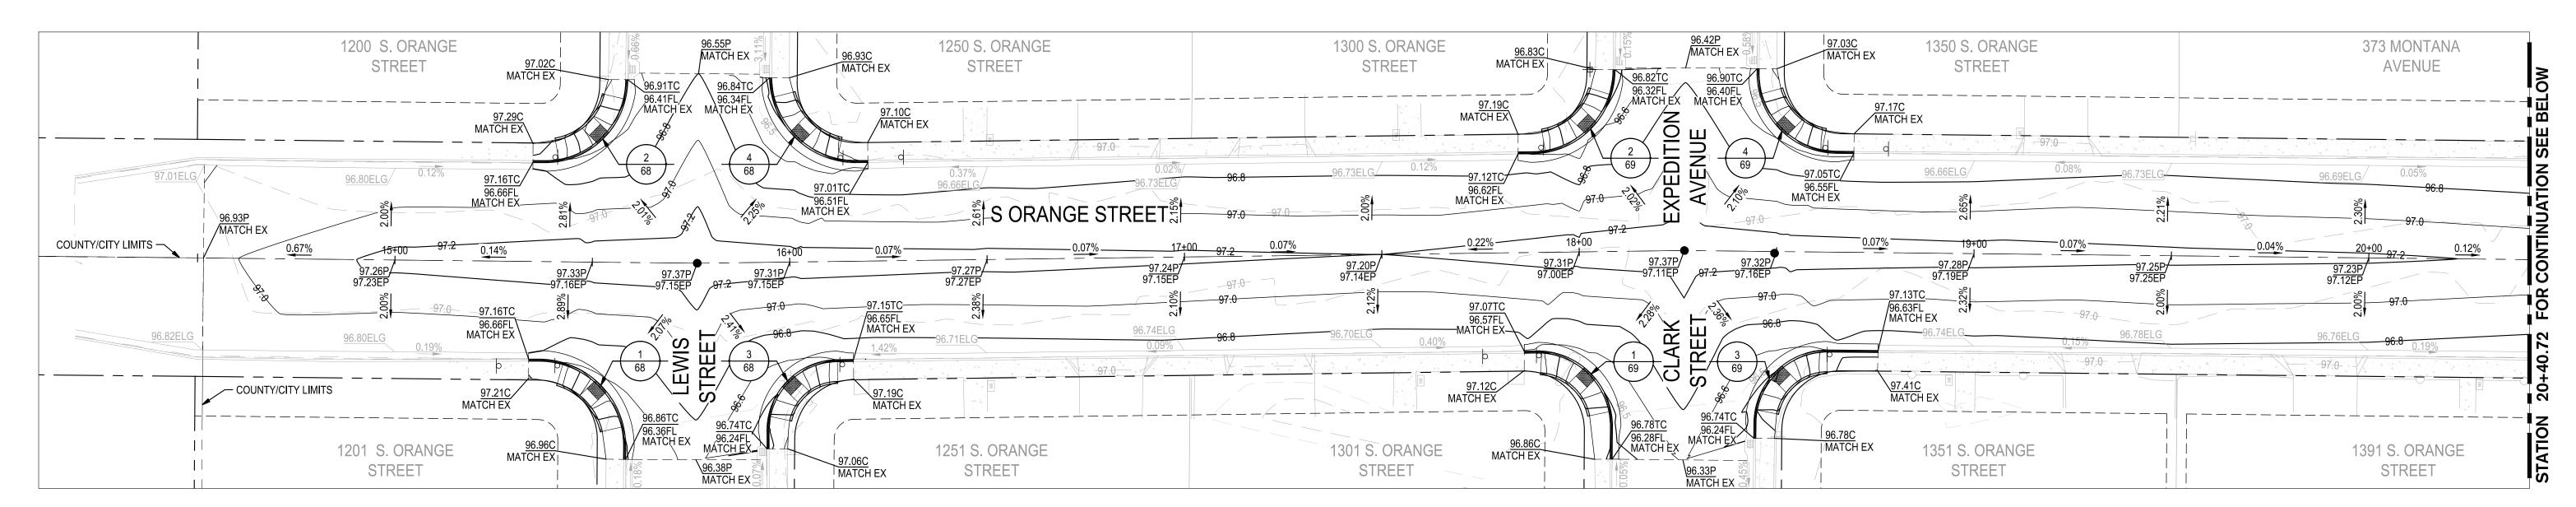

S. ORANGE STREET STA: 14+51.50 TO 20+40.72

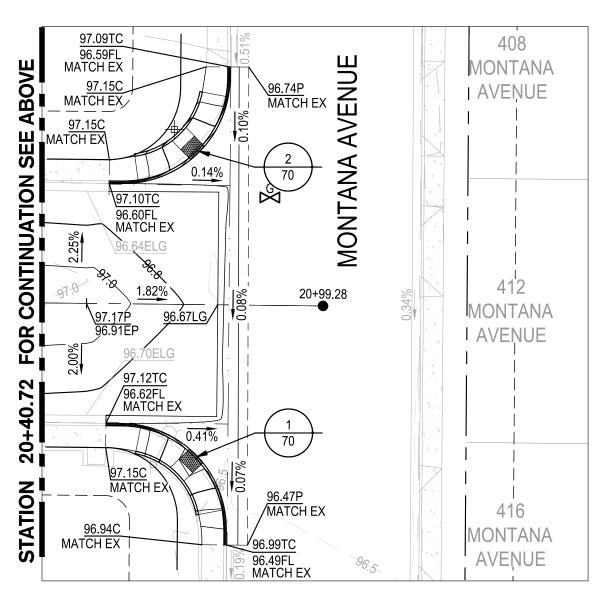


2 S. ORANGE STA: 20+40.72 TO END

SCALE: 1" = 20'


RADING LEGEND			
BBREVIATION	DESCRIPTION		
BW	BACK OF WALK		
С	CONCRETE		
EC	EXISTING CONCRETE		
EFL	EXISTING FLOWLINE		
ELG	EXISTING LIP OF GUTTER		
EG	EXISTING GROUND		
EL	ELEVATION		
EP	EXISTING PAVEMENT		
EX.	EXISTING		
FG	FINISH GROUND		
FL	FLOWLINE		
G	GROUND		
GB	GRADE BREAK		
HP	HIGH POINT		
LP	LOW POINT		
MAX	MAXIMUM		
MIN	MINIMUM		
Р	PAVEMENT		
TC	TOP OF CURB		
TOW	TOP OF WALL		
TYP	TYPICAL		

<u>EGEND</u>	
<u>%</u>	GRADE SLOPE PERCENTAGE
<u></u> %	EXISTING GRADE SLOPE PERCENTAGE
	GRADE BREAK / RIDGE

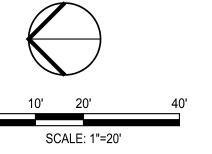




NOTE:
ALL REFERENCES AND WRITTEN
DIMENSIONS SHALL SUPERCEDE
ALL SCALED DISTANCES AND
SHALL BE VERIFIED IN THE
FIELD. ANY DISCREPANCY
SHALL BE BROUGHT TO THE
ATTENTION OF THE ENGINEER
PRIOR TO THE COMMENCEMENT
OF WORK

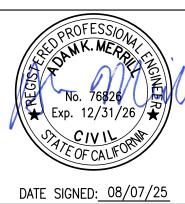




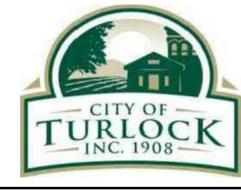


CITY OF TURLOCK MUNICIPAL SERVICES DEPARTMENT 156 S. BROADWAY, SUITE 150 (209) 668-5520


GRADING PLAN - S ORANGE STREET II
PROJECT NO. 23-069

DRAWN BY: JR	DRAWING NO
REV. BY: AKM	
CH. BY: AKM	86
DATE: 8/7/2025	
SCALE: SEE SHEET	SHEET:
SEI PROJ NO: 22157	86 OF 11
	REV. BY: AKM CH. BY: AKM DATE: 8/7/2025 SCALE: SEE SHEET

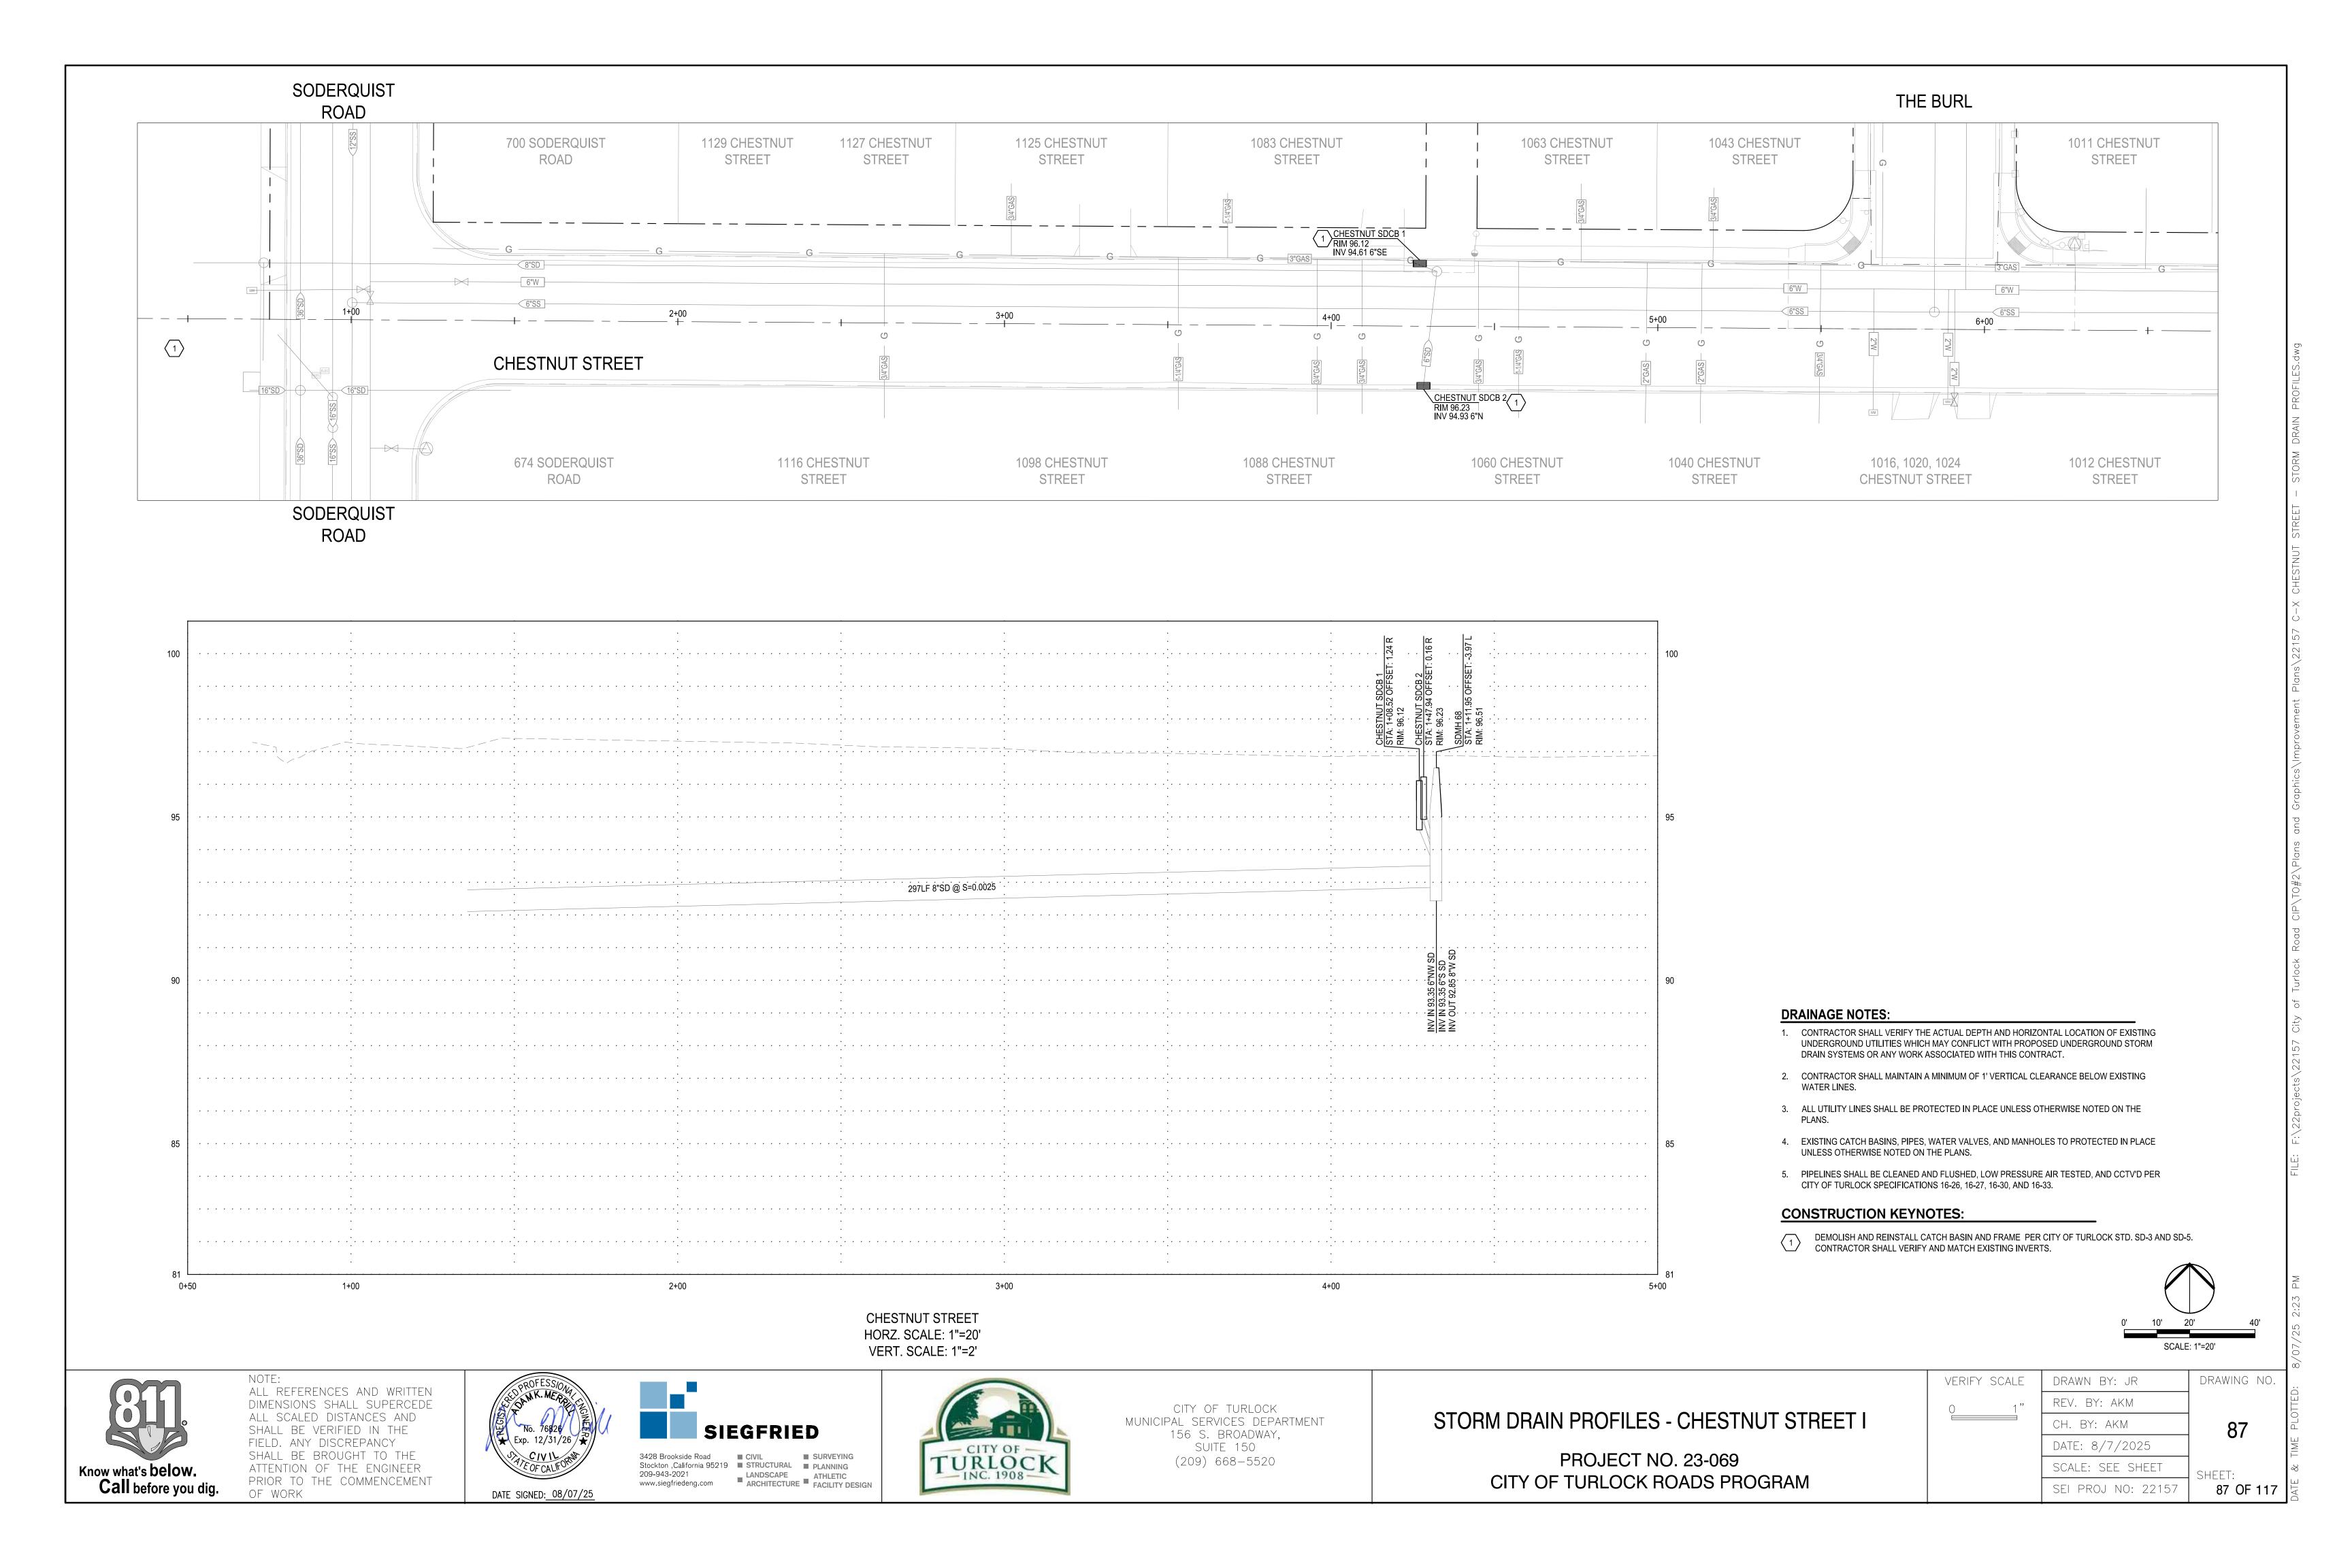

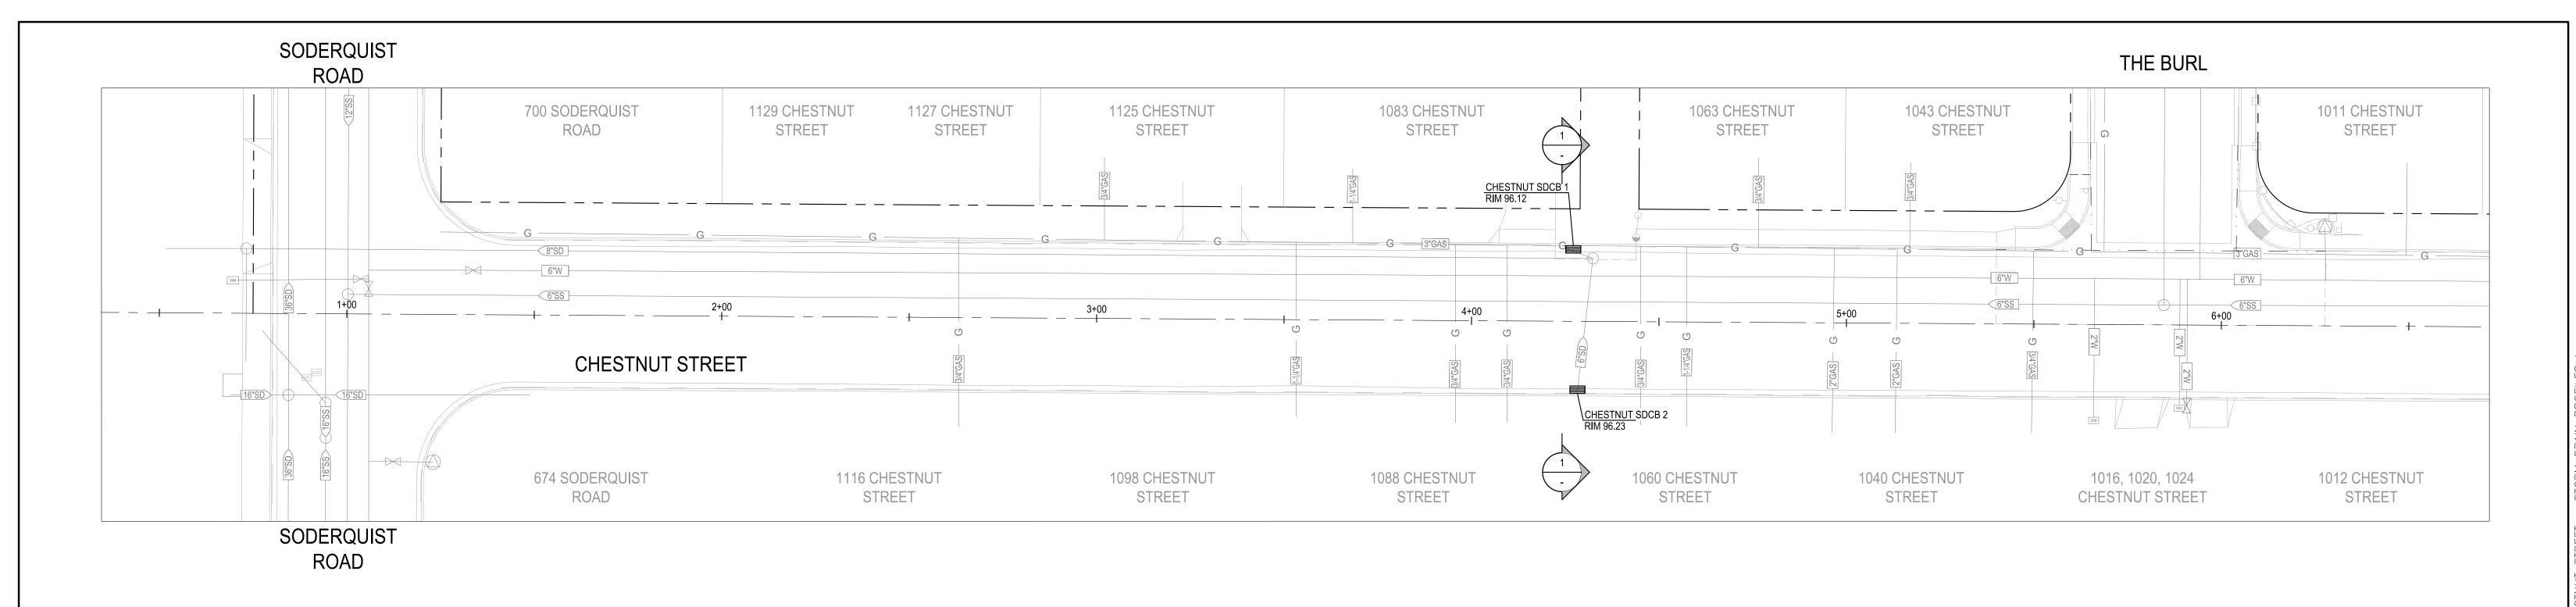


NOTE: DEPTH OF EXISTING UTILITIES ARE APPROXIMATE. CONTRACTOR SHALL VERIFY THE ACTUAL DEPTH AND HORIZONTAL LOCATION OF EXISTING UNDERGROUND UTILITIES WHICH MAY CONFLICT WITH PROPOSED UNDERGROUND STORM DRAIN SYSTEMS OR ANY WORK ASSOCIATED WITH THIS CONTRACT.

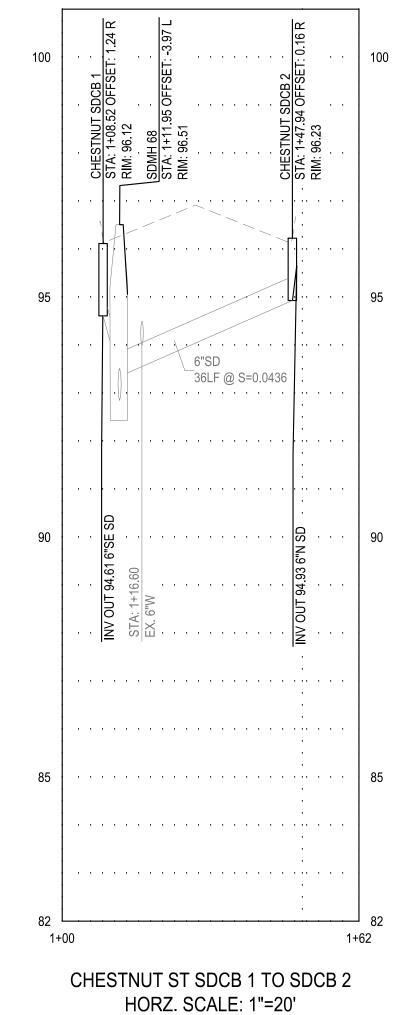

CHESTNUT ST SDCB 1 TO SDCB 2 CROSS SECTION


VERT. SCALE: 1"=2'

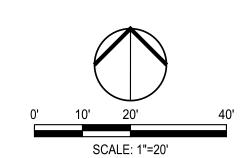


Know what's **below. Call** before you dig.

ALL REFERENCES AND WRITTEN DIMENSIONS SHALL SUPERCEDE ALL SCALED DISTANCES AND SHALL BE VERIFIED IN THE FIELD. ANY DISCREPANCY SHALL BE BROUGHT TO THE ATTENTION OF THE ENGINEER PRIOR TO THE COMMENCEMENT

OF WORK

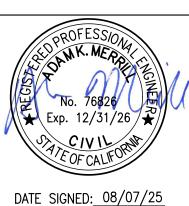



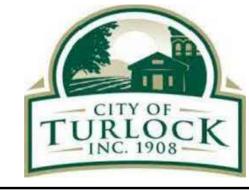



CITY OF TURLOCK MUNICIPAL SERVICES DEPARTMENT 156 S. BROADWAY, SUITE 150 (209) 668-5520

STORM DRAIN PROFILES - CHESTNUT STREET II

VERIFY SCALE	DRAWN BY: JR	DF
0 1"	REV. BY: AKM	
	CH. BY: AKM	
	DATE: 8/7/2025	
	SCALE: SEE SHEET] SH
	SEI PROJ NO: 22157	

PROJECT NO. 23-069 CITY OF TURLOCK ROADS PROGRAM DRAWING NO. HEET: 88 OF 117

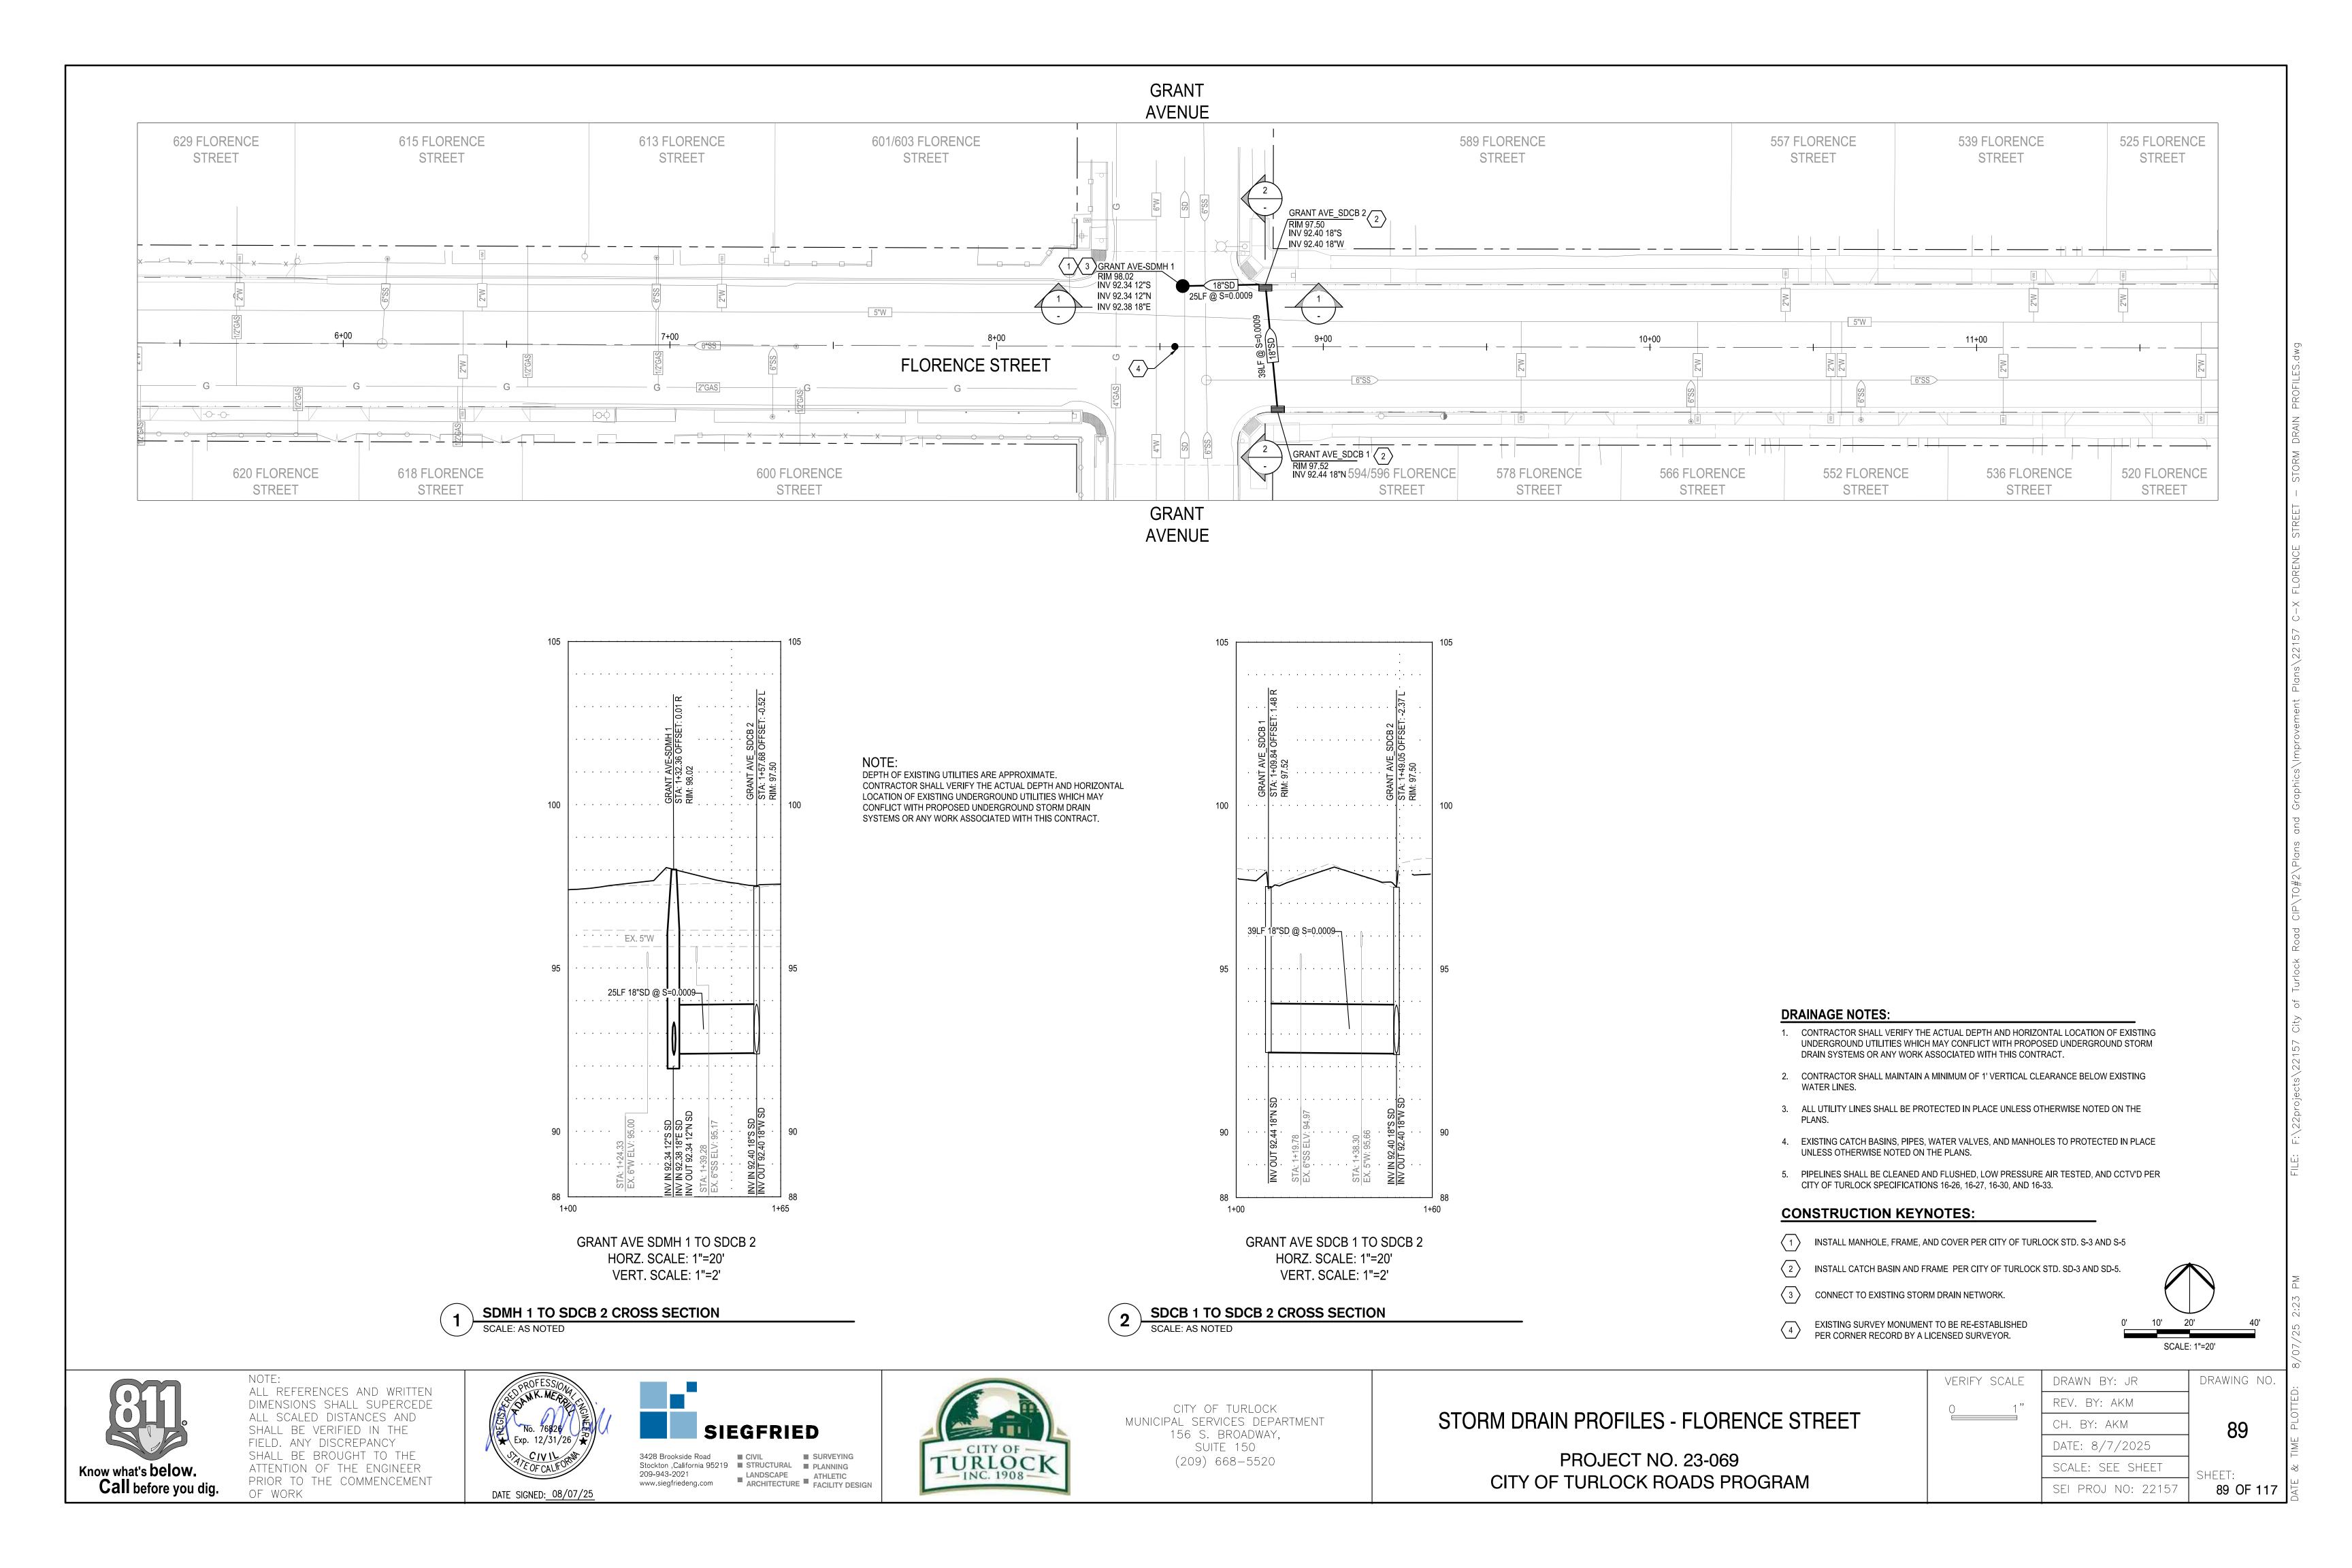

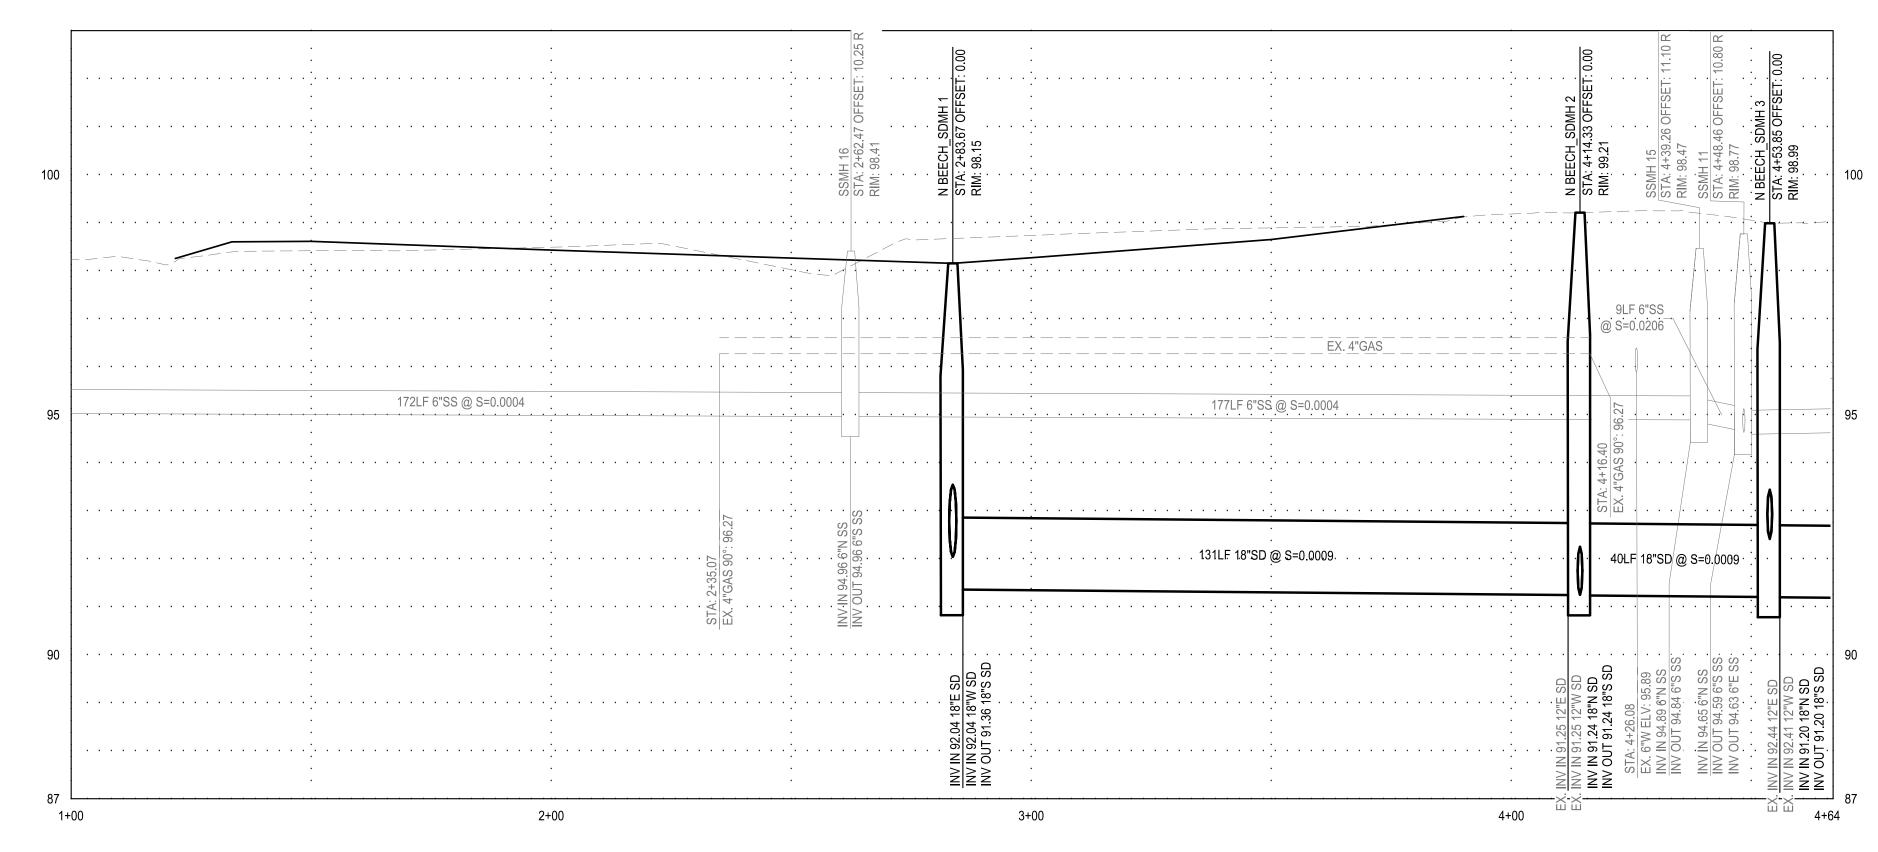


N BEECH ST HORZ. SCALE: 1"=20' VERT. SCALE: 1"=2'

DRAINAGE NOTES:

- 1. CONTRACTOR SHALL VERIFY THE ACTUAL DEPTH AND HORIZONTAL LOCATION OF EXISTING UNDERGROUND UTILITIES WHICH MAY CONFLICT WITH PROPOSED UNDERGROUND STORM DRAIN SYSTEMS OR ANY WORK ASSOCIATED WITH THIS CONTRACT.
- 2. CONTRACTOR SHALL MAINTAIN A MINIMUM OF 1' VERTICAL CLEARANCE BELOW EXISTING WATER LINES.
- 3. ALL UTILITY LINES SHALL BE PROTECTED IN PLACE UNLESS OTHERWISE NOTED ON THE PLANS.
- 4. EXISTING CATCH BASINS, PIPES, WATER VALVES, AND MANHOLES TO PROTECTED IN PLACE UNLESS OTHERWISE NOTED ON THE PLANS.
- 5. PIPELINES SHALL BE CLEANED AND FLUSHED, LOW PRESSURE AIR TESTED, AND CCTV'D PER CITY OF TURLOCK SPECIFICATIONS 16-26, 16-27, 16-30, AND 16-33.

CONSTRUCTION KEYNOTES:

- (1) INSTALL MANHOLE, FRAME, AND COVER PER CITY OF TURLOCK STD. S-3 AND S-5.
- INSTALL CATCH BASIN AND FRAME PER CITY OF TURLOCK STD. SD-3 AND SD-5.
- CONNECT EXISTING STORM DRAIN TO PROPOSED STORM MANHOLE. CONTRACTOR SHALL TRIM EXISTING STORM PIPE FLUSH INTO MANHOLE, GROUT, AND MAKER SURE NO LEAKS.

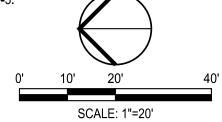



ALL REFERENCES AND WRITTEN DIMENSIONS SHALL SUPERCEDE ALL SCALED DISTANCES AND SHALL BE VERIFIED IN THE FIELD. ANY DISCREPANCY SHALL BE BROUGHT TO THE ATTENTION OF THE ENGINEER PRIOR TO THE COMMENCEMENT OF WORK









CITY OF TURLOCK MUNICIPAL SERVICES DEPARTMENT 156 S. BROADWAY, SUITE 150 (209) 668 - 5520

STORM DRAIN PROFILES - N BEECH STREET I


VERIFY SCALE	DRAWN BY: JR	DRAWING NO
0 1"	REV. BY: AKM	
	CH. BY: AKM	90
	DATE: 8/7/2025	
	SCALE: SEE SHEET	SHEET:
	SEI PROJ NO: 22157	90 OF 11

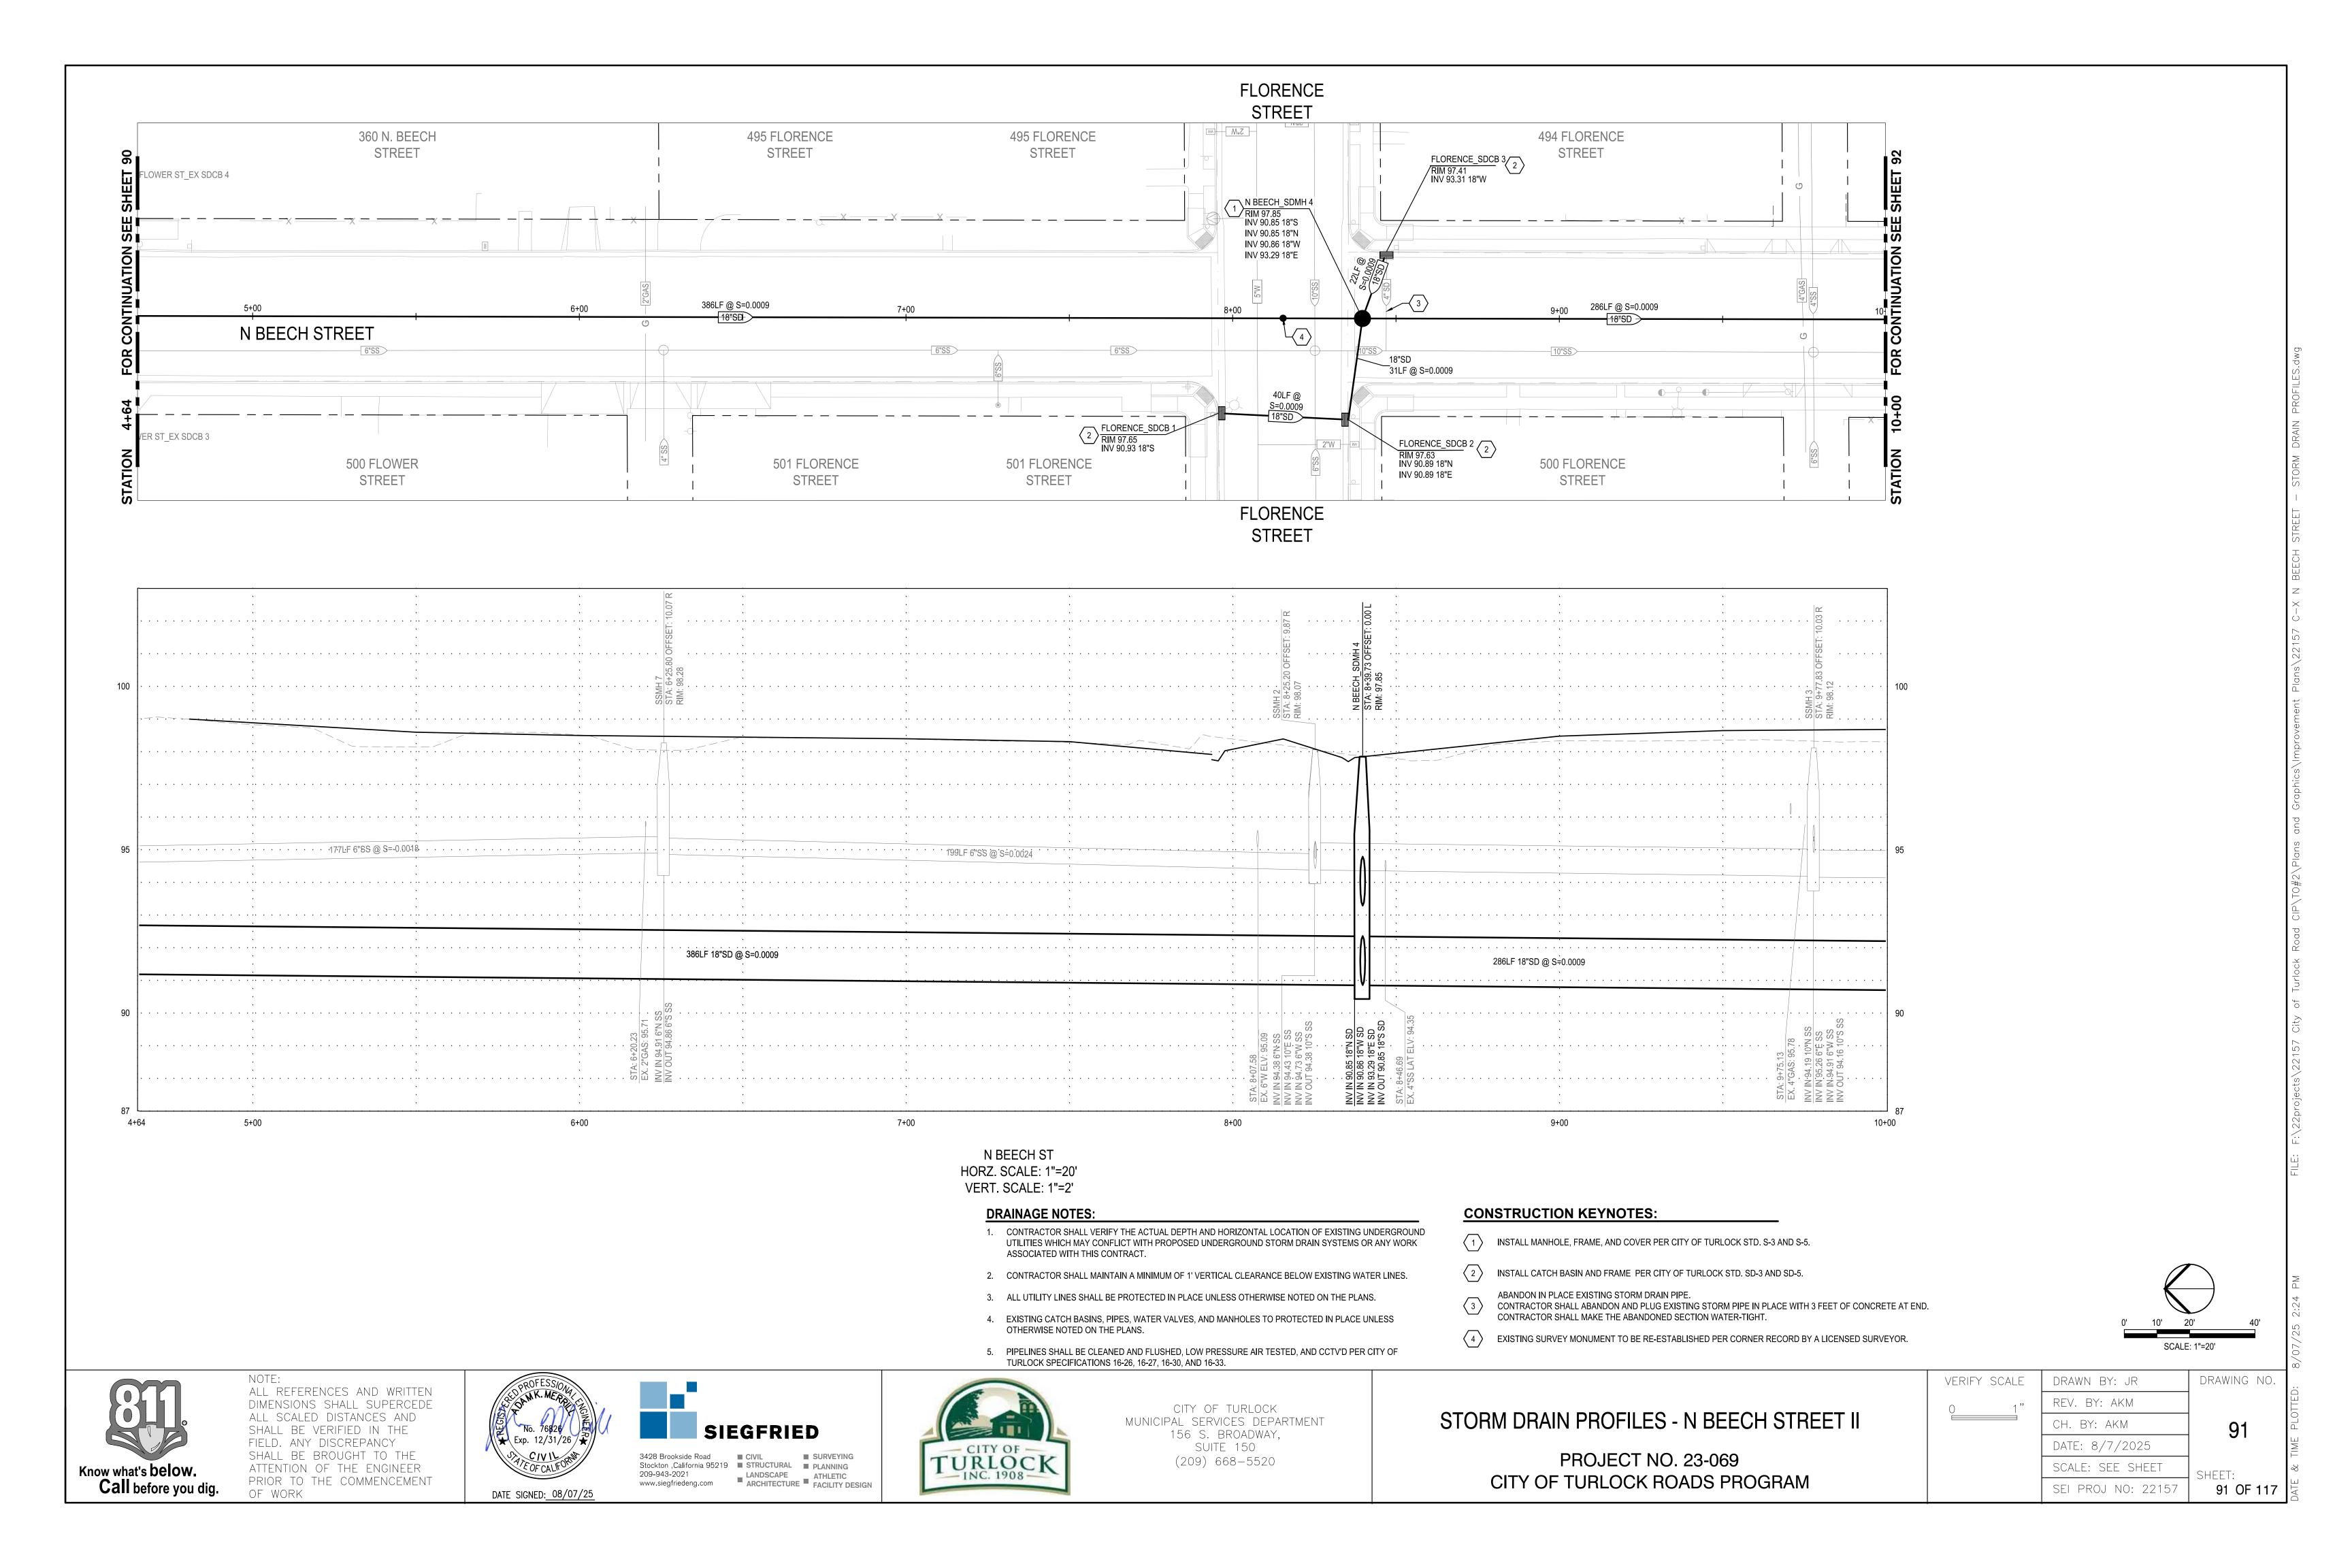

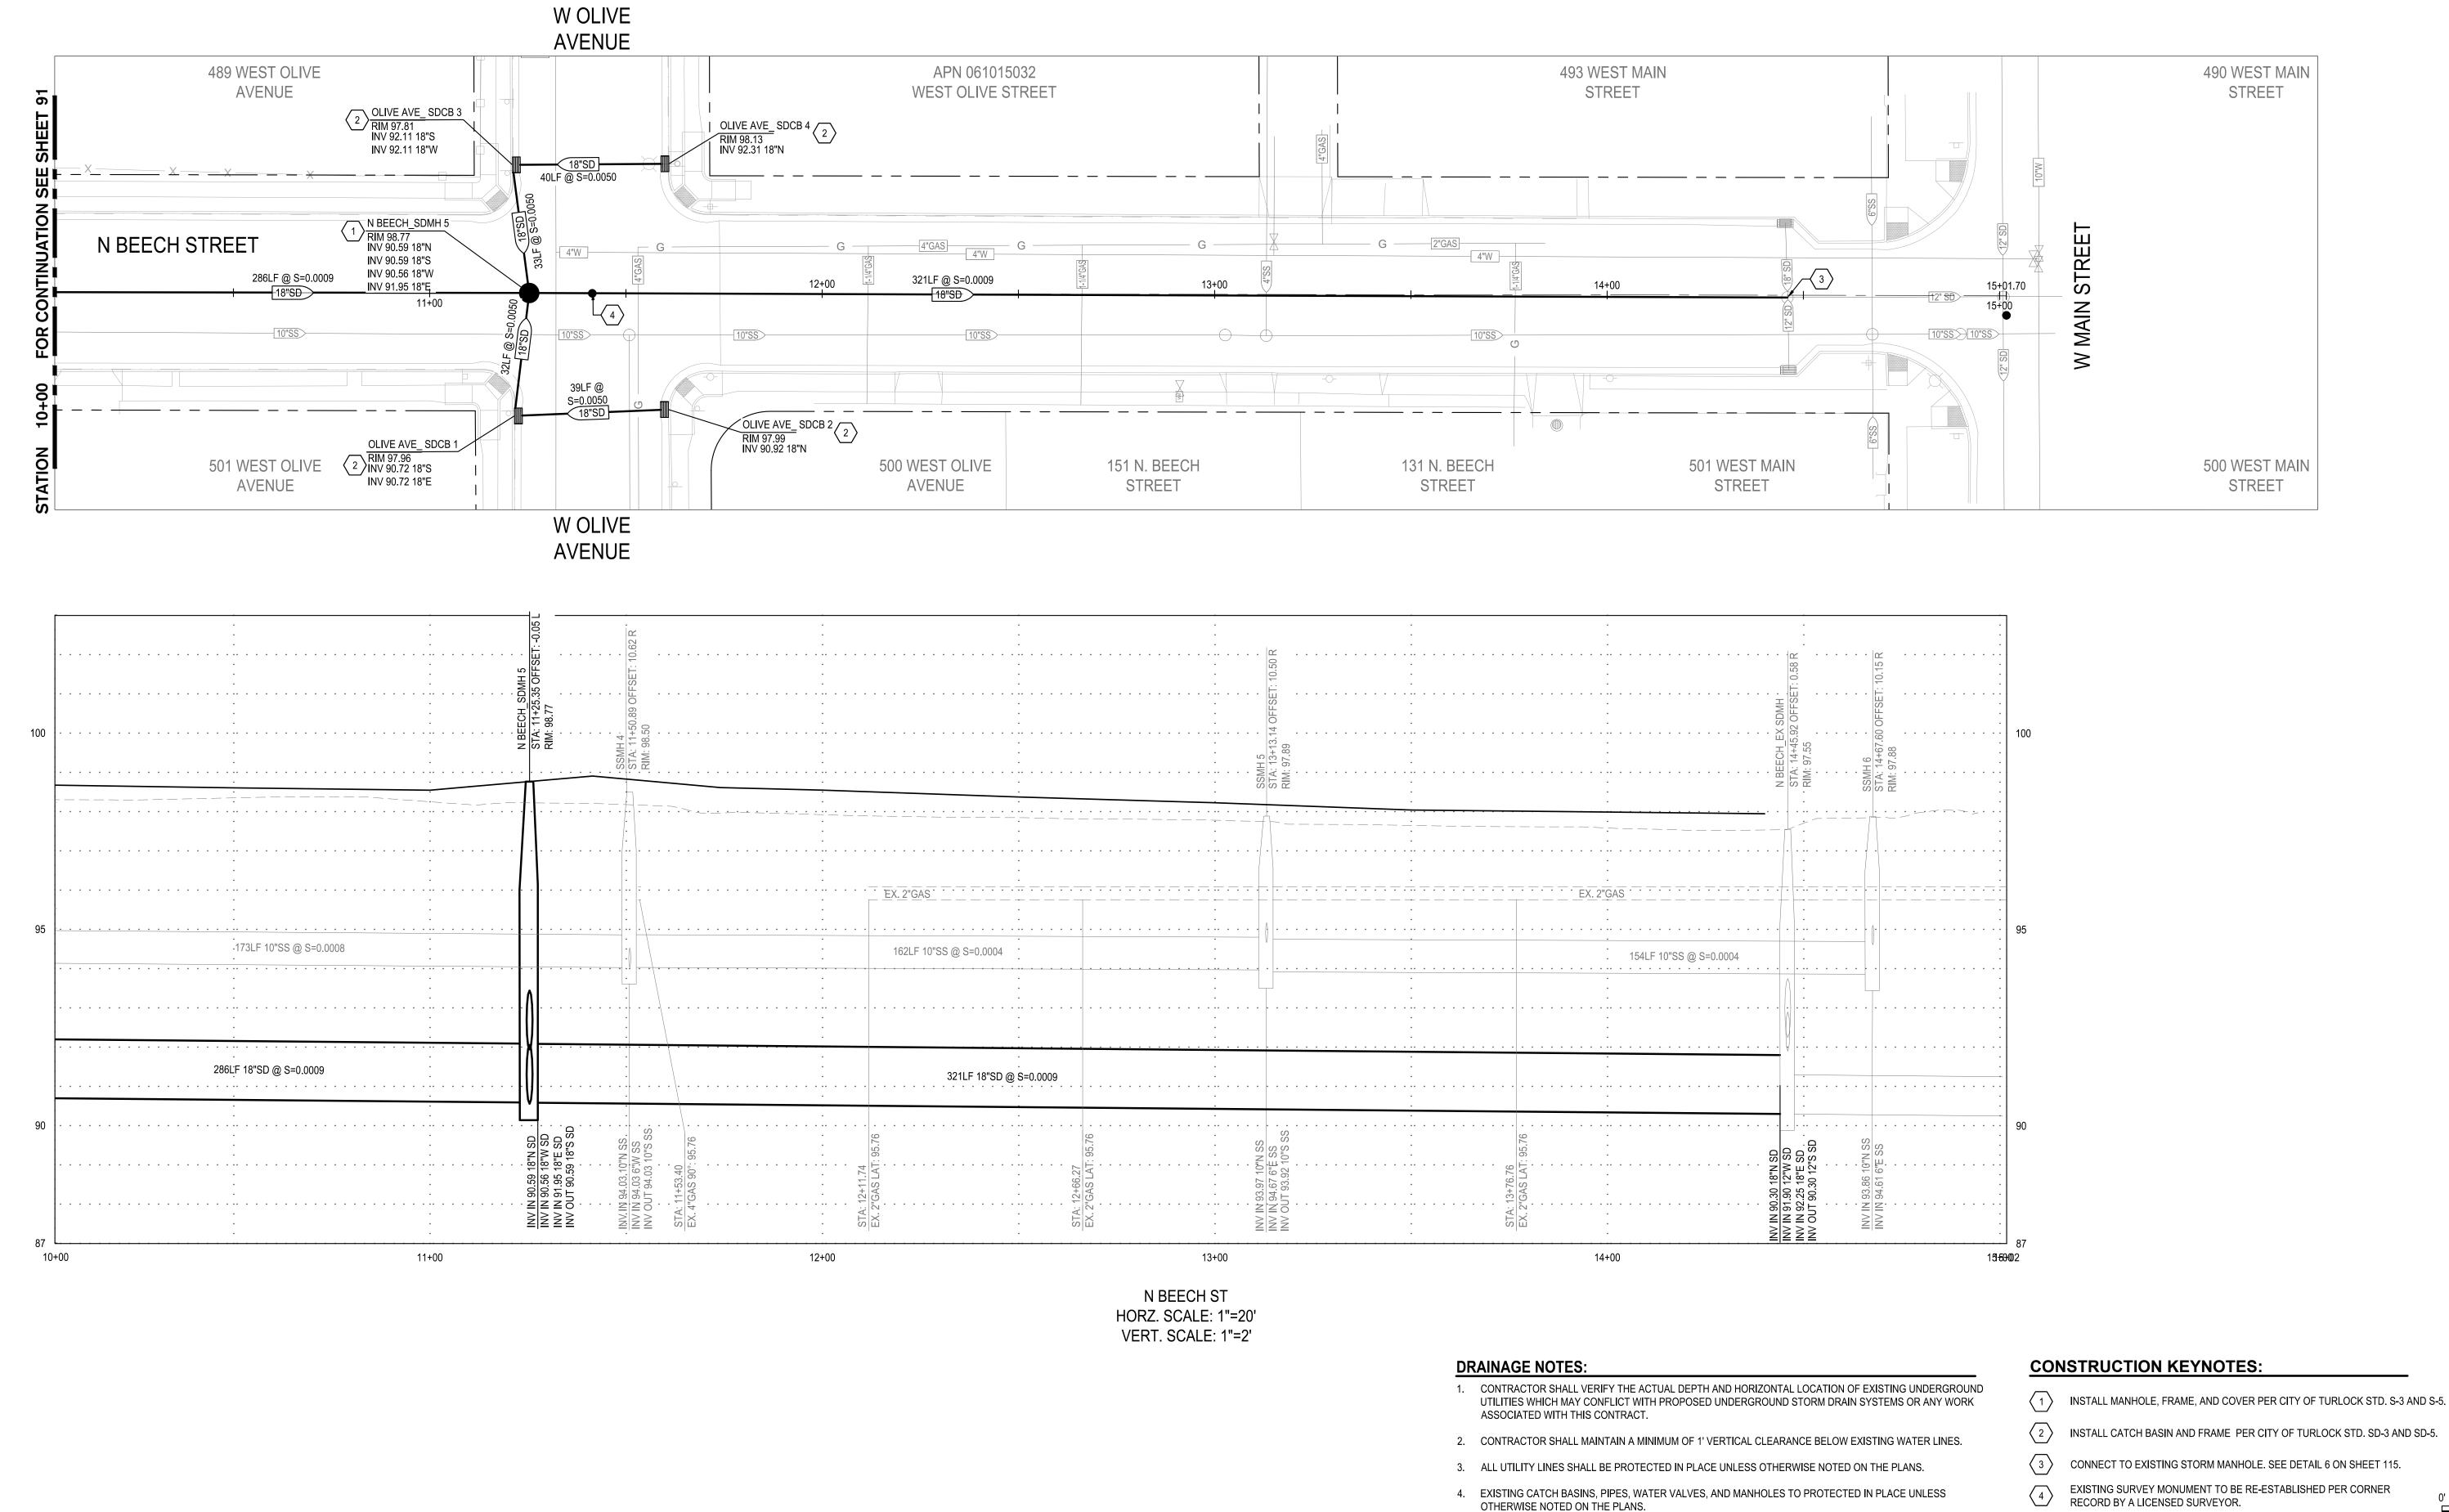




NOTE:
ALL REFERENCES AND WRITTEN
DIMENSIONS SHALL SUPERCEDE
ALL SCALED DISTANCES AND
SHALL BE VERIFIED IN THE
FIELD. ANY DISCREPANCY
SHALL BE BROUGHT TO THE
ATTENTION OF THE ENGINEER
PRIOR TO THE COMMENCEMENT
OF WORK

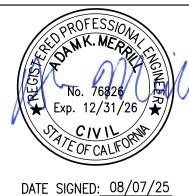



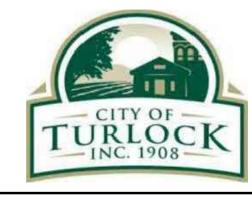



CITY OF TURLOCK MUNICIPAL SERVICES DEPARTMENT 156 S. BROADWAY, SUITE 150 (209) 668-5520


STORM DRAIN PROFILES - N BEECH STREET III


5. PIPELINES SHALL BE CLEANED AND FLUSHED, LOW PRESSURE AIR TESTED, AND CCTV'D PER CITY OF

TURLOCK SPECIFICATIONS 16-26, 16-27, 16-30, AND 16-33.

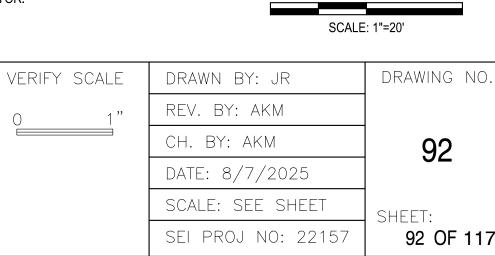

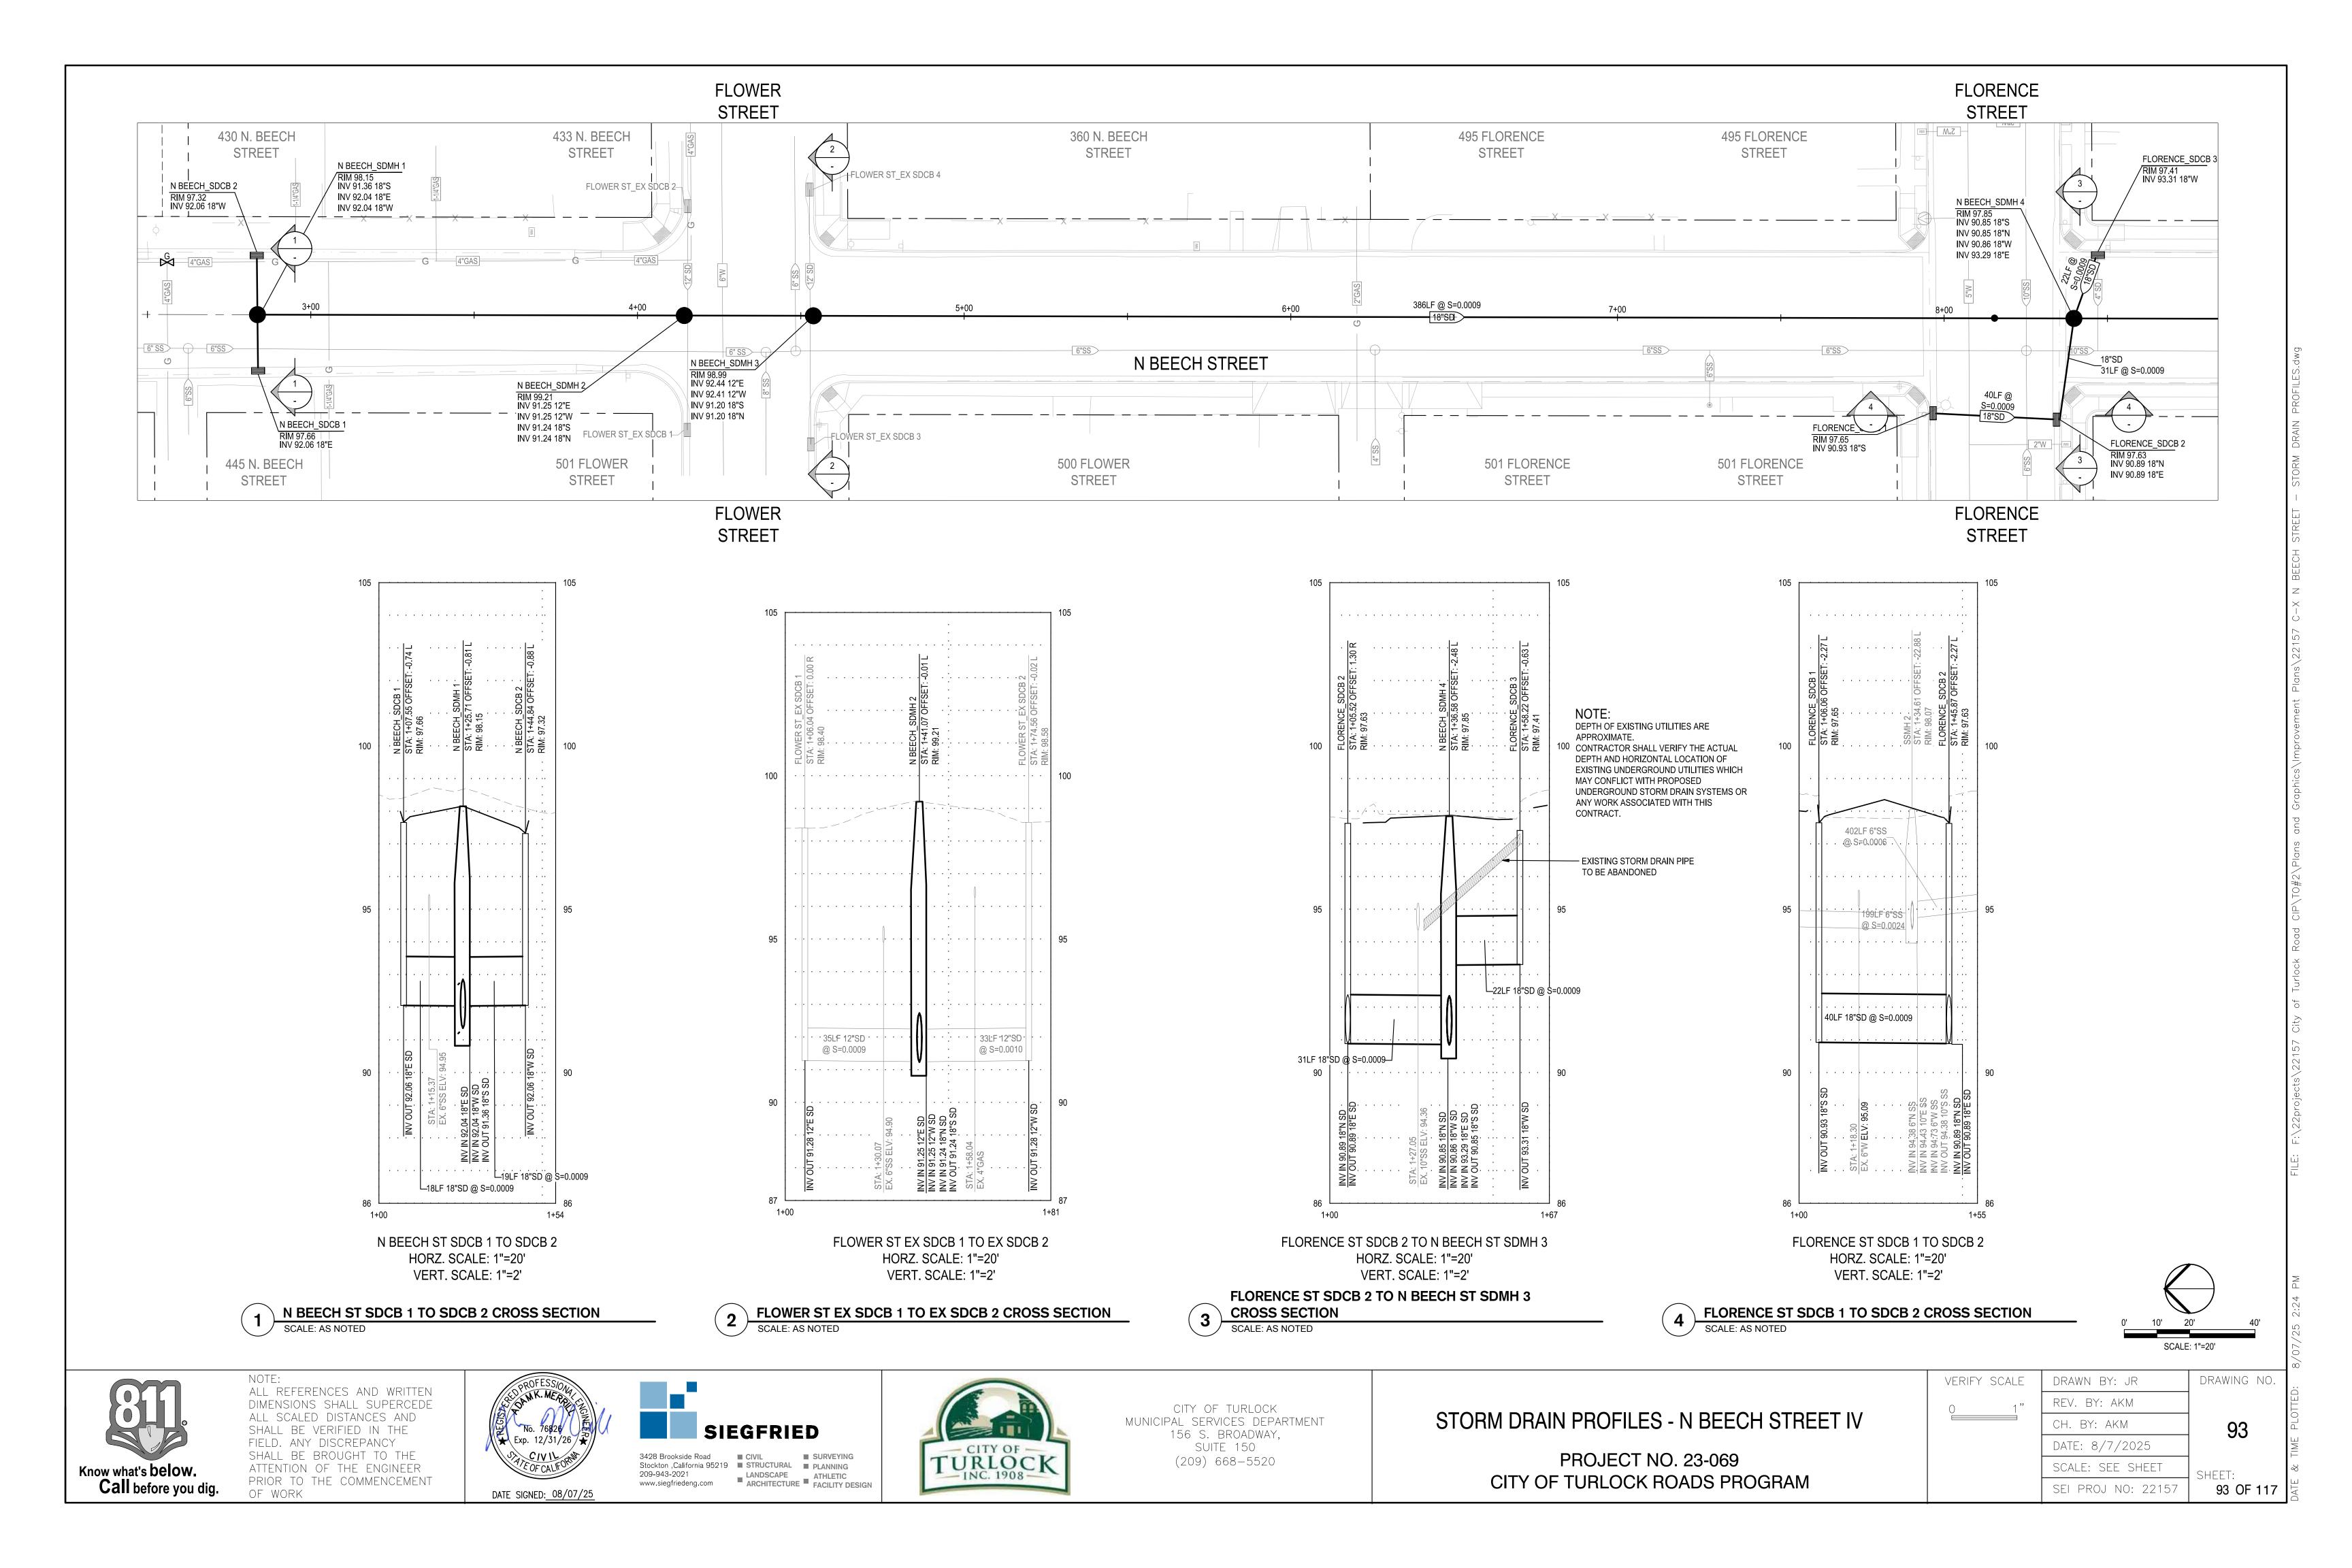

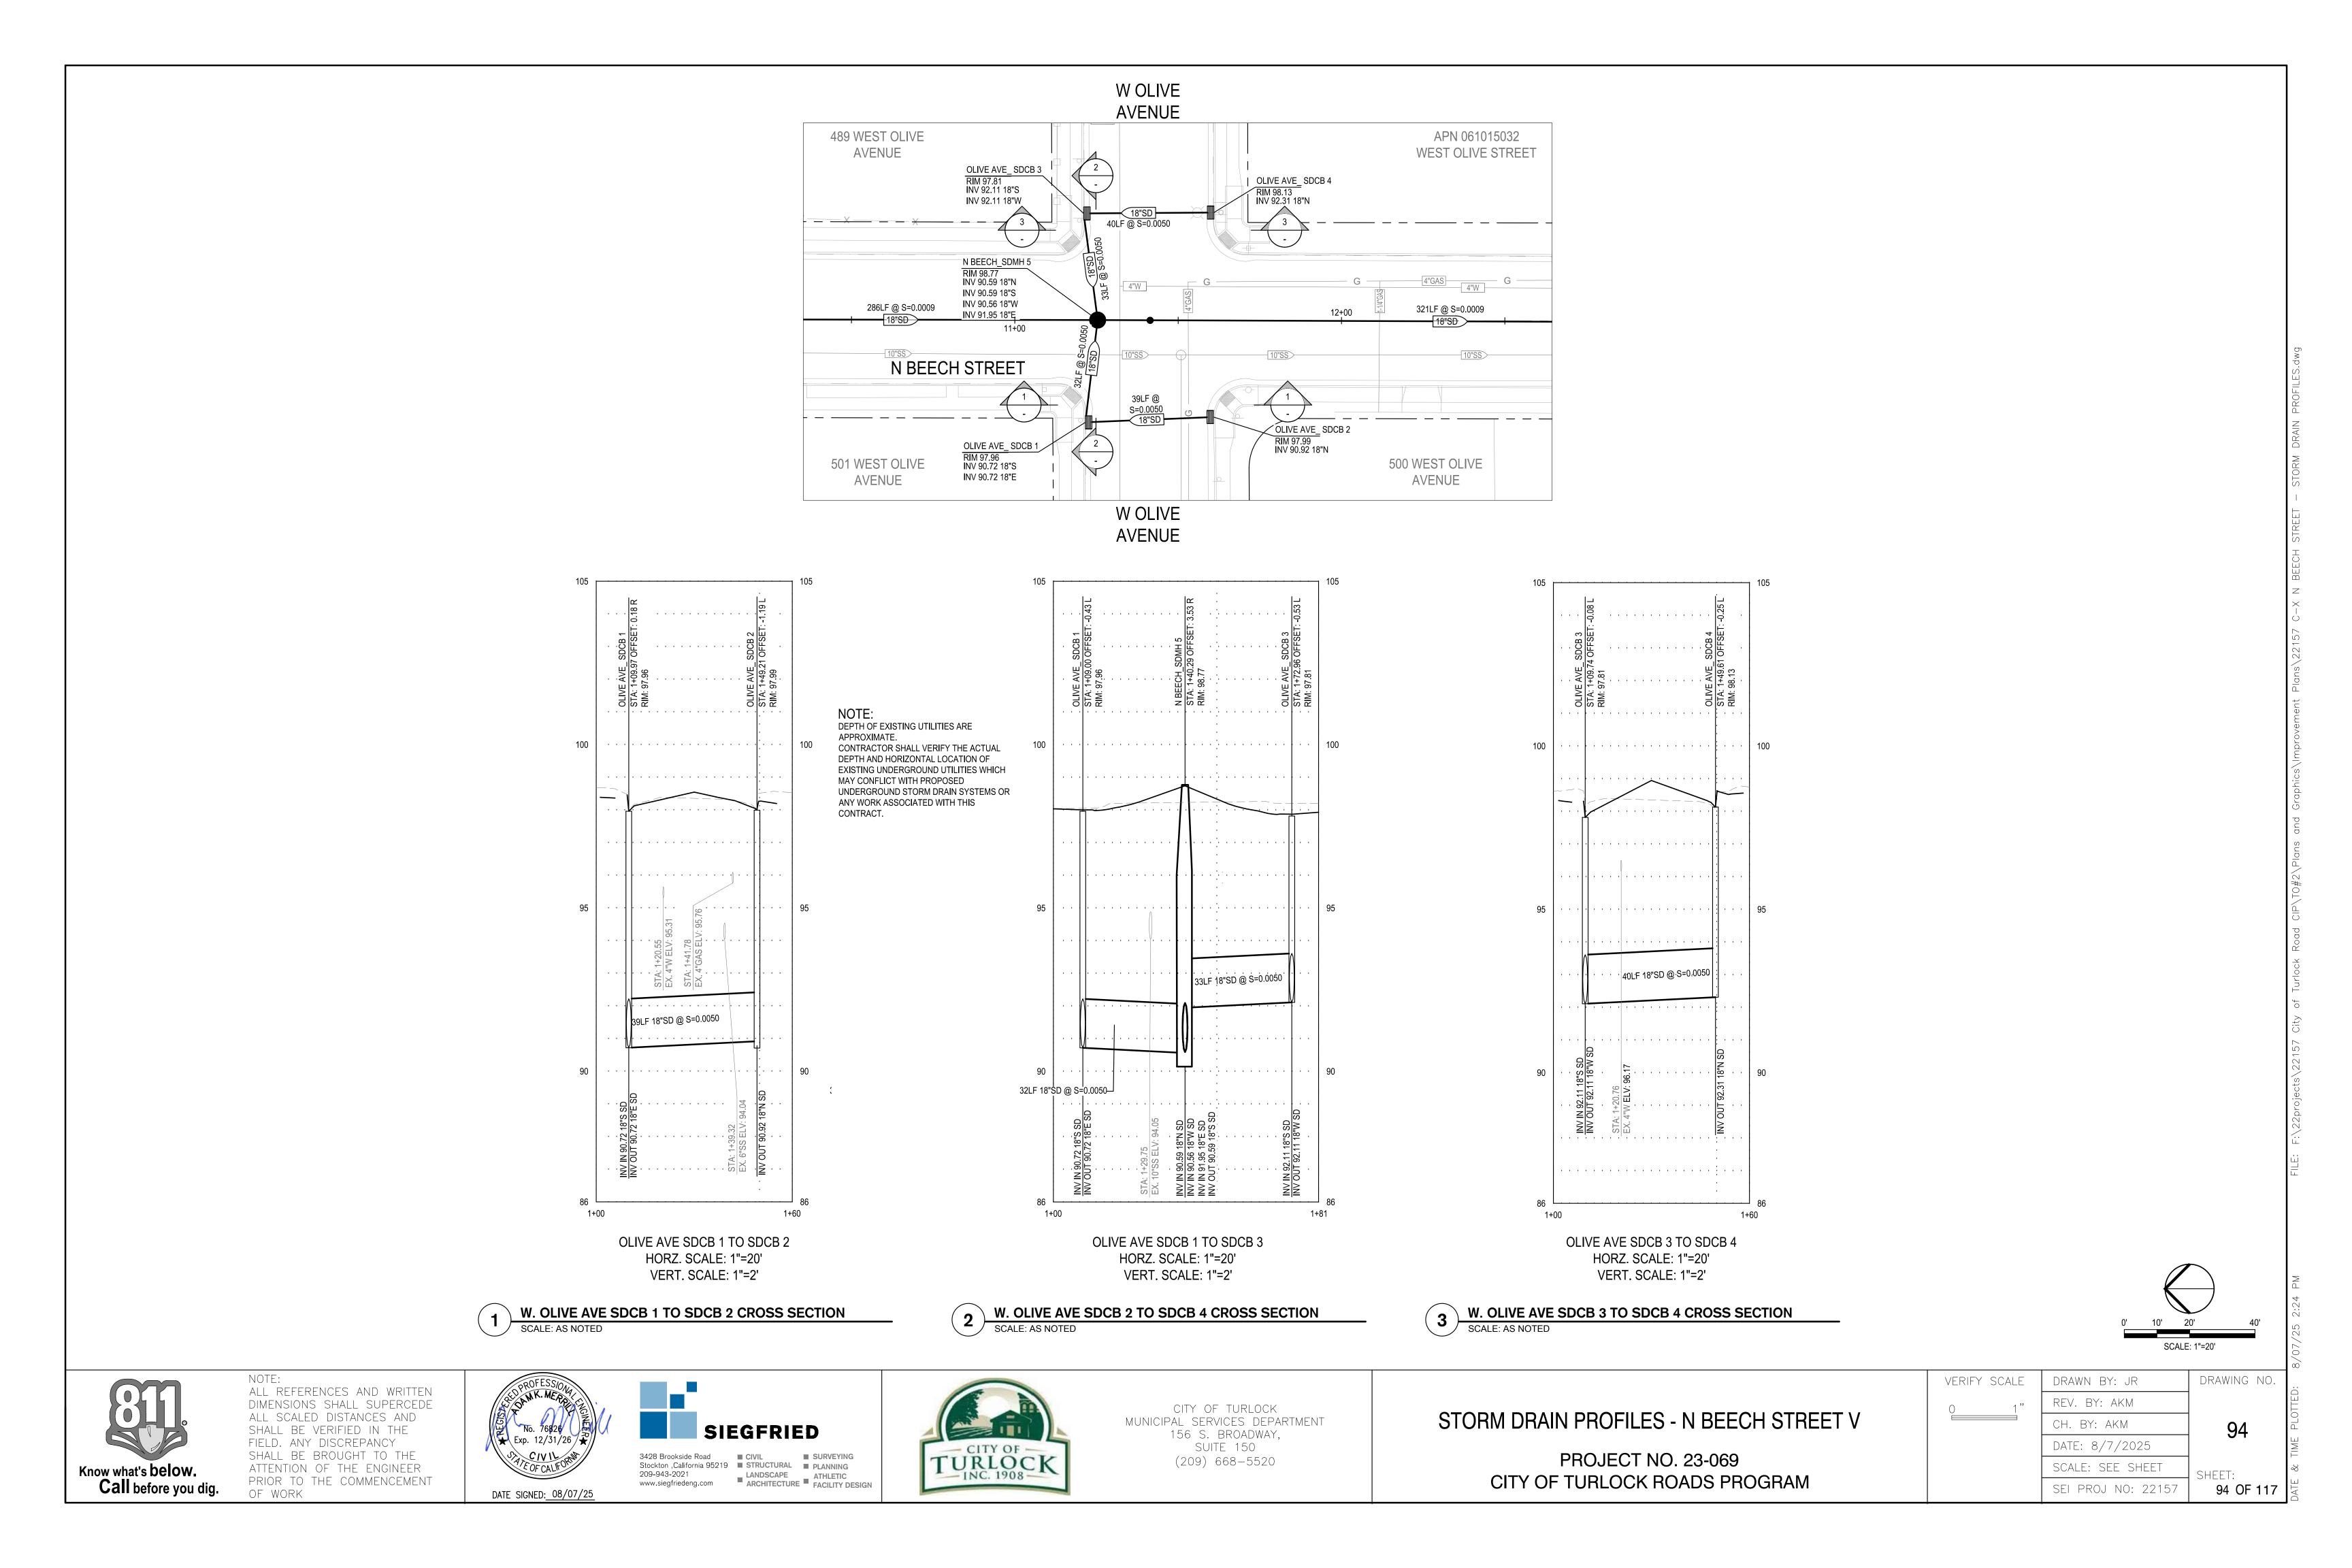

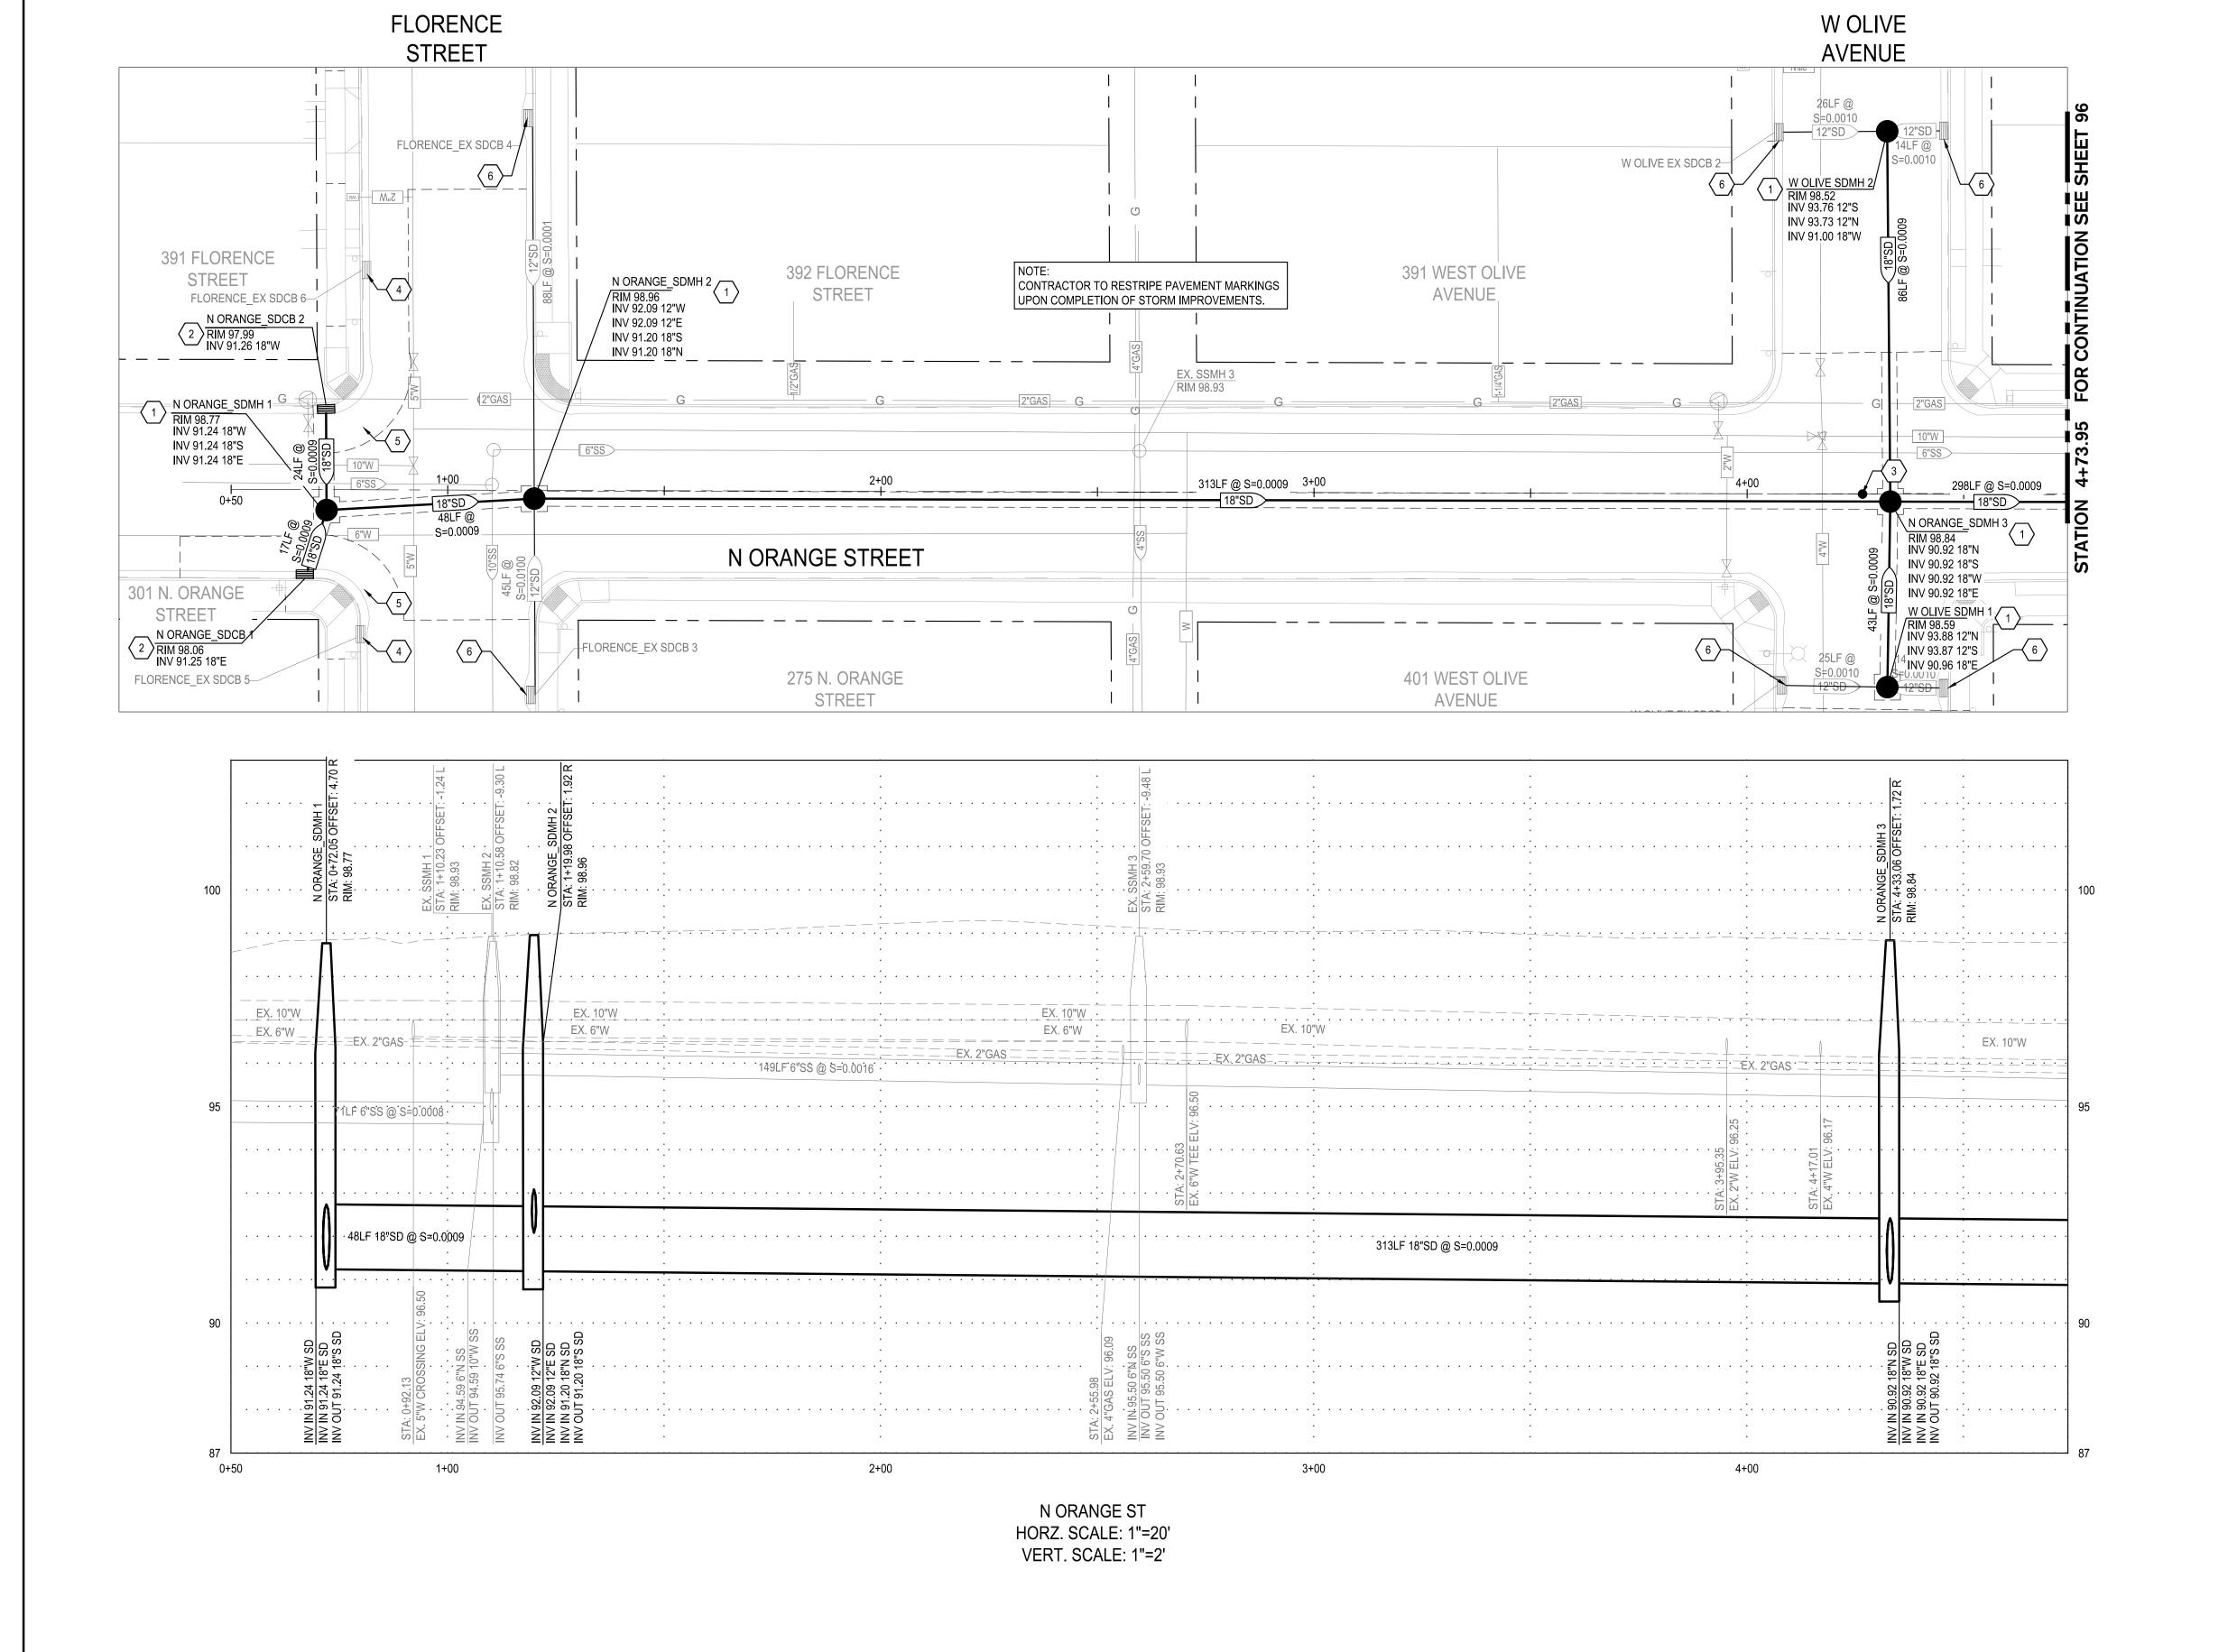


DRAINAGE NOTES:

- 1. CONTRACTOR SHALL VERIFY THE ACTUAL DEPTH AND HORIZONTAL LOCATION OF EXISTING UNDERGROUND UTILITIES WHICH MAY CONFLICT WITH PROPOSED UNDERGROUND STORM DRAIN SYSTEMS OR ANY WORK ASSOCIATED WITH THIS CONTRACT.
- 2. CONTRACTOR SHALL MAINTAIN A MINIMUM OF 1' VERTICAL CLEARANCE BELOW EXISTING WATER LINES.
- 3. ALL UTILITY LINES SHALL BE PROTECTED IN PLACE UNLESS OTHERWISE NOTED ON THE PLANS.
- 4. EXISTING CATCH BASINS, PIPES, WATER VALVES, AND MANHOLES TO BE PROTECTED IN PLACE UNLESS OTHERWISE NOTED ON THE PLANS.
- 5. PIPELINES SHALL BE CLEANED AND FLUSHED, LOW PRESSURE AIR TESTED, AND CCTV'D PER CITY OF TURLOCK SPECIFICATIONS 16-26, 16-27, 16-30, AND 16-33.


CONSTRUCTION KEYNOTES:

- INSTALL MANHOLE, FRAME, AND COVER PER CITY OF TURLOCK STD. S-3 AND S-5.
- INSTALL CATCH BASIN AND FRAME PER CITY OF TURLOCK STD. SD-3 AND SD-5.
- EXISTING SURVEY MONUMENT TO BE RE-ESTABLISHED PER CORNER RECORD BY A LICENSED SURVEYOR.
- REMOVE AND DISPOSE EXISTING STORM DRAIN INLET.
- PLUG AND ABANDON EXISTING STORM DRAIN PIPE. CONTRACTOR SHALL ABANDON AND PLUG EXISTING STORM PIPE IN
- PLACE WITH 3 FEET OF CONCRETE AT END. CONTRACTOR SHALL MAKE WATER-TIGHT THE ABANDONED SECTION.
- CONTRACTOR SHALL CONNECT EXISTING BUBBLE UPS TO NEW MANHOLE. FOR INVERTS SEE PROFILE & PLAN, SHEET 97

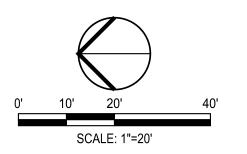




ALL REFERENCES AND WRITTEN DIMENSIONS SHALL SUPERCEDE ALL SCALED DISTANCES AND SHALL BE VERIFIED IN THE FIELD. ANY DISCREPANCY SHALL BE BROUGHT TO THE ATTENTION OF THE ENGINEER PRIOR TO THE COMMENCEMENT OF WORK

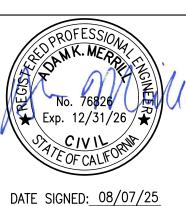



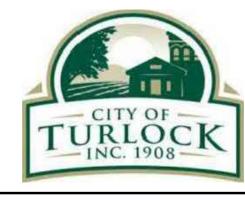

CITY OF TURLOCK MUNICIPAL SERVICES DEPARTMENT 156 S. BROADWAY, SUITE 150 (209) 668 - 5520


STORM DRAIN PROFILES - N ORANGE STREET I


PROJECT NO. 23-069 CITY OF TURLOCK ROADS PROGRAM

VERIFY SCALE	DRAWN BY: JR
0 1"	REV. BY: AKM
	CH. BY: AKM
	DATE: 8/7/20.
	SCALE: SEE SH

DRAWING NO. SHEET SEI PROJ NO: 22157

95 OF 117

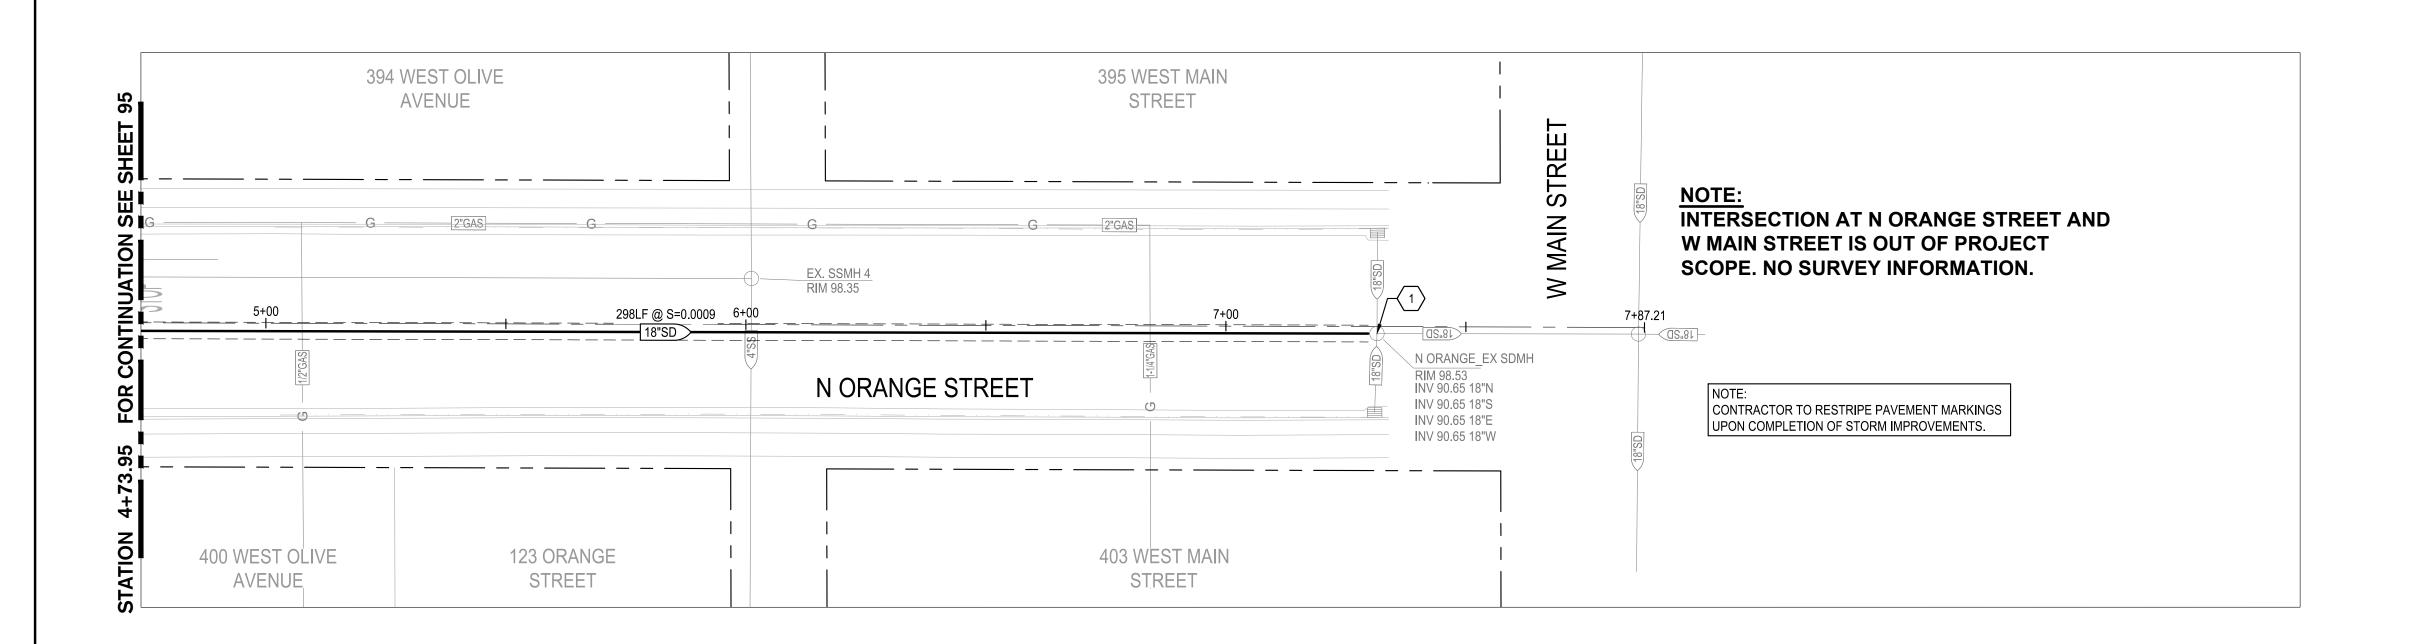

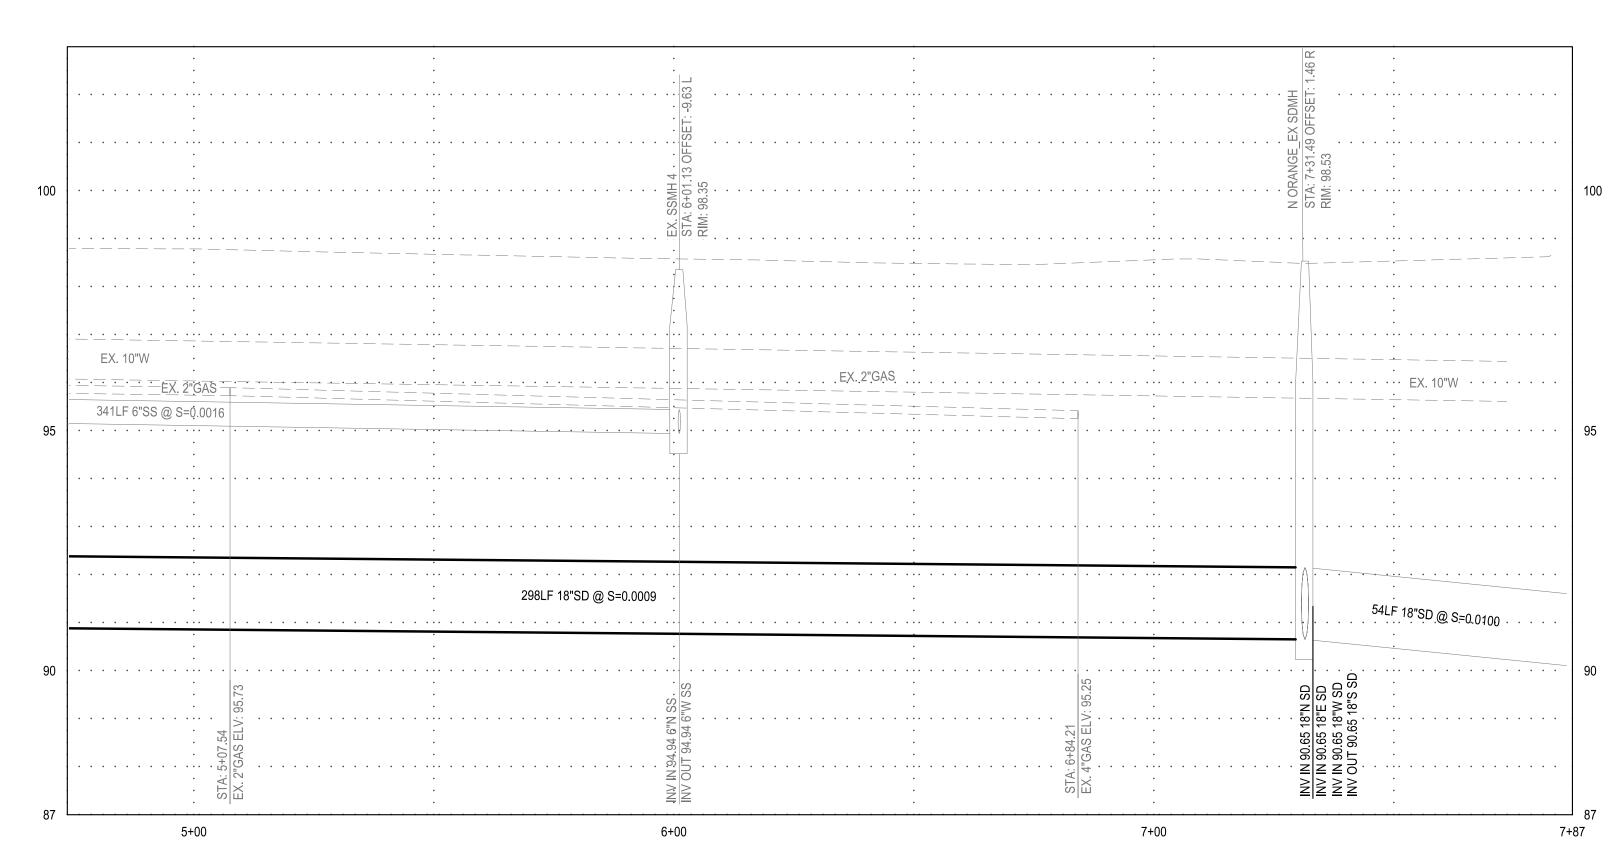


N ORANGE ST HORZ. SCALE: 1"=20' VERT. SCALE: 1"=2'

DRAINAGE NOTES:

- 1. CONTRACTOR SHALL VERIFY THE ACTUAL DEPTH AND HORIZONTAL LOCATION OF EXISTING UNDERGROUND UTILITIES WHICH MAY CONFLICT WITH PROPOSED UNDERGROUND STORM DRAIN SYSTEMS OR ANY WORK ASSOCIATED WITH THIS CONTRACT.
- 2. CONTRACTOR SHALL MAINTAIN A MINIMUM OF 1' VERTICAL CLEARANCE BELOW EXISTING WATER LINES.
- 3. ALL UTILITY LINES SHALL BE PROTECTED IN PLACE UNLESS OTHERWISE NOTED ON THE PLANS.
- 4. EXISTING CATCH BASINS, PIPES, WATER VALVES, AND MANHOLES TO PROTECTED IN PLACE UNLESS OTHERWISE NOTED ON THE PLANS.
- 5. PIPELINES SHALL BE CLEANED AND FLUSHED, LOW PRESSURE AIR TESTED, AND CCTV'D PER CITY OF TURLOCK SPECIFICATIONS 16-26, 16-27, 16-30, AND 16-33.

CONSTRUCTION KEYNOTES:

(1) CONNECT TO EXISTING STORM DRAIN MANHOLE.

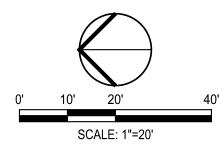


Know what's below.
Call before you dig.

NOTE:
ALL REFERENCES AND WRITTEN
DIMENSIONS SHALL SUPERCEDE
ALL SCALED DISTANCES AND
SHALL BE VERIFIED IN THE
FIELD. ANY DISCREPANCY
SHALL BE BROUGHT TO THE
ATTENTION OF THE ENGINEER
PRIOR TO THE COMMENCEMENT
OF WORK






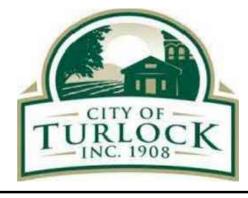


CITY OF TURLOCK MUNICIPAL SERVICES DEPARTMENT 156 S. BROADWAY, SUITE 150 (209) 668-5520


STORM DRAIN PROFILES - N ORANGE STREET II

VERIFY SCALE	DRAWN BY: JR	DRAWING N
0 1"	REV. BY: AKM	
	CH. BY: AKM	96
	DATE: 8/7/2025	
	SCALE: SEE SHEET	SHEET:
	SEI PROJ NO: 22157	96 OF 1

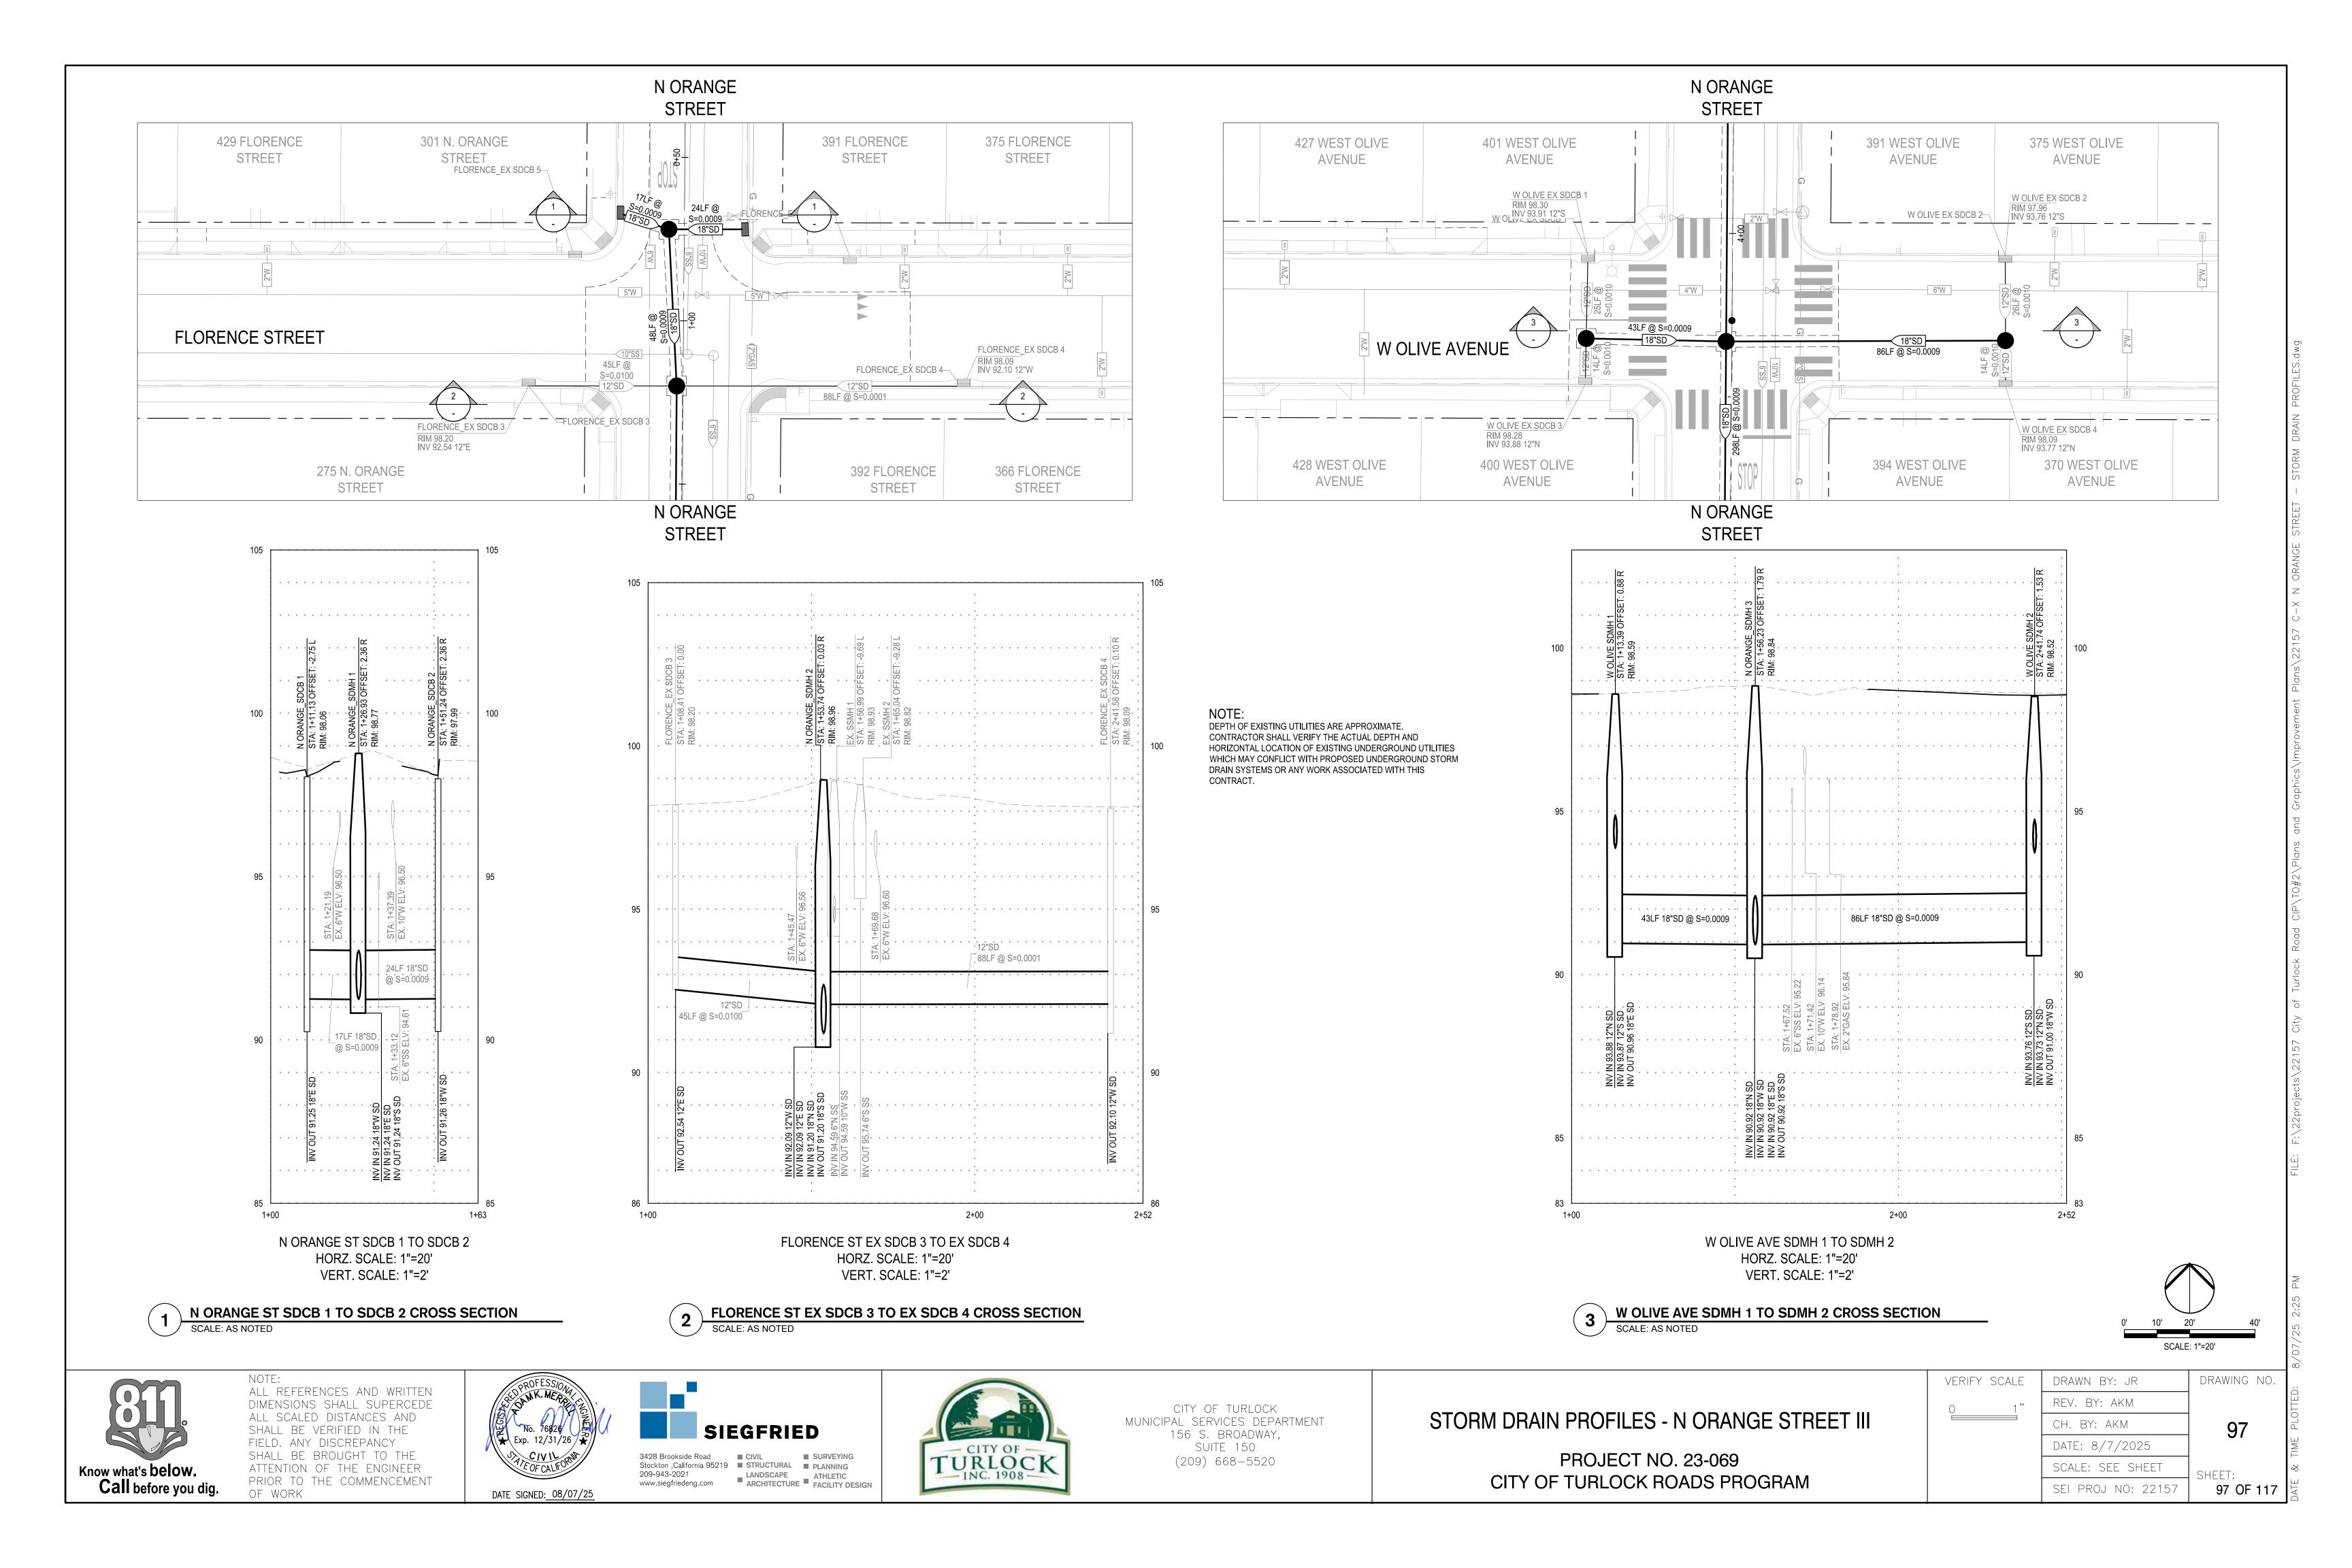

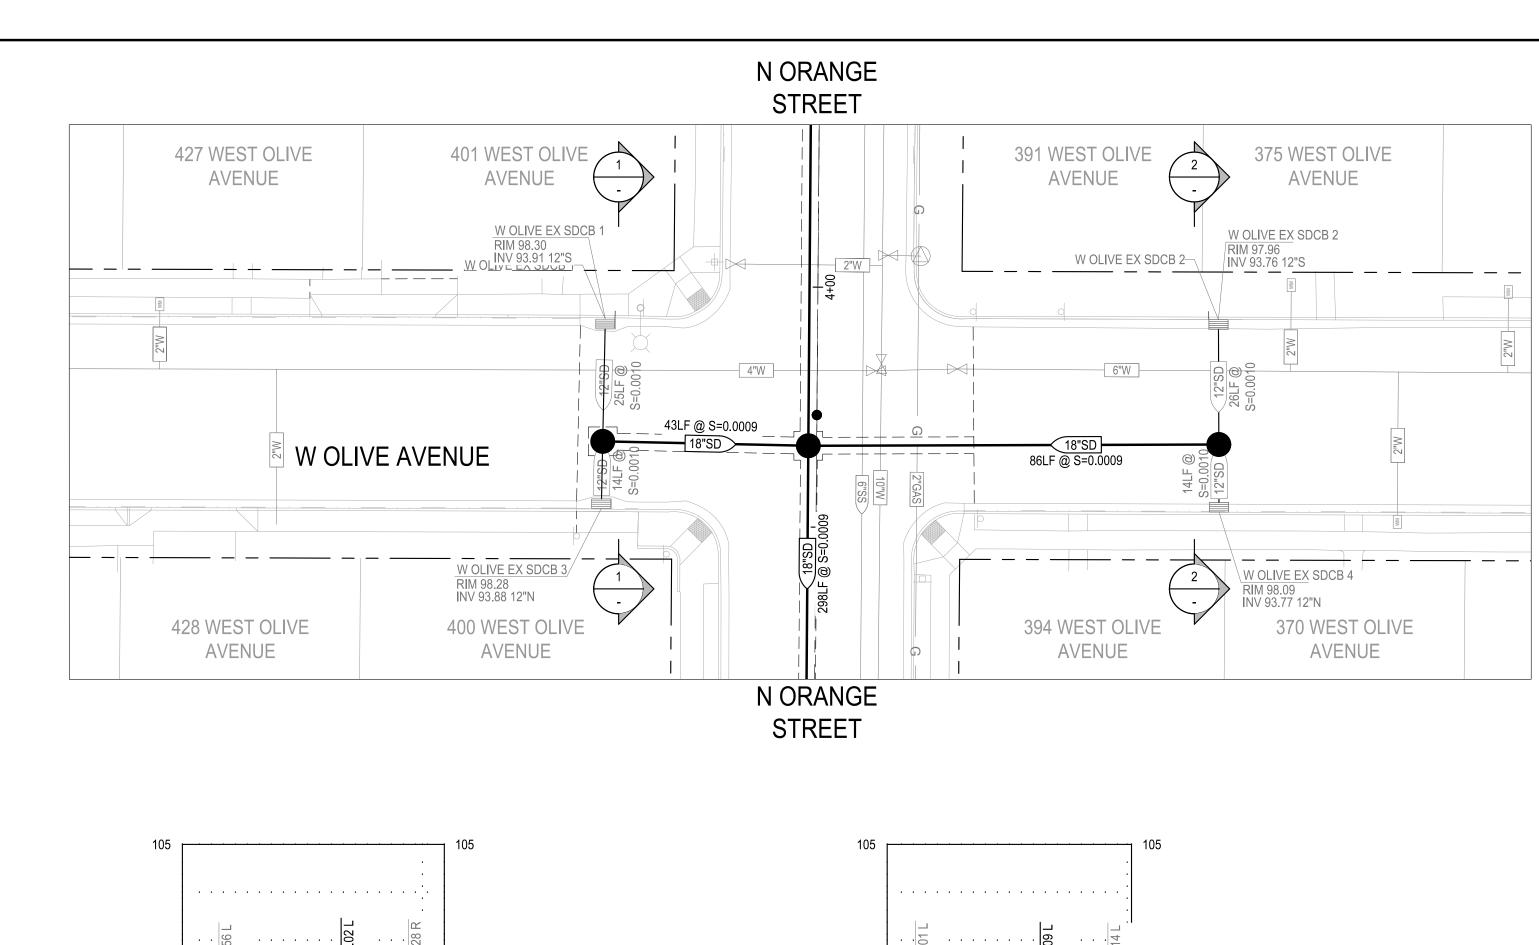

DEPTH OF EXISTING UTILITIES ARE APPROXIMATE. CONTRACTOR SHALL VERIFY THE ACTUAL DEPTH AND HORIZONTAL LOCATION OF EXISTING UNDERGROUND UTILITIES WHICH MAY CONFLICT WITH PROPOSED UNDERGROUND STORM DRAIN SYSTEMS OR ANY WORK ASSOCIATED WITH THIS CONTRACT.

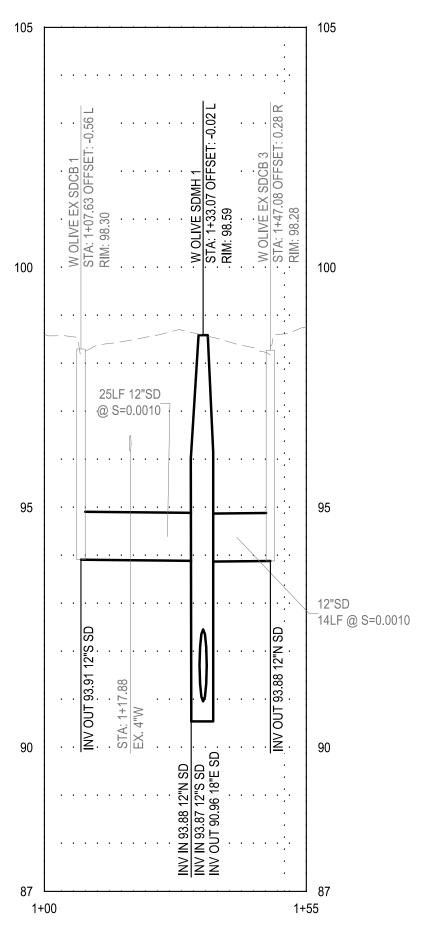

W OLIVE AVE EX SDCB 1 TO EX SDCB 3 HORZ. SCALE: 1"=20' VERT. SCALE: 1"=2'

W OLIVE AVE EX SDCB 1 TO EX SDCB 3 CROSS SECTION


__12"SD __14LF @ S=0.0010 INV IN 93.76 12"S SD INV IN 93.73 12"N SD INV OUT 91.00 18"W SD

W OLIVE AVE EX SDCB 2 TO EX SDCB 4 HORZ. SCALE: 1"=20' VERT. SCALE: 1"=2'




W OLIVE AVE EX SDCB 2 TO EX SDCB 4 CROSS SECTION

SCALE: AS NOTED

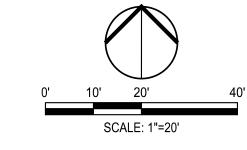




ALL REFERENCES AND WRITTEN DIMENSIONS SHALL SUPERCEDE
ALL SCALED DISTANCES AND
SHALL BE VERIFIED IN THE
FIELD. ANY DISCREPANCY
SHALL BE BROUGHT TO THE
ATTENTION OF THE ENGINEER PRIOR TO THE COMMENCEMENT OF WORK

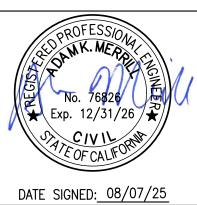



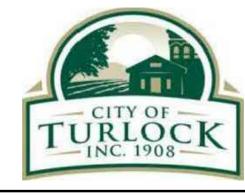



CITY OF TURLOCK MUNICIPAL SERVICES DEPARTMENT 156 S. BROADWAY, SUITE 150 (209) 668-5520


STORM DRAIN PROFILES - N ORANGE STREET IV

1"	REV. BY:
	CH. BY: A
	DATE: 8/7
	SCALE: SE
	SEI PROJ

PROJECT NO. 23-069 CITY OF TURLOCK ROADS PROGRAM VERIFY SCALE DRAWN BY: JR DRAWING NO. AKM /7/2025 SEE SHEET SEI PROJ NO: 22157 98 OF 117

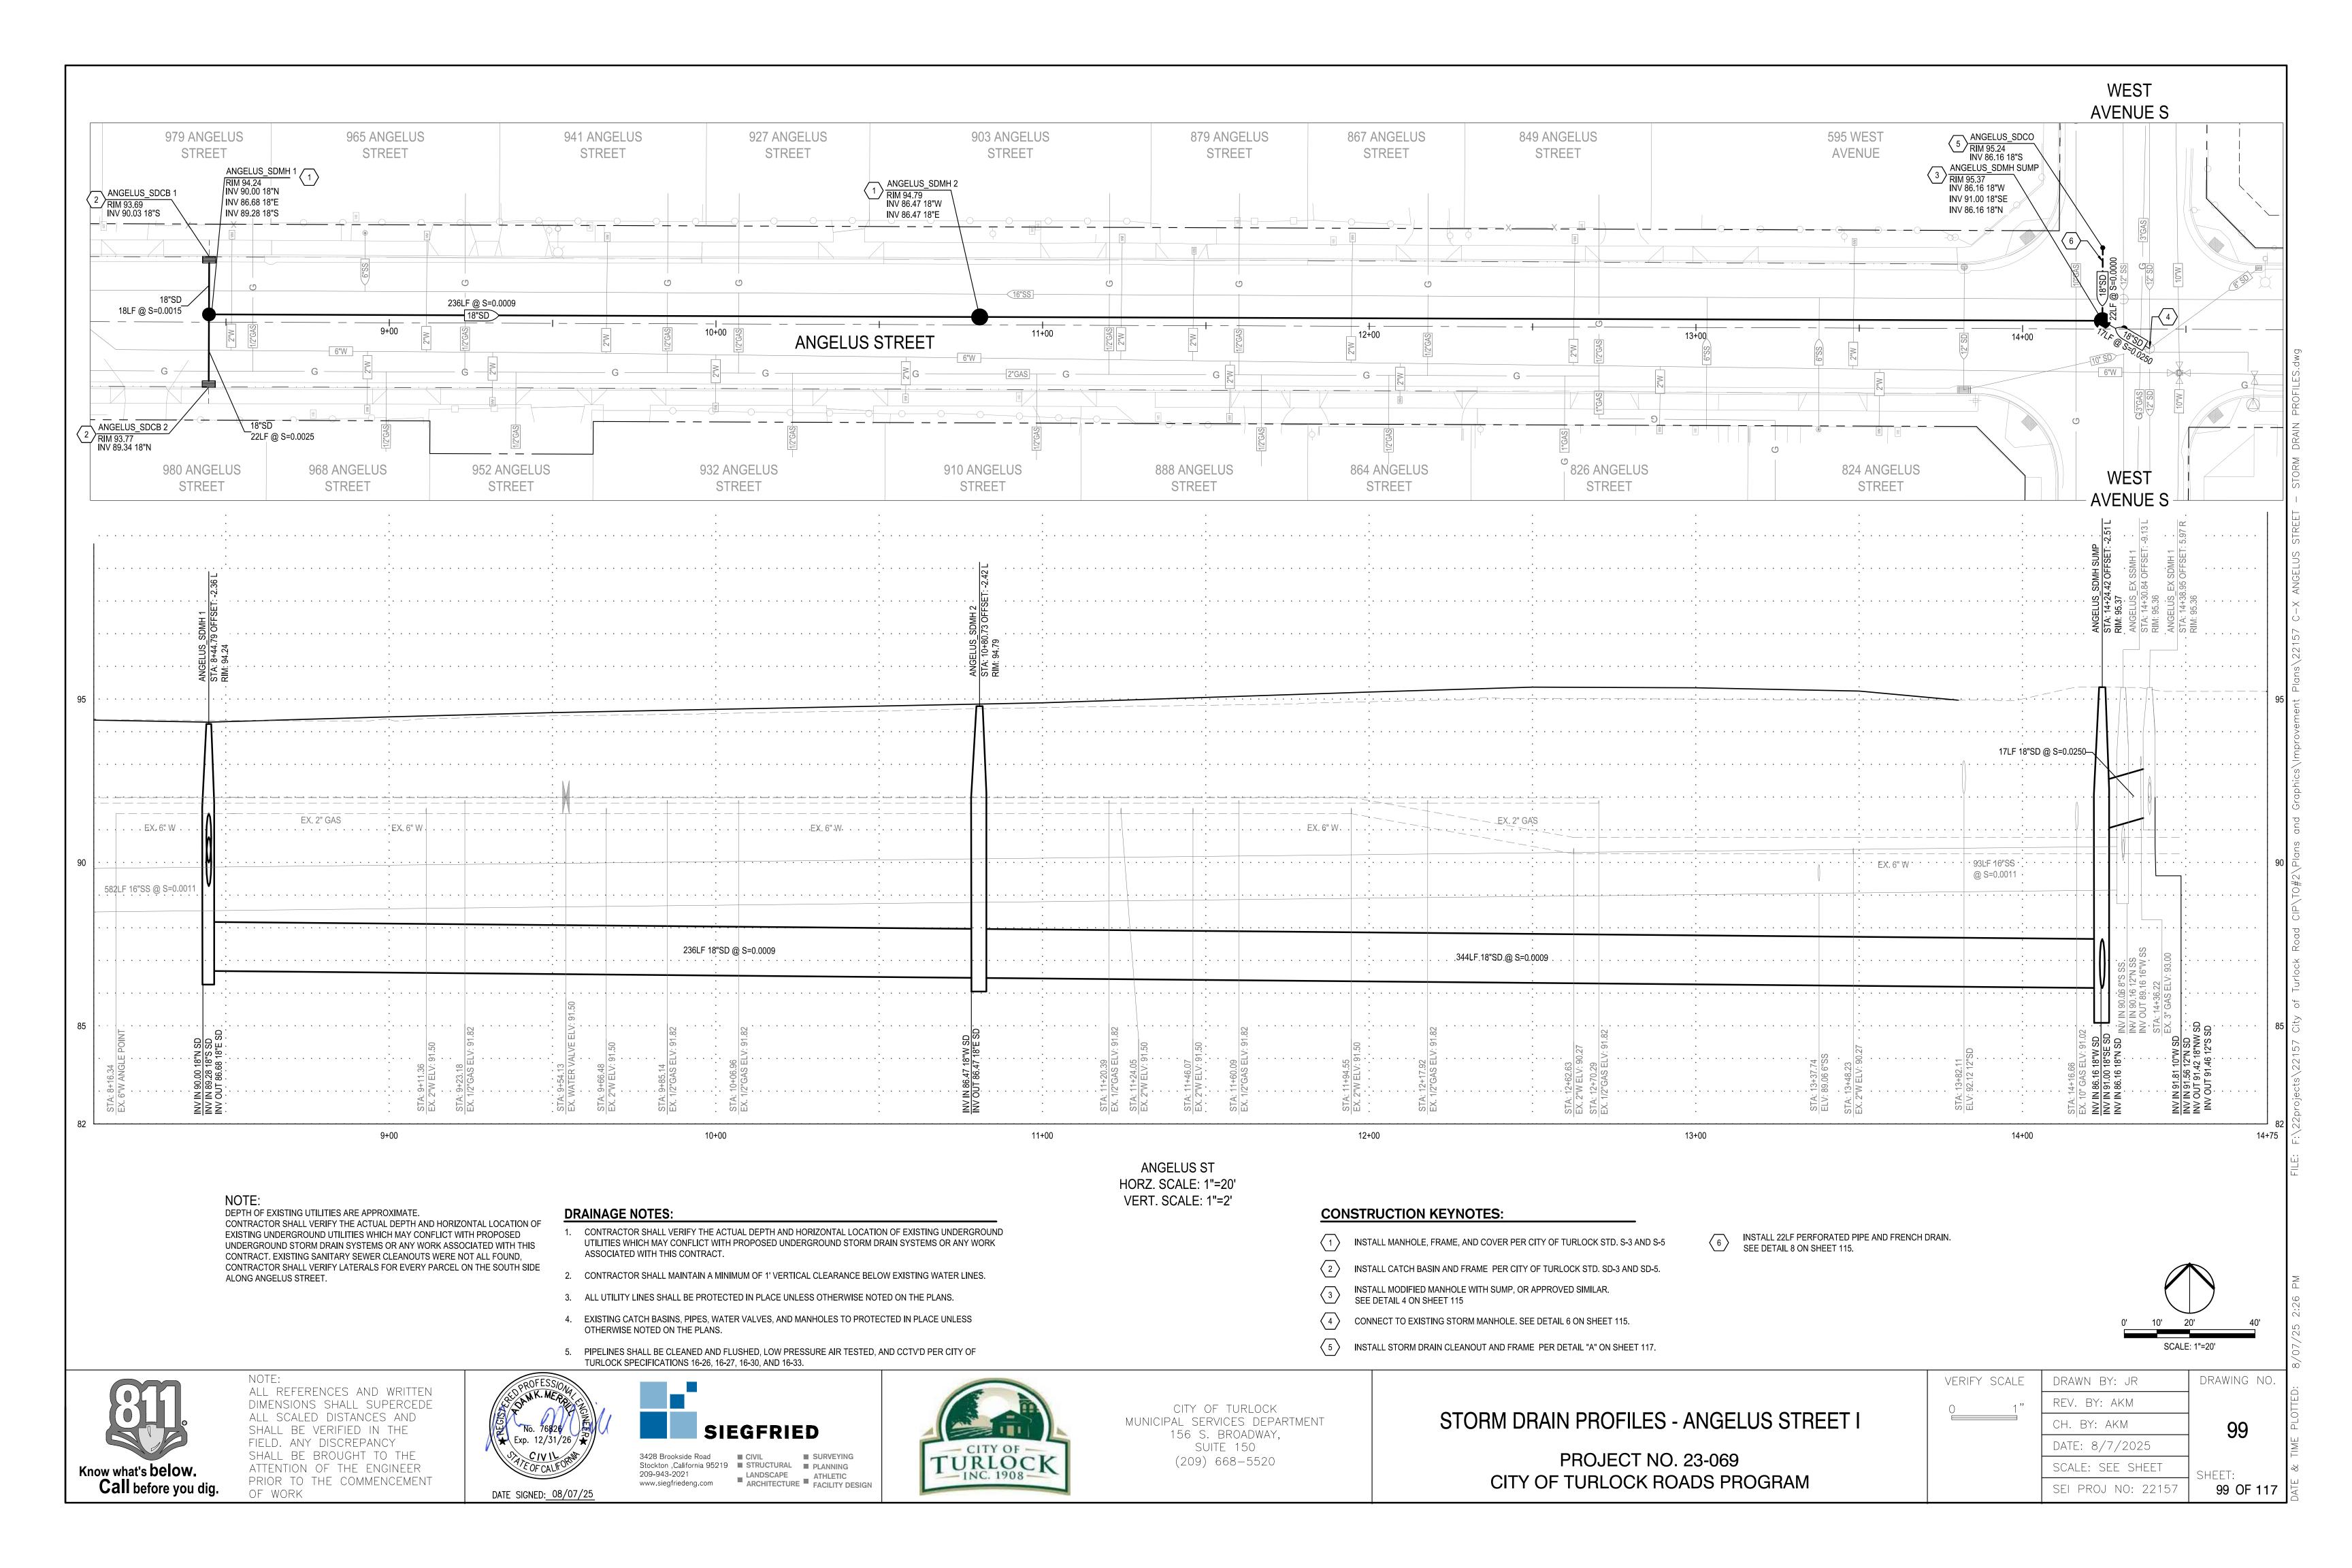

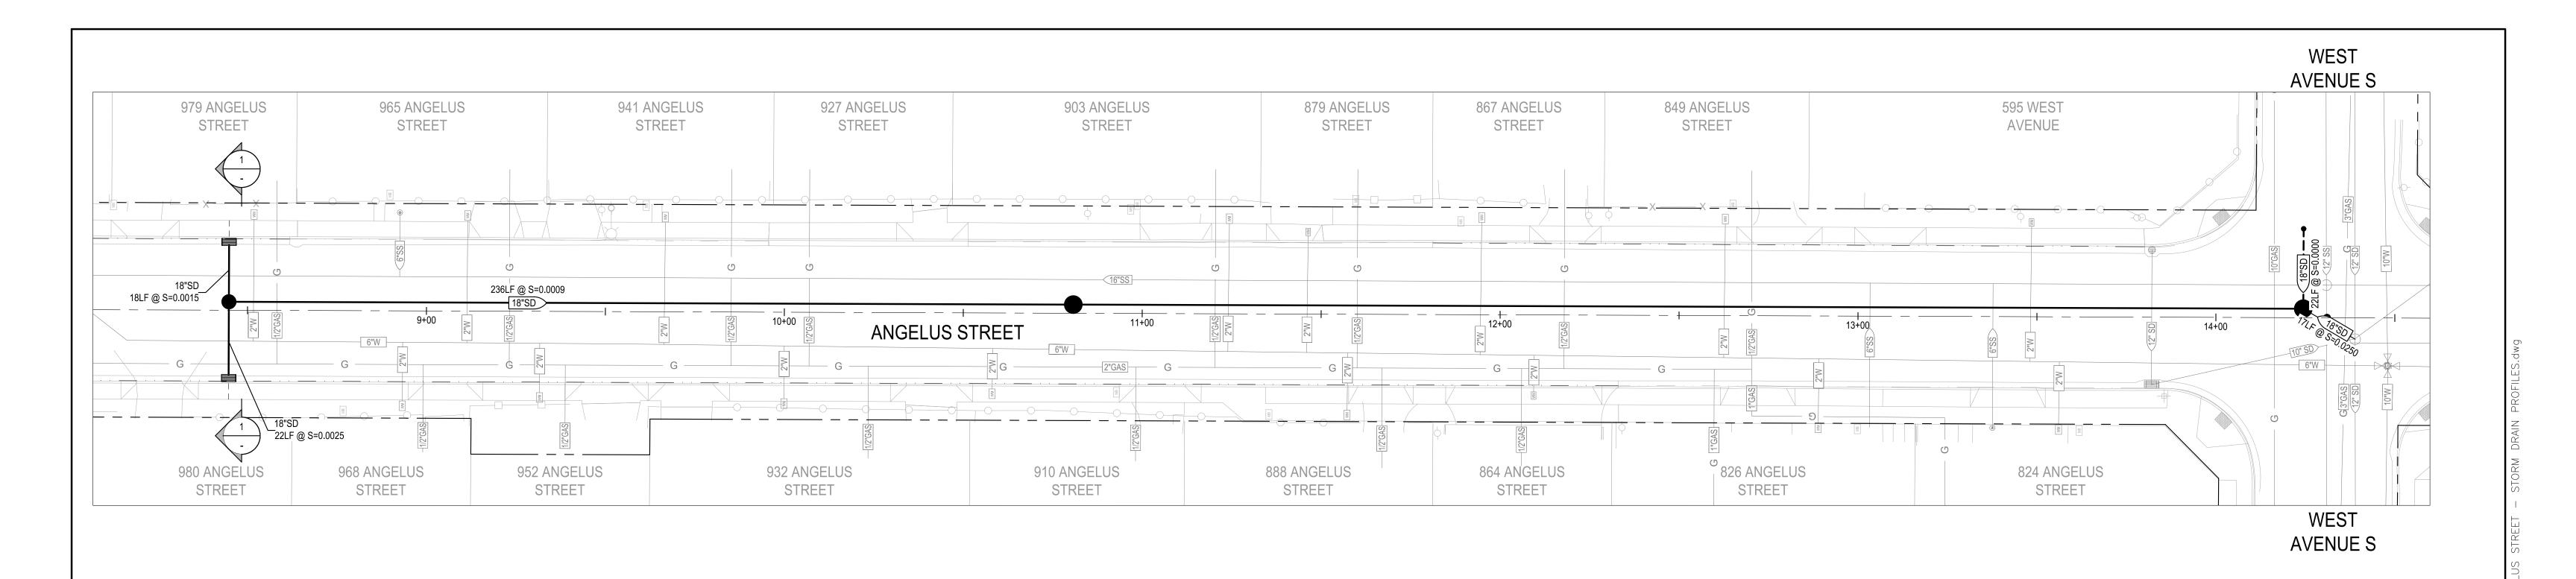


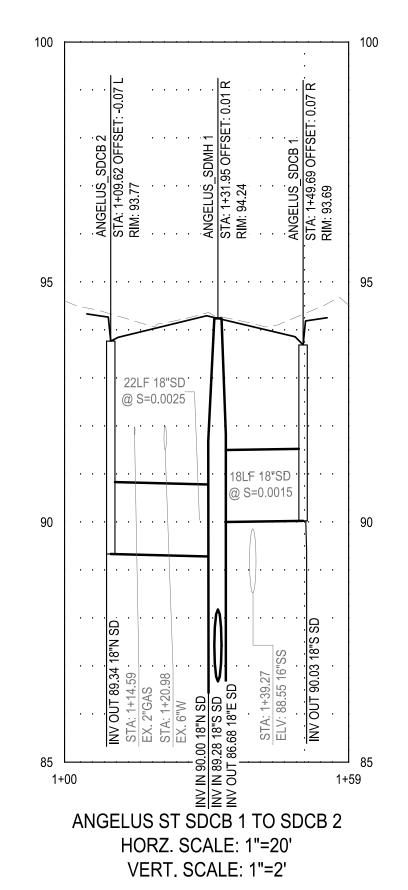

NOTE:
DEPTH OF EXISTING UTILITIES ARE APPROXIMATE.
CONTRACTOR SHALL VERIFY THE ACTUAL DEPTH AND
HORIZONTAL LOCATION OF EXISTING UNDERGROUND
UTILITIES WHICH MAY CONFLICT WITH PROPOSED
UNDERGROUND STORM DRAIN SYSTEMS OR ANY WORK
ASSOCIATED WITH THIS CONTRACT.


ANGELUS ST SDCB 1 TO SDCB 2 CROSS SECTION

SCALE: AS NOTED

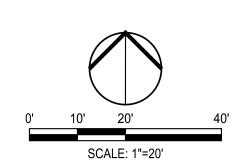




NOTE:
ALL REFERENCES AND WRITTEN
DIMENSIONS SHALL SUPERCEDE
ALL SCALED DISTANCES AND
SHALL BE VERIFIED IN THE
FIELD. ANY DISCREPANCY
SHALL BE BROUGHT TO THE
ATTENTION OF THE ENGINEER
PRIOR TO THE COMMENCEMENT
OF WORK

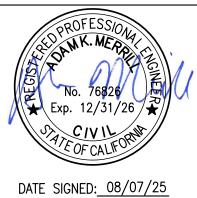



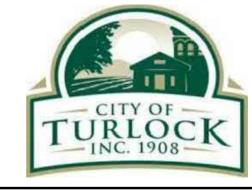

CITY OF TURLOCK
MUNICIPAL SERVICES DEPARTMENT
156 S. BROADWAY,
SUITE 150
(209) 668-5520

STORM DRAIN PROFILES - ANGELUS STREET II
PROJECT NO. 23-069
CITY OF TURLOCK ROADS PROGRAM

ERIFY SCALE	DRAWN BY: JR	DRAWING NO.
) 1"	REV. BY: AKM	
	CH. BY: AKM	100
	DATE: 8/7/2025	100
	SCALE: SEE SHEET	SHEET:
	SEI PROJ NO: 22157	100 OF117

TRAFFIC CONTROL GENERAL NOTES

- 1. VALIDATION: THE TRAFFIC CONTROL PLAN IS NOT VALID UNTIL WORK DATES ARE APPROVED. THE CONTRACTOR SHALL, PER SECTION 601-2 OF THE CITY SUPPLEMENT TO THE STANDARD SPECIFICATIONS FOR THE PUBLIC WORKS CONSTRUCTION, CONTACT THE PUBLIC WORKS TRAFFIC CONTROL SECTION AT (209) 668-5590 TO OBTAIN A PERMIT. THE CONTRACTOR MUST SUBMIT A COMPLETED TRAFFIC CONTROL PERMIT FOR A MINIMUM OF TWO (2) WORKING DAYS PRIOR TO STARTING WORK, OR FIVE (5) WORKING DAYS WHEN WORK WILL AFFECT A TRAFFIC SIGNAL.
- 2. STANDARDS: THIS TRAFFIC CONTROL PLAN SHALL CONFORM TO EACH OF THE FOLLOWING MANUALS:

EDITION DESCRIPTION


- 2016 CITY OF TURLOCK STANDARDS SPECIFICATIONS AND DRAWINGS
- 2023 CALTRANS STANDARD PLANS 2014 CALIFORNIA MANUAL ON UNIFORM TRAFFIC CONTROL DEVICES (CA MUTCD)
- 3. NOTIFICATIONS: THE CONTRACTOR SHALL NOTIFY RELEVANT AGENCIES A MINIMUM OF SEVEN (7) WORKING DAYS PRIOR TO ANY EXCAVATION, CONSTRUCTION, OR TRAFFIC CONTROL.
- 4. THE CONTRACTOR SHALL NOTIFY PROPERTY OWNERS AND TENANT A MINIMUM OF SEVEN (7) WORKING DAYS PRIOR TO CLOSURE OF DRIVEWAYS. THE CONTRACTOR SHALL POST SIGNS NOTIFYING THE PUBLIC A MINIMUM OF SEVEN (7) WORKING DAYS PRIOR TO CLOSURE OF STREETS.
- 5. POSTING PARKING RESTRICTIONS: THE CONTRACTOR SHALL POST "TOW-AWAY/ NO PARKING" SIGNS SEVENTY TWO (72) HOURS IN ADVANCE OF PARKING REMOVAL. SIGNS SHALL INDICATE SPECIFIC DAYS, DATES, AND TIMES OF RESTRICTIONS.
- 6. EXCAVATIONS: EXCEPT AS OTHERWISE SHOWN ON THE PLANS, TRENCHES SHALL BE BACKFILLED OR TRENCH-PLATED AT THE END OF EACH WORK DAY. AN ASPHALT RAMP SHALL BE PLACED AROUND EACH TRENCH PLATE TO PREVENT THE PLATE FROM BEING DISLODGE. UPON COMPLETION OF EXCAVATION BACK FILL, THE CONTRACTOR SHALL PROVIDE A SATISFACTORY SURFACE FOR TRAFFIC. WEN CONSTRUCTION OPERATIONS ARE NOT ACTIVELY IN PROGRESS, THE CONTRACTOR SHALL MAINTAIN ALL TRAVEL LANES, BIKE LANES, AND PEDESTRIAN WALKWAYS OPEN TO THE APPROPRIATE TRAFFIC EXCEPT AS OTHERWISE SHOWN ON THE PLANS.
- 7. RESTORATION OF THE TRAFFIC CONTROL DEVICES: THE CONTRACTOR SHALL REPAIR OR REPLACE TRAFFIC CONTROL DEVICES (INCLUDING TRAFFIC SIGNS, STRIPING, PAVEMENT MARKERS, PAVEMENT MARKINGS, LEGEND, CURB MARKING, LOOP DETECTORS, TRAFFIC SIGNAL EQUIPMENT, ETC) DAMAGED OR REMOVED AS A RESULT OF OPERATIONS AND NOT DESIGNATED FOR REMOVAL. REPAIRS AND REPLACEMENTS SHALL BE AT LEAST EQUAL TO
- 8. TEMPORARY TRAFFIC SIGNAL DETECTION: THE CONTRACTOR SHALL INSTALL CITY APPROVED TEMPORARY VIDEO OR RADAR DETECTION WHEN EXISTING TRAFFIC SIGNAL DETECTION ARE DAMAGED. DISABLED. OR BECOME INEFFECTIVE DUE TO CONSTRUCTION FOR A PERIOD OF FIVE (5) OR MORE DAYS. THE CONTRACTOR SHALL COMPLETELY REMOVE ALL TEMPORARY TRAFFIC SIGNAL DETECTION EQUIPMENT AND RESTORE/INSTALL A CITY APPROVED PERMANENT VEHICLE DETECTION SYSTEM UPON COMPLETION OF CONSTRUCTION. ALL INSTALLATION AND REMOVALS ARE SUBJECT TO APPROVAL BY THE CITY ENGINEER.
- 9. CHANGE IN WORK: THE CITY ENGINEER WILL OBSERVE THESE TRAFFIC CONTROL PLANS IN OPERATION AND RESERVE THE RIGHT TO MAKE ANY CHANGES AS FIELD CONDITIONS WARRANT. ANY CHANGES SHALL BE DOCUMENTED AND SUPERCEDE THESE PLANS.
- 10. OPEN TRENCH: THE CONTRACTOR SHALL PLACE "OPEN TRENCH" SIGNS (C27(CA)) ON TYPE III BARRICADES WITHIN THE WORK ZONE, AHEAD OF MANY WORK AREA WHICH INCLUDES THE EXCESS OF THREE (3) INCHES IN DEPTH, PER CA MUTCD SECTION 6F.103 (CA) GUIDELINES.
- 11. FOR WORK NOT COVERED BY THESE TRAFFIC CONTROL PLANS: THE CONTRACTOR SHALL PREPARE A TRAFFIC CONTROL WORKING DRAWINGS AND SUBMIT THEM TO THE CITY RESIDENT ENGINEER. THE CONTRACTOR SHALL ALLOW A MINIMUM OF TWENTY (20) WORKING DAYS FOR THE REVIEW OF THE WORKING DRAWINGS. UPON APPROVAL OF THE TRAFFIC CONTROL PLAN, THE PUBLIC WORKS TRAFFIC CONTROL SECTION WILL ISSUE A TRAFFIC CONTROL PLAN (TCP) PERMIT FOR THIS WORK.
- 12. CONTRACTOR SHALL INSTALL UNEVEN PAVEMENT SIGNS C46 (CA) ALONG THE EDGE OF THE AREAS WHERE A STEP OF GREATER THAN 2" EXISTS WHETHER PARALLEL OR PERPENDICULAR TO THE DIRECTION OF TRAVEL.
- 13. CONTRACTOR HAS THE OPTION TO WORK AT MULTIPLE LOCATIONS CONCURRENTLY. ADJACENT BLOCKS SHALL NOT BE CLOSED AT THE SAME TIME.
- 14. SEE TABLE 6H-3 IN THE CALIFORNIA MANUAL ON UNIFORM TRAFFIC CONTROL DEVICES (CA MUTCD) FOR MEANING OF LETTER CODES ON TYPICAL APPLICATION DIAGRAMS.
- 15. CONTRACTOR SHALL DEPLOY TEN (10) PORTABLE CHANGEABLE MESSAGE SYSTEMS (PCMS) THROUGHOUT CONSTRUCTION, WITH FINAL PLACEMENT TO BE DETERMINED BY ENGINEER.

NOTE: SPEED CATEGORY TO BE DETERMINED BY THE HIGHWAY AGENCY


TABLE 6H-3			
DOAD TYPE	DISTANCE BETWEEN SIGNS		
ROAD TYPE	А	В	С
URBAN (LOW SPEED)	100 FEET	100 FEET	100 FEET
URBAN (HIGH SPEED)	350 FEET	350 FEET	350 FEET
RURAL	500 FEET	500 FEET	500FEET
EXPRESS / FREEWAY	1000 FEET	1500 FEET	2640 FEET



ALL REFERENCES AND WRITTEN DIMENSIONS SHALL SUPERCEDE ALL SCALED DISTANCES AND SHALL BE VERIFIED IN THE FIELD. ANY DISCREPANCY SHALL BE BROUGHT TO THE ATTENTION OF THE ENGINEER PRIOR TO THE COMMENCEMENT OF WORK

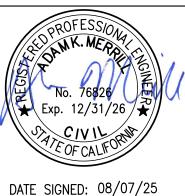



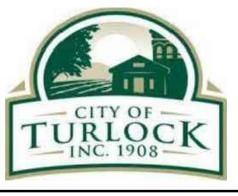


CITY OF TURLOCK MUNICIPAL SERVICES DEPARTMENT 156 S. BROADWAY, SUITE 150 (209) 668 - 5520

TRAFFIC CONTROL NOTES I

PROJECT NO. 23-069 CITY OF TURLOCK ROADS PROGRAM

VERIFY SCALE DRAWN BY: JR DRAV	wing no.
O 1" REV. BY: AKM	
CH. BY: AKM	101
DATE: 8/7/2025	101
SCALE: SEE SHEET SHEE	. T•
	01 OF 117

VERIFY

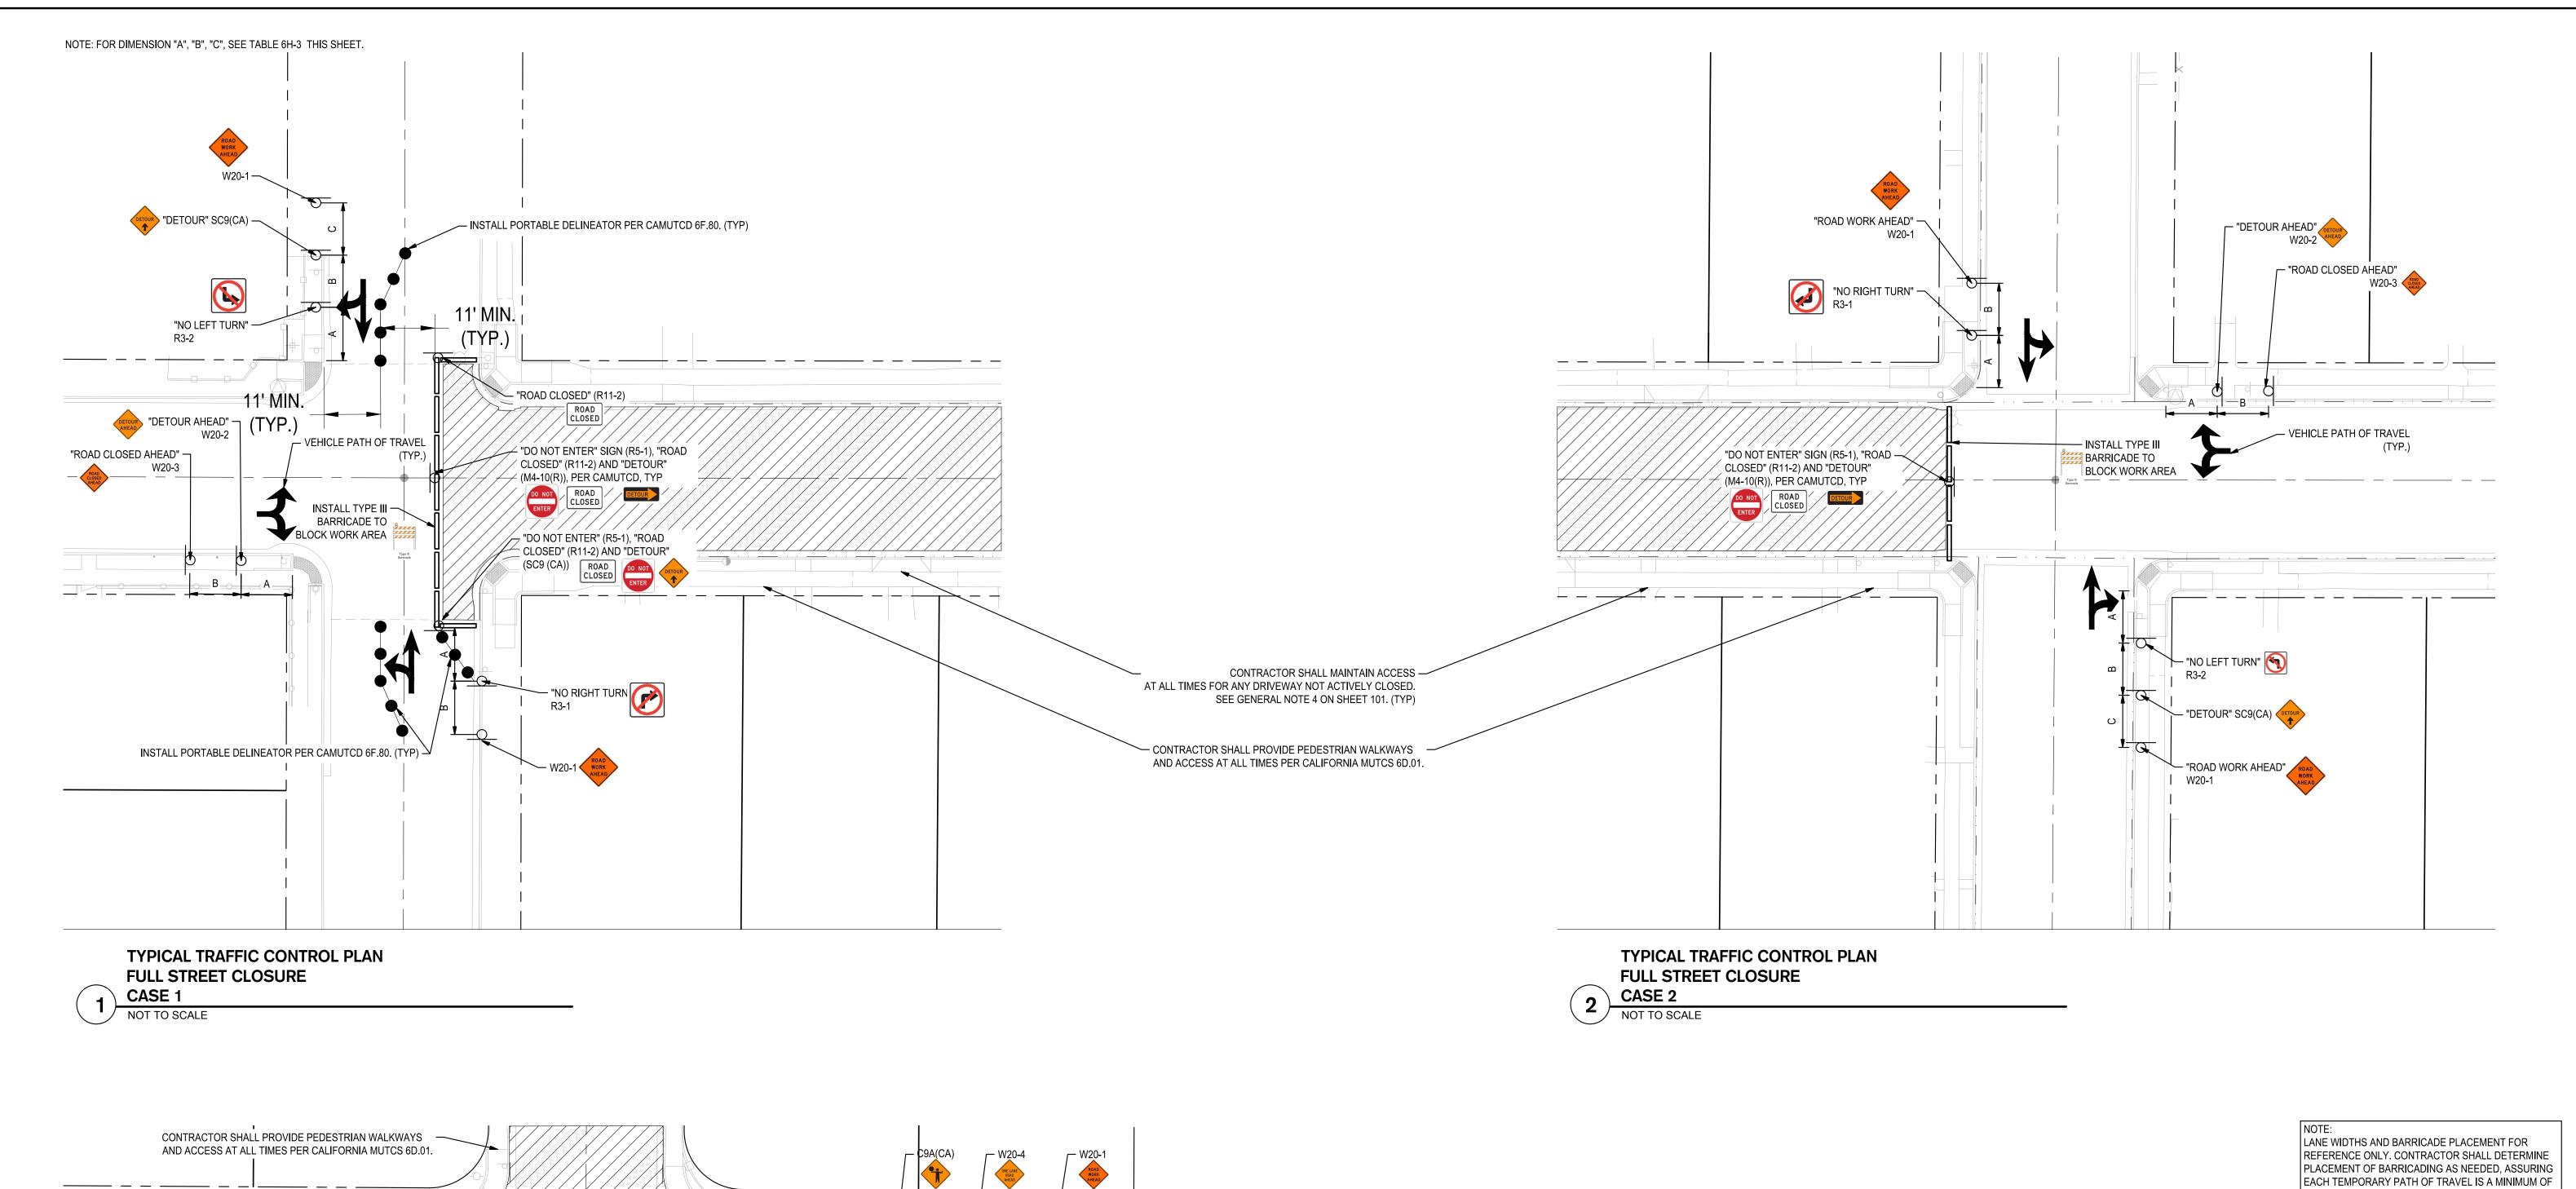


"ROAD CLOSED" (R11-2) VEHICLE PATH OF TRAVEL -— INSTALL PORTABLE DELINEATOR PER CAMUTCD 6F.80. (TYP) - "ROAD CLOSED" (R11-2) ROAD CLOSED 11' MIN.

TYPICAL TRAFFIC CONTROL PLAN **FULL STREET CLOSURE**


A/2

CASE 3 NOT TO SCALE NOTE: SPEED CATEGORY TO BE DETERMINED BY THE HIGHWAY AGENCY TABLE 6H-3


DISTANCE BETWEEN SIGNS **ROAD TYPE** С URBAN (LOW SPEED) 100 FEET 100 FEET 100 FEET URBAN (HIGH SPEED) 350 FEET 350 FEET 350 FEET RURAL 500 FEET 500 FEET 500FEET EXPRESS / FREEWAY 1500 FEET 2640 FEET 1000 FEET

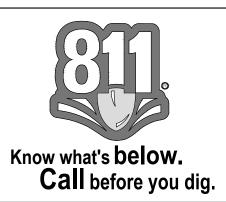

ALL REFERENCES AND WRITTEN DIMENSIONS SHALL SUPERCEDE ALL SCALED DISTANCES AND SHALL BE VERIFIED IN THE FIELD. ANY DISCREPANCY SHALL BE BROUGHT TO THE ATTENTION OF THE ENGINEER PRIOR TO THE COMMENCEMENT OF WORK

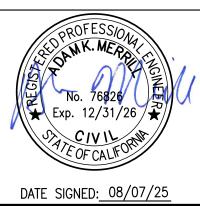




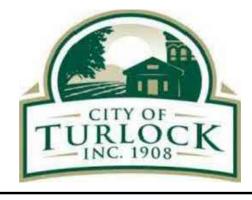

CITY OF TURLOCK MUNICIPAL SERVICES DEPARTMENT 156 S. BROADWAY, SUITE 150 (209) 668 - 5520

TRAFFIC CONTROL DETAILS

verify scale	DRAWN BY: JR	DRAWING NO.
0 1"	REV. BY: AKM	
	CH. BY: AKM	102
	DATE: 8/7/2025	102
	SCALE: SEE SHEET	SHEET:
	SEI PROJ NO: 22157	102 OF117

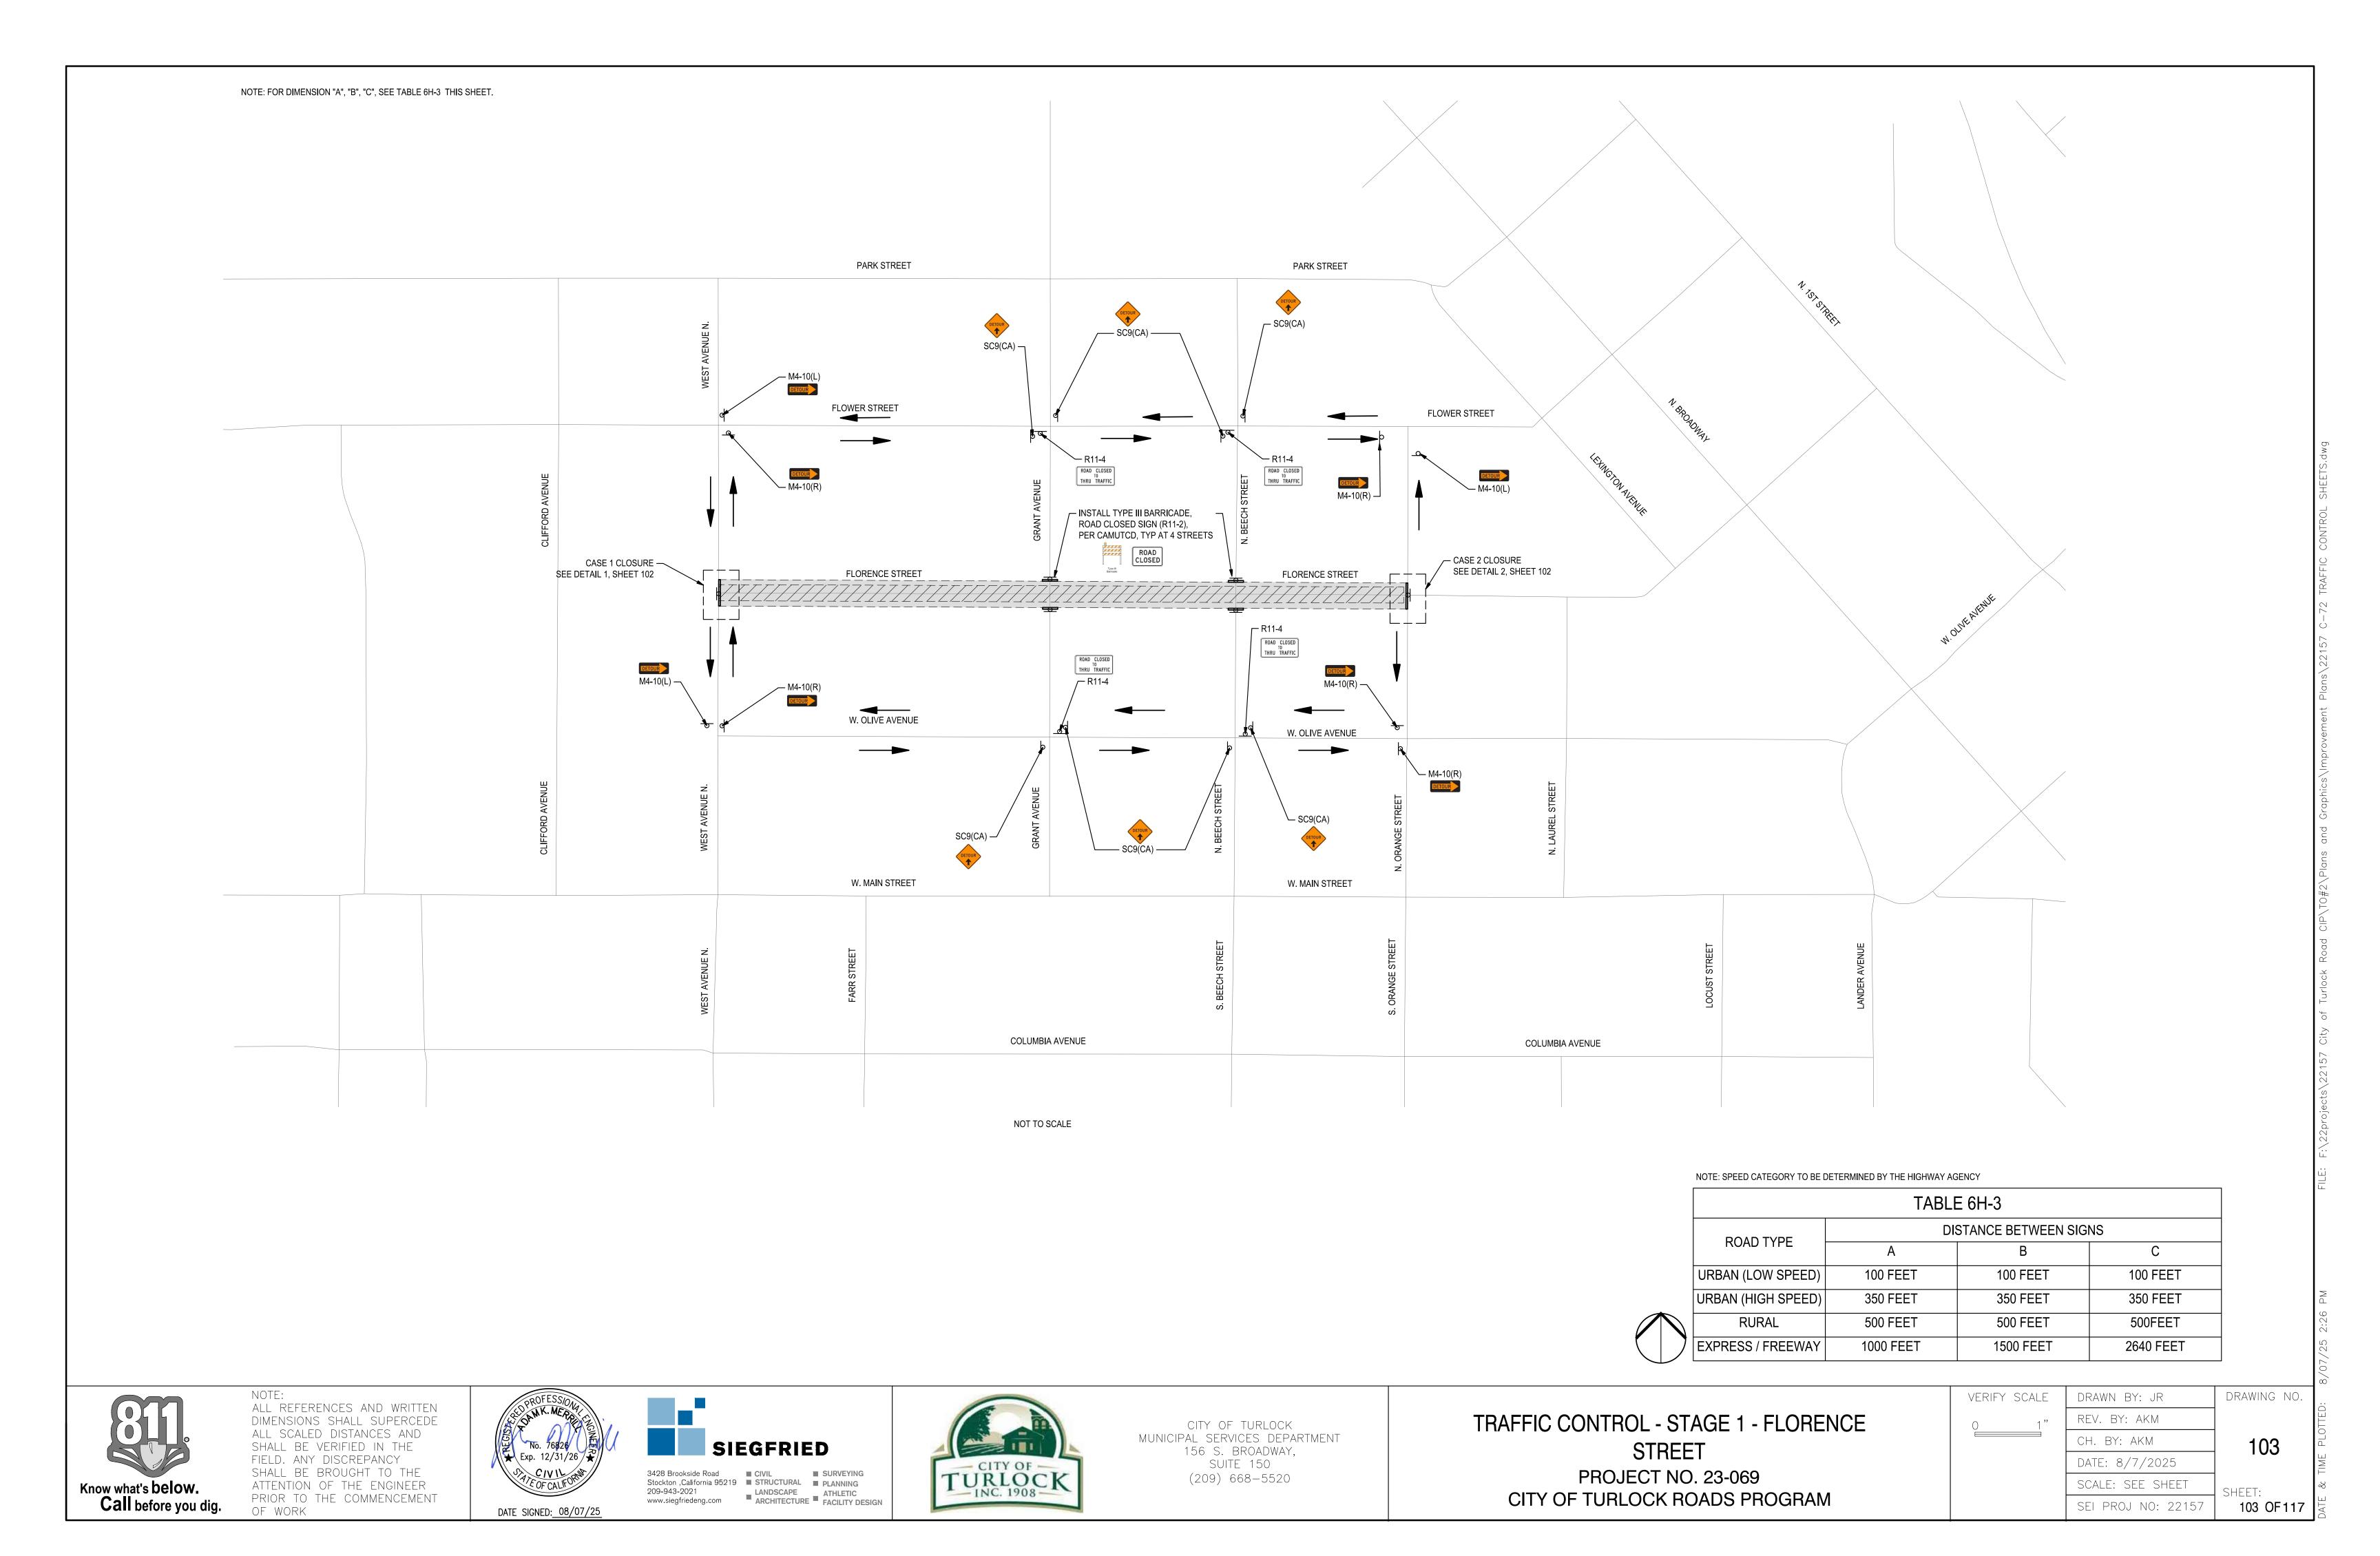


Know what's below.

Call before you dig.

ALL REFERENCES AND WRITTEN
DIMENSIONS SHALL SUPERCEDE
ALL SCALED DISTANCES AND
SHALL BE VERIFIED IN THE
FIELD. ANY DISCREPANCY
SHALL BE BROUGHT TO THE
ATTENTION OF THE ENGINEER PRIOR TO THE COMMENCEMENT OF WORK






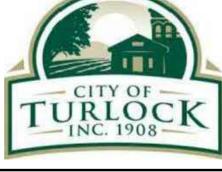

CITY OF TURLOCK
MUNICIPAL SERVICES DEPARTMENT
156 S. BROADWAY,
SUITE 150 (209) 668-5520

TRAFFIC CONTROL - STAGE 2 - FLORENCE STREET PROJECT NO. 23-069 CITY OF TURLOCK ROADS PROGRAM

VERIFY SCALE	DRAWN BY: JR	DRAWING NO.
0 1"	REV. BY: AKM	
	CH. BY: AKM	104
	DATE: 8/7/2025	
	SCALE: SEE SHEET	SHEET:
	SEI PROJ NO: 22157	104 OF117

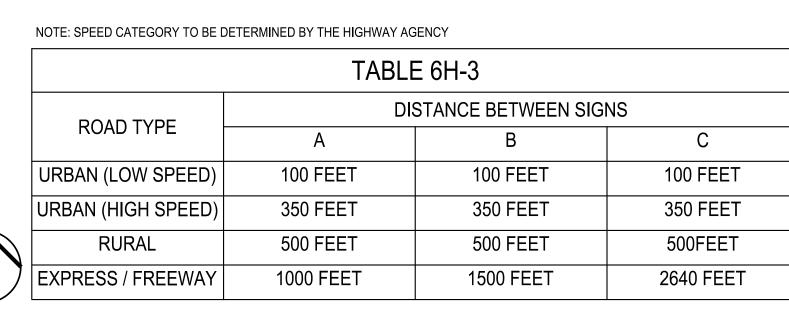


NOTE: SPEED CATEGORY TO BE DE	ETERMINED BY THE HIGHWAY A	GENCY	
	TABL	E 6H-3	
DOAD TYPE	D	ISTANCE BETWEEN SIG	NS
ROAD TYPE	А	В	С
URBAN (LOW SPEED)	100 FEET	100 FEET	100 FEE
URBAN (HIGH SPEED)	350 FEET	350 FEET	350 FEE
RURAL	500 FEET	500 FEET	500FEE
EXPRESS / FREEWAY	1000 FEET	1500 FEET	2640 FE

					N. To. S. P. R. R. L.
		PARK STREET			PARK STREET M4-10(R) M4-10(L)
	WEST AVENUE N.	FLOWER STREET			SC9(CA) RIAD (LUSSE) THE TRAFFIC SC9(CA) ROAD (LUSSE) THE TRAFFIC SC9(CA) ROAD (LUSSE) THE TRAFFIC SC9(CA) ROAD (LUSSE) THE TRAFFIC
CLIFFORD AVENUE		FLORENCE STREET	GRANT AVENUE	N. BEECH STREET	CASE 2 CLOSURE SEE DETAIL 2, SHEET 102 FLORENCE STREET TO SUBJECT 102 FLORENCE STREET FLORENCE STREET
		W. OLIVE AVENUE			W. OLIVE AVENUE
CLIFFORD AVENUE	WEST AVENUE N.		GRANT AVENUE	N. BEECH STREET	CASE 2 CLOSURE SEE DETAIL 2, SHEET 102 NOWANGE STEELS SCO(CA) NOWANGE STEELS SCO(CA)
		W. MAIN STREET			W. MAIN STREET
	WEST AVENUE N.	FARR STREET		S. BEECH STREET	S. ORANGE STREET LOCUST STREET
			COLUMBIA AVENUE		COLUMBIA AVENUE

NOTE: FOR DIMENSION "A", "B", "C", SEE TABLE 6H-3 THIS SHEET.

NOT TO SCALE

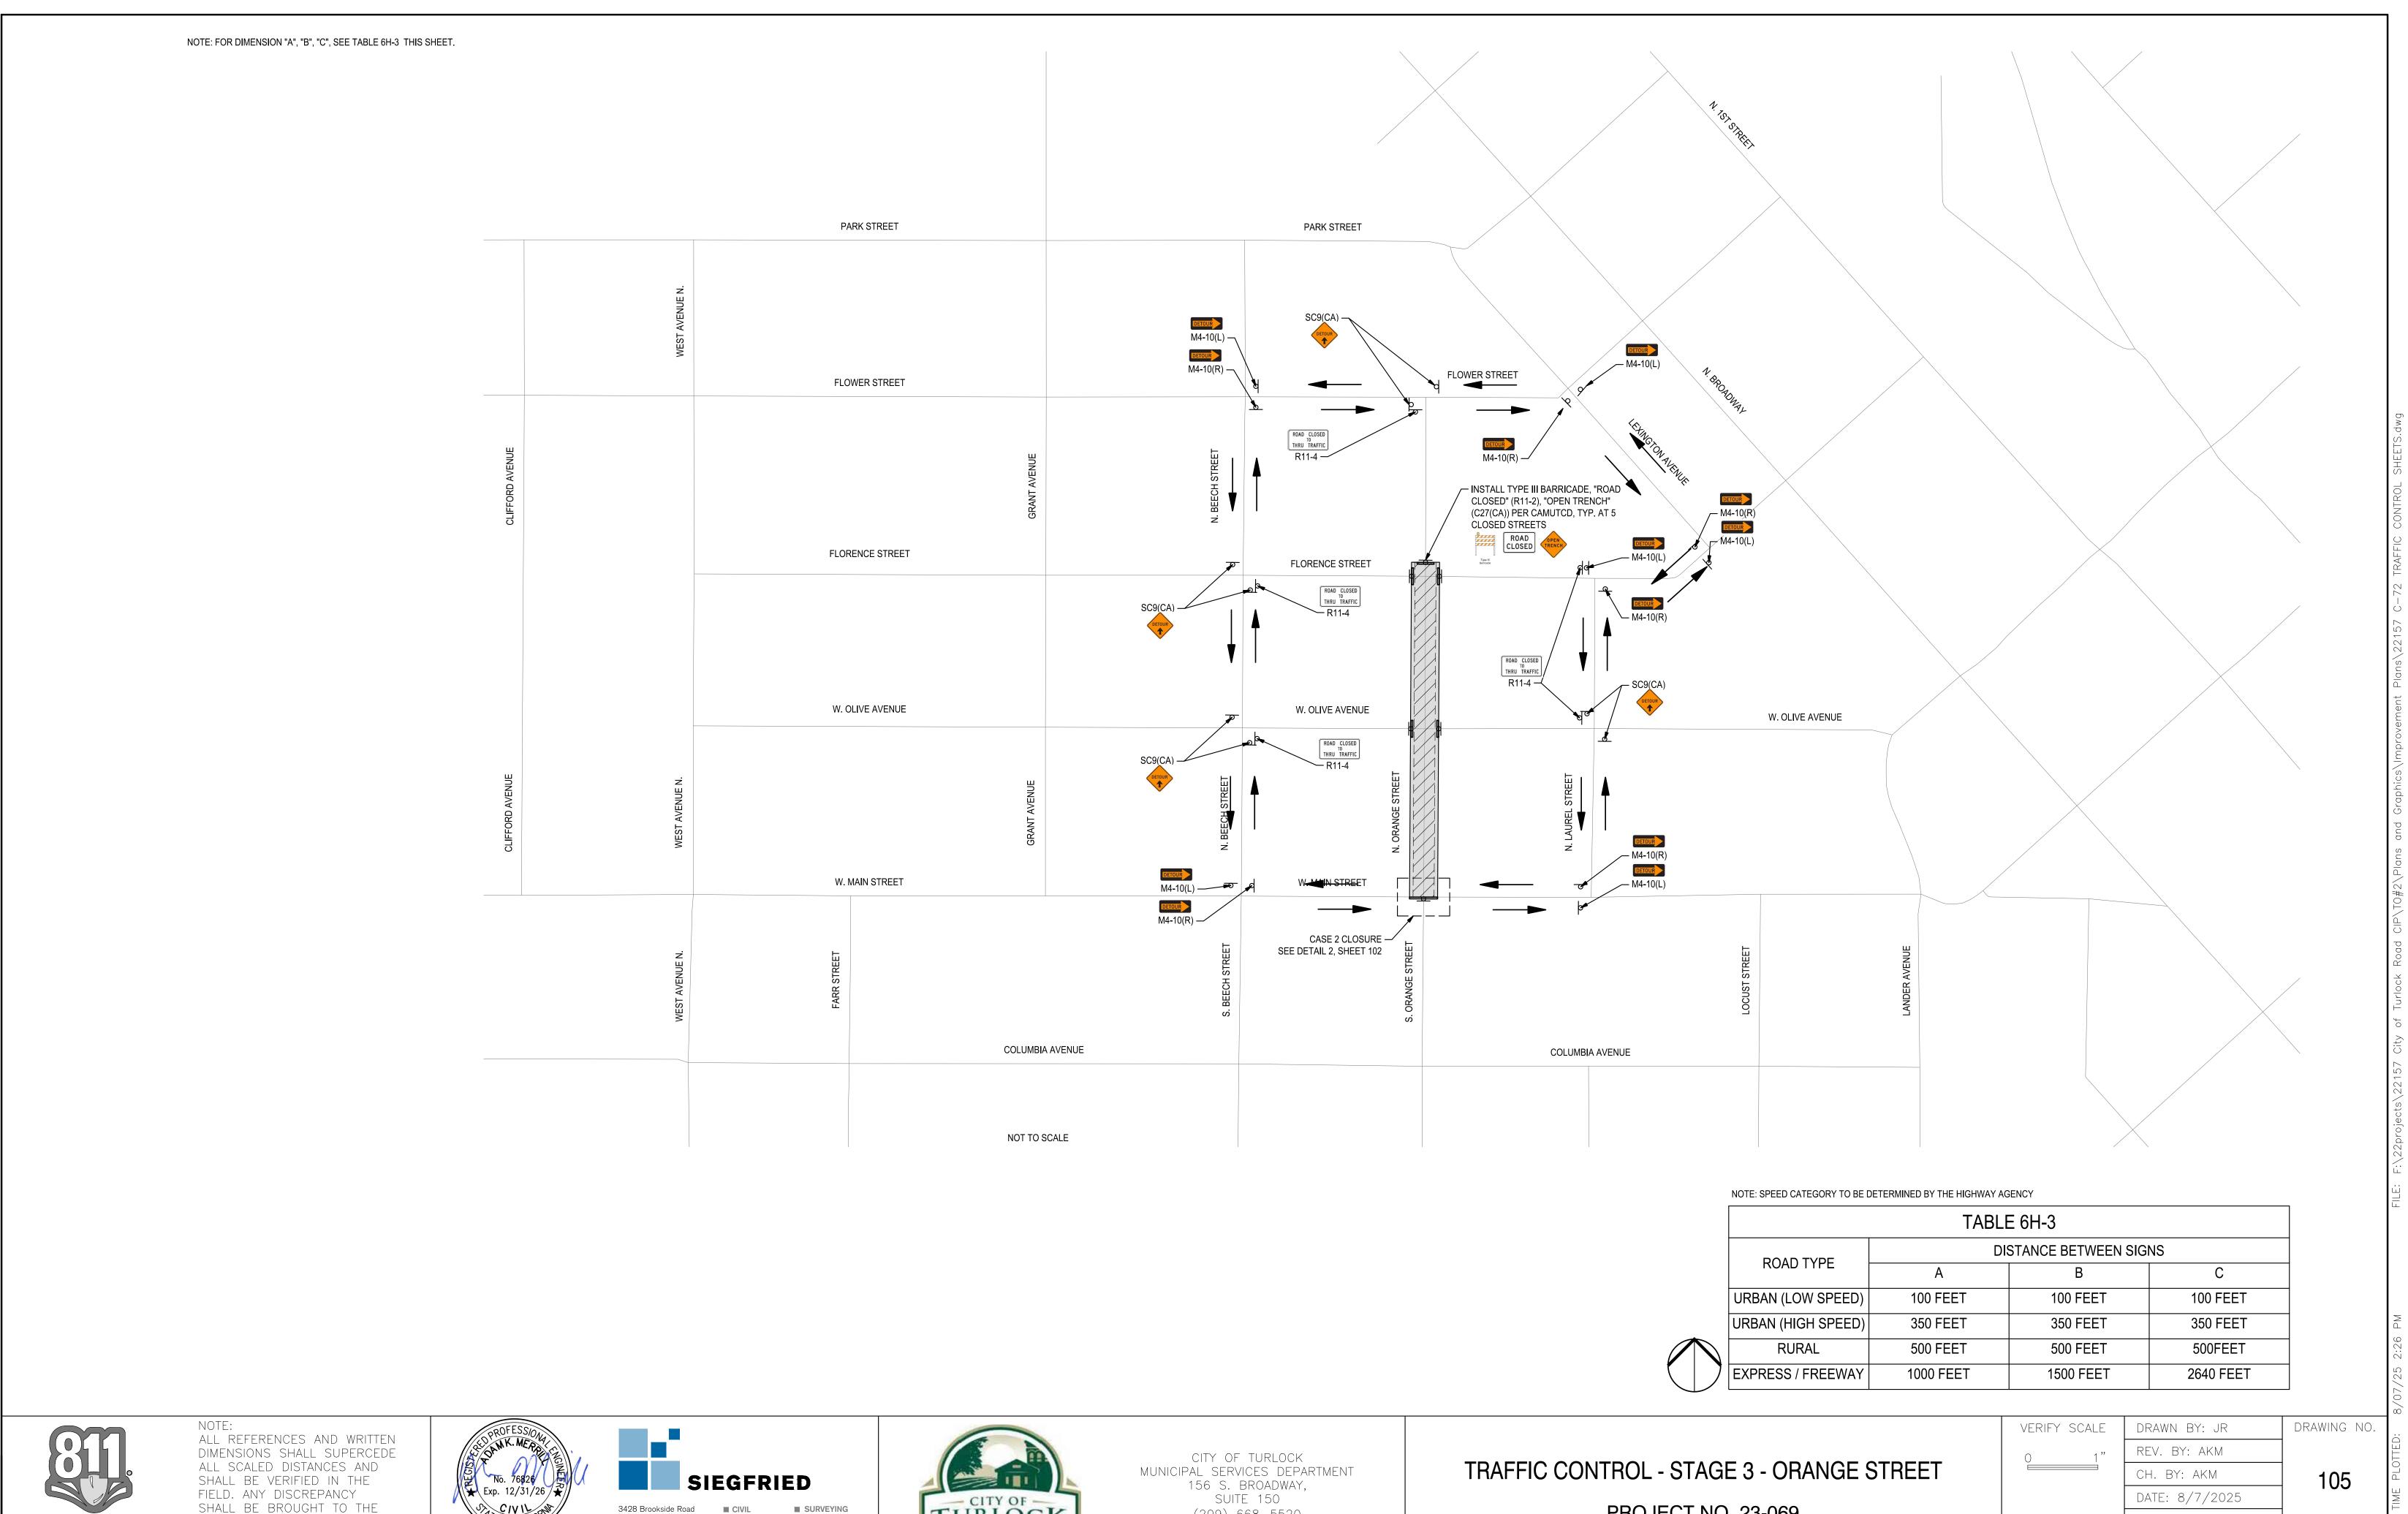


Know what's **below. Call** before you dig.

ATTENTION OF THE ENGINEER PRIOR TO THE COMMENCEMENT OF WORK






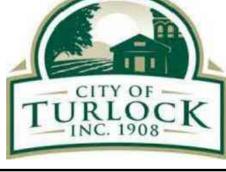



(209) 668-5520


PROJECT NO. 23-069

DRAWING NO.	DRAWN BY: JR	RIFY SCALE
	REV. BY: AKM	1 "
105	CH. BY: AKM	
	DATE: 8/7/2025	
SHFFT:	SCALE: SEE SHEET	
105 OF117	SEI PROJ NO: 22157	
•		

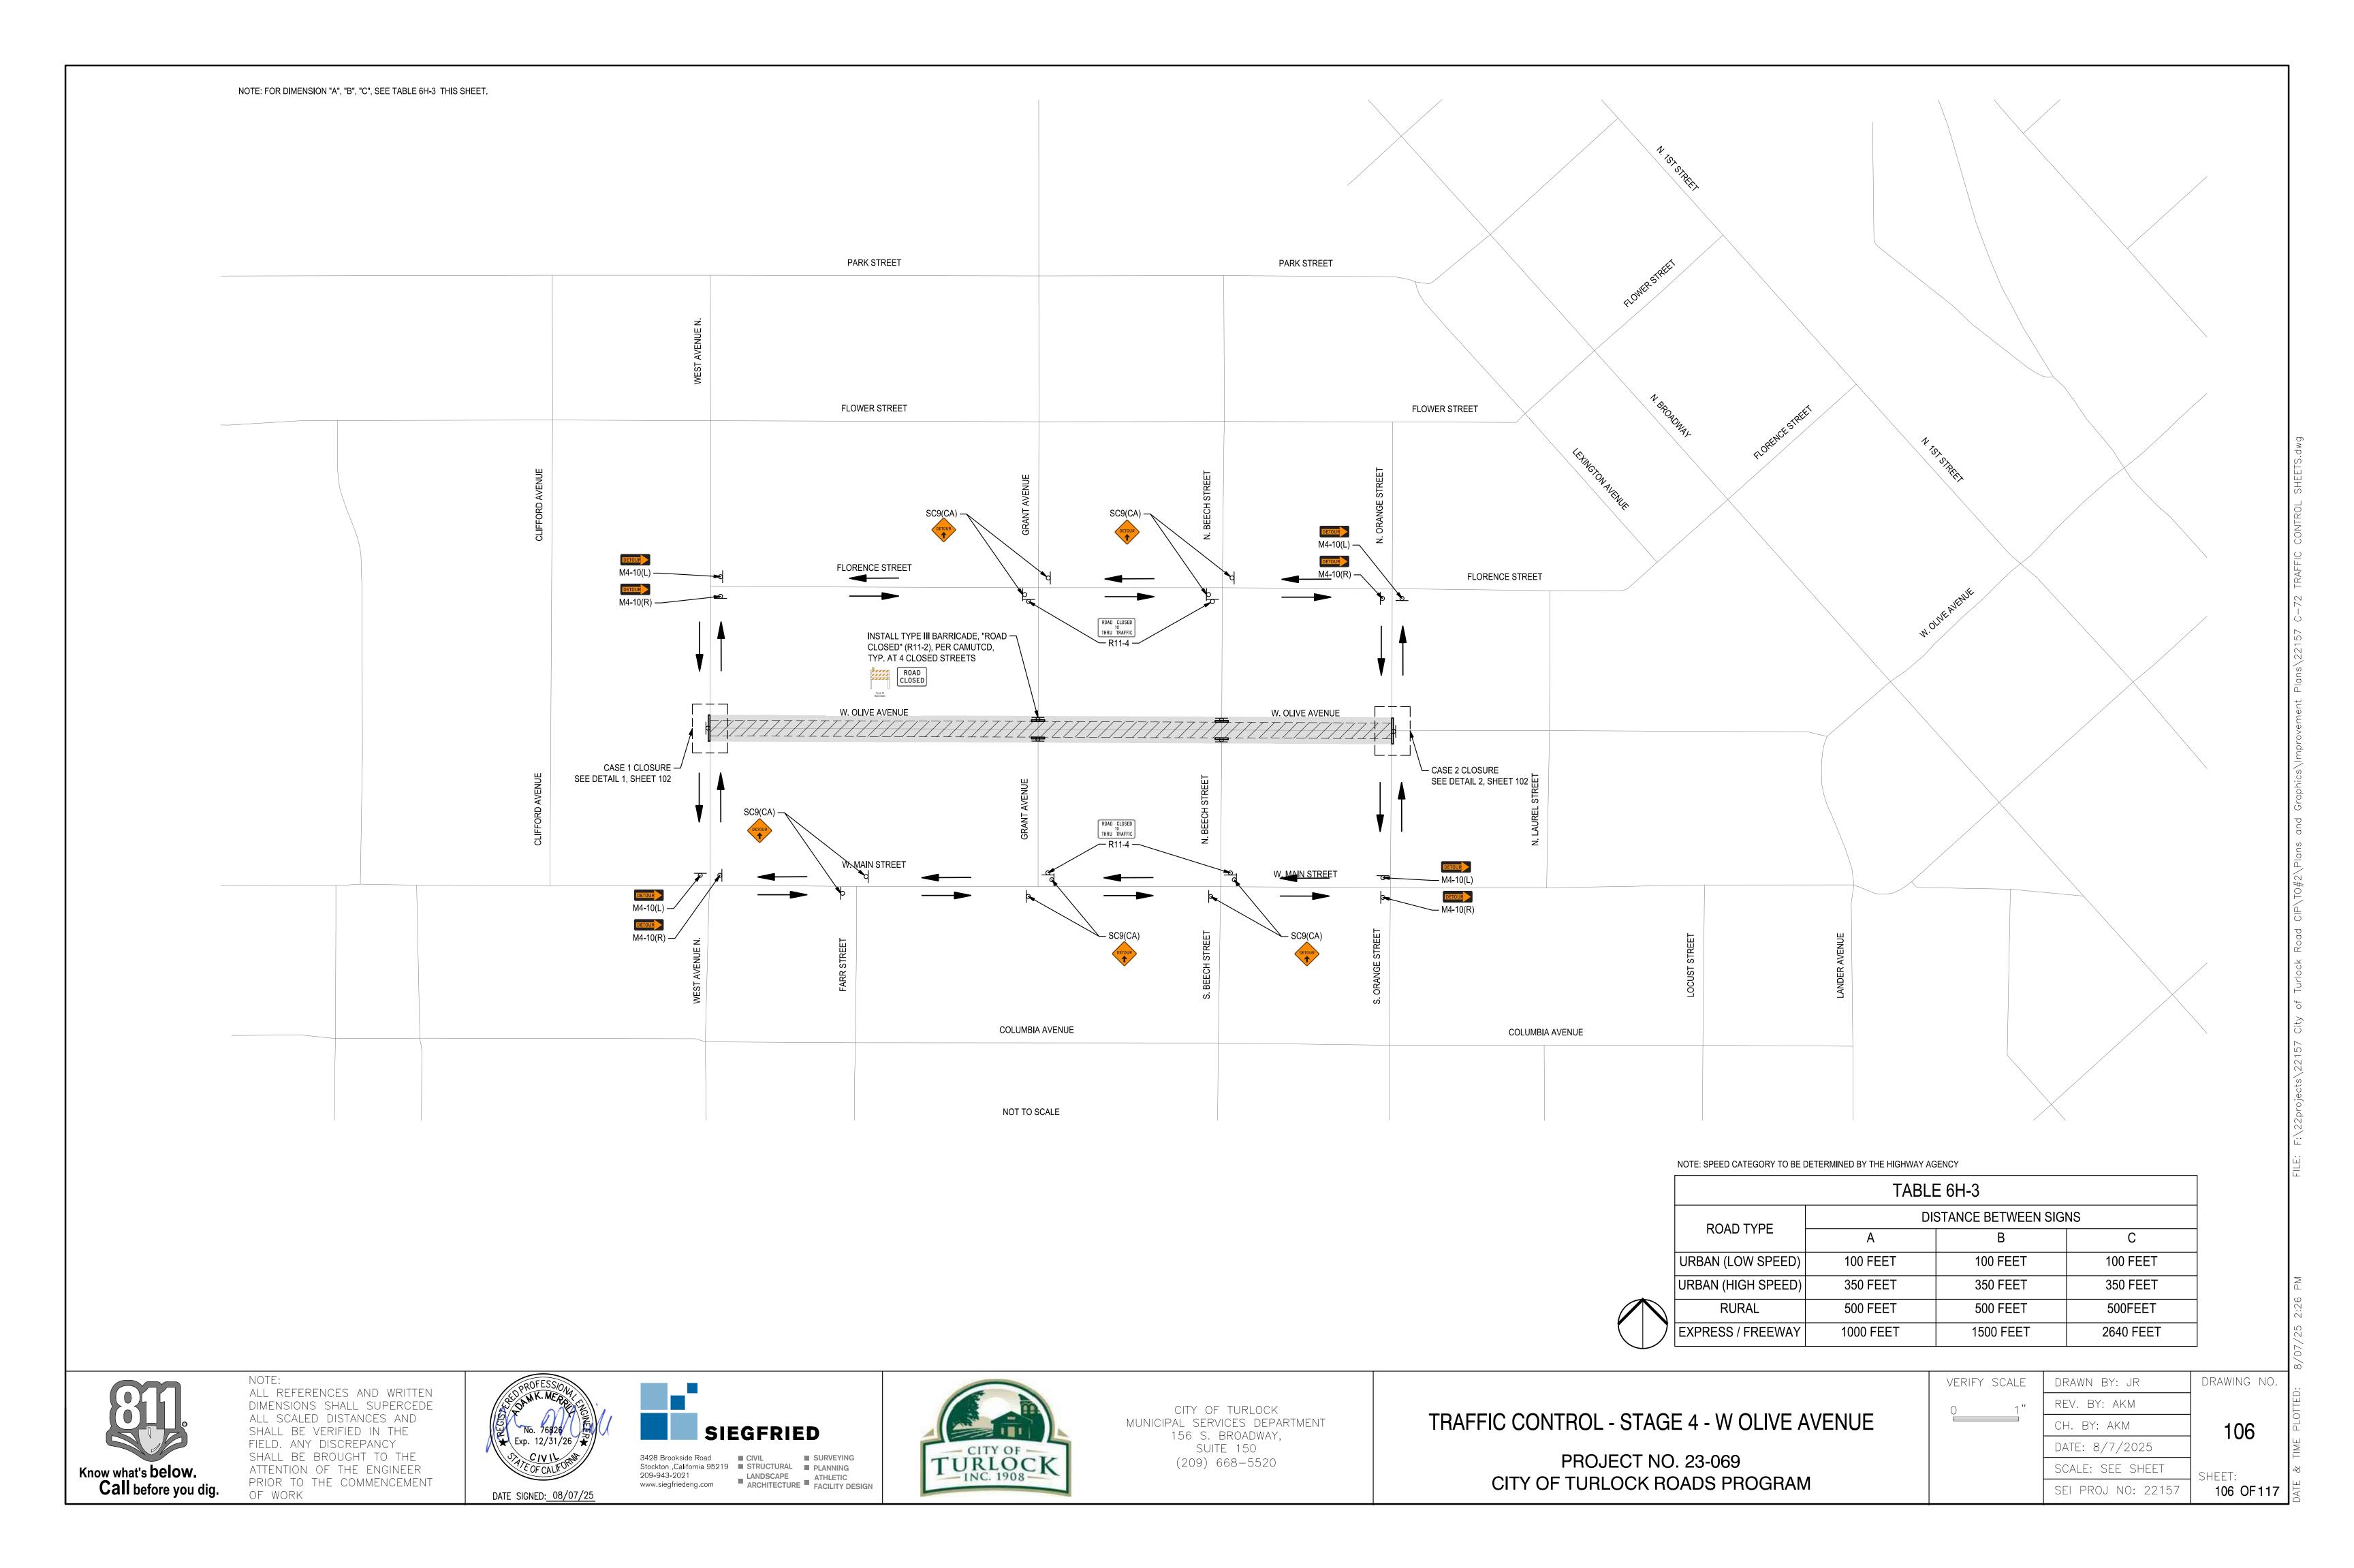

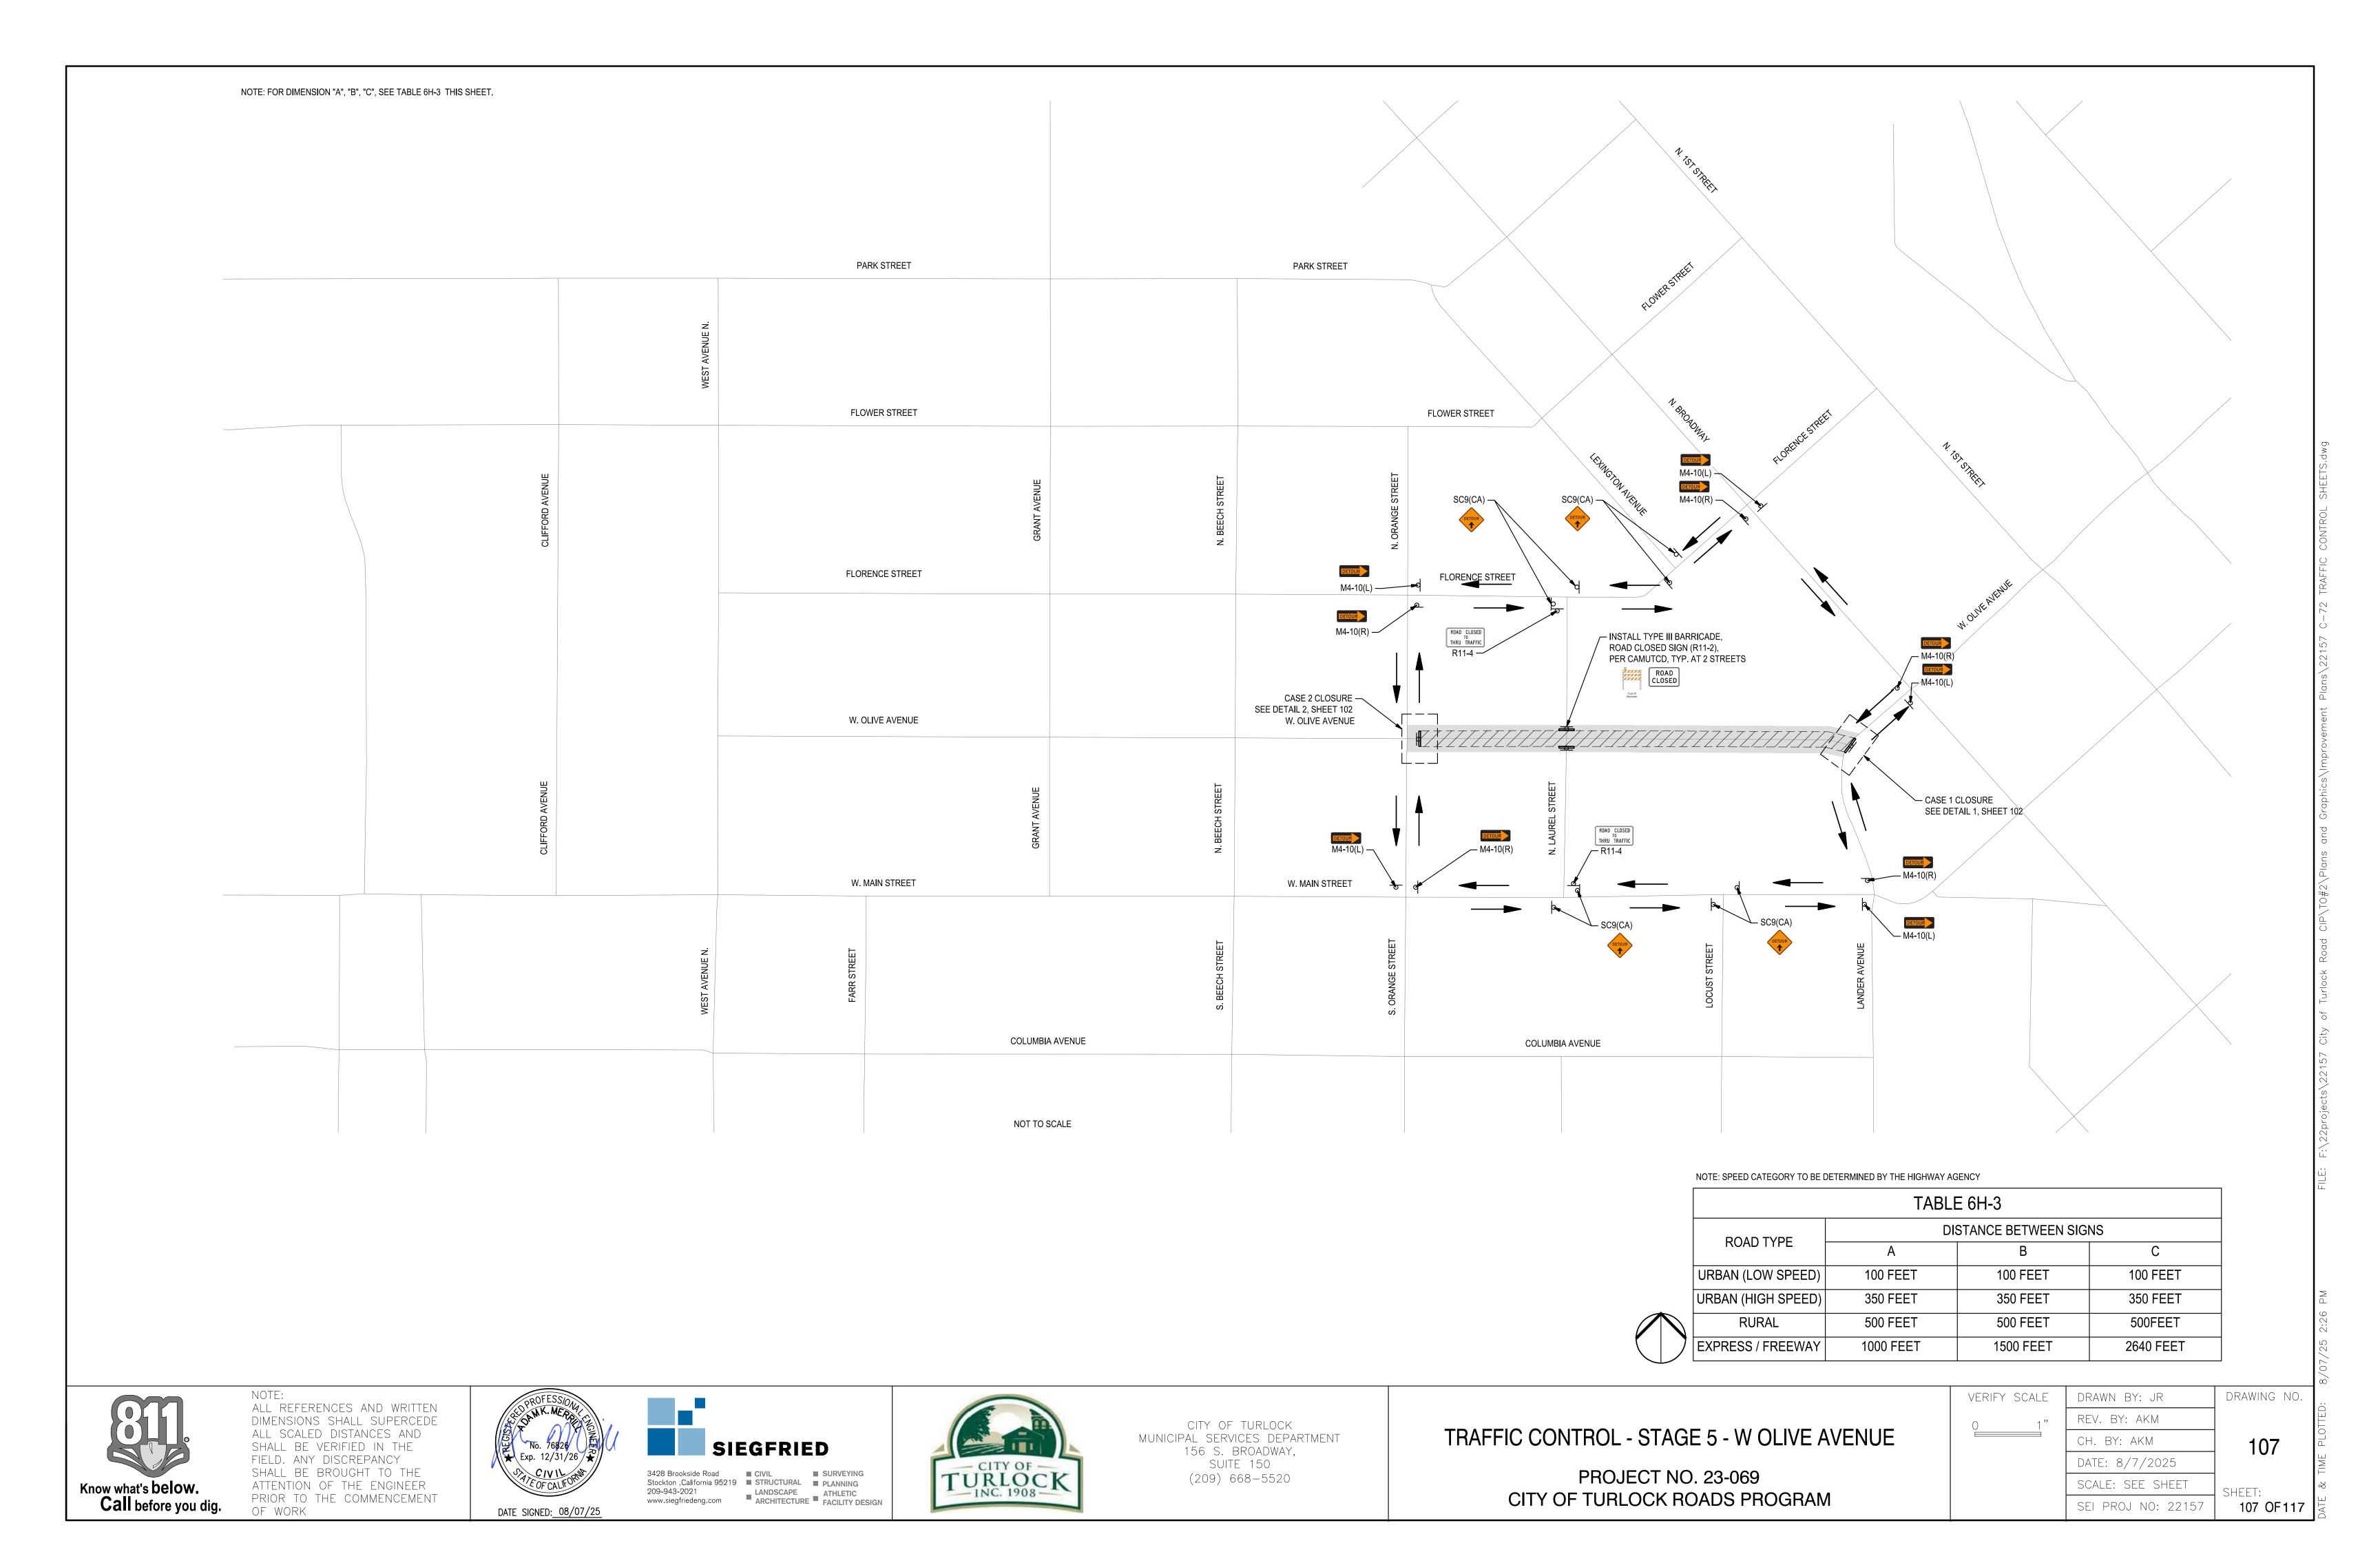


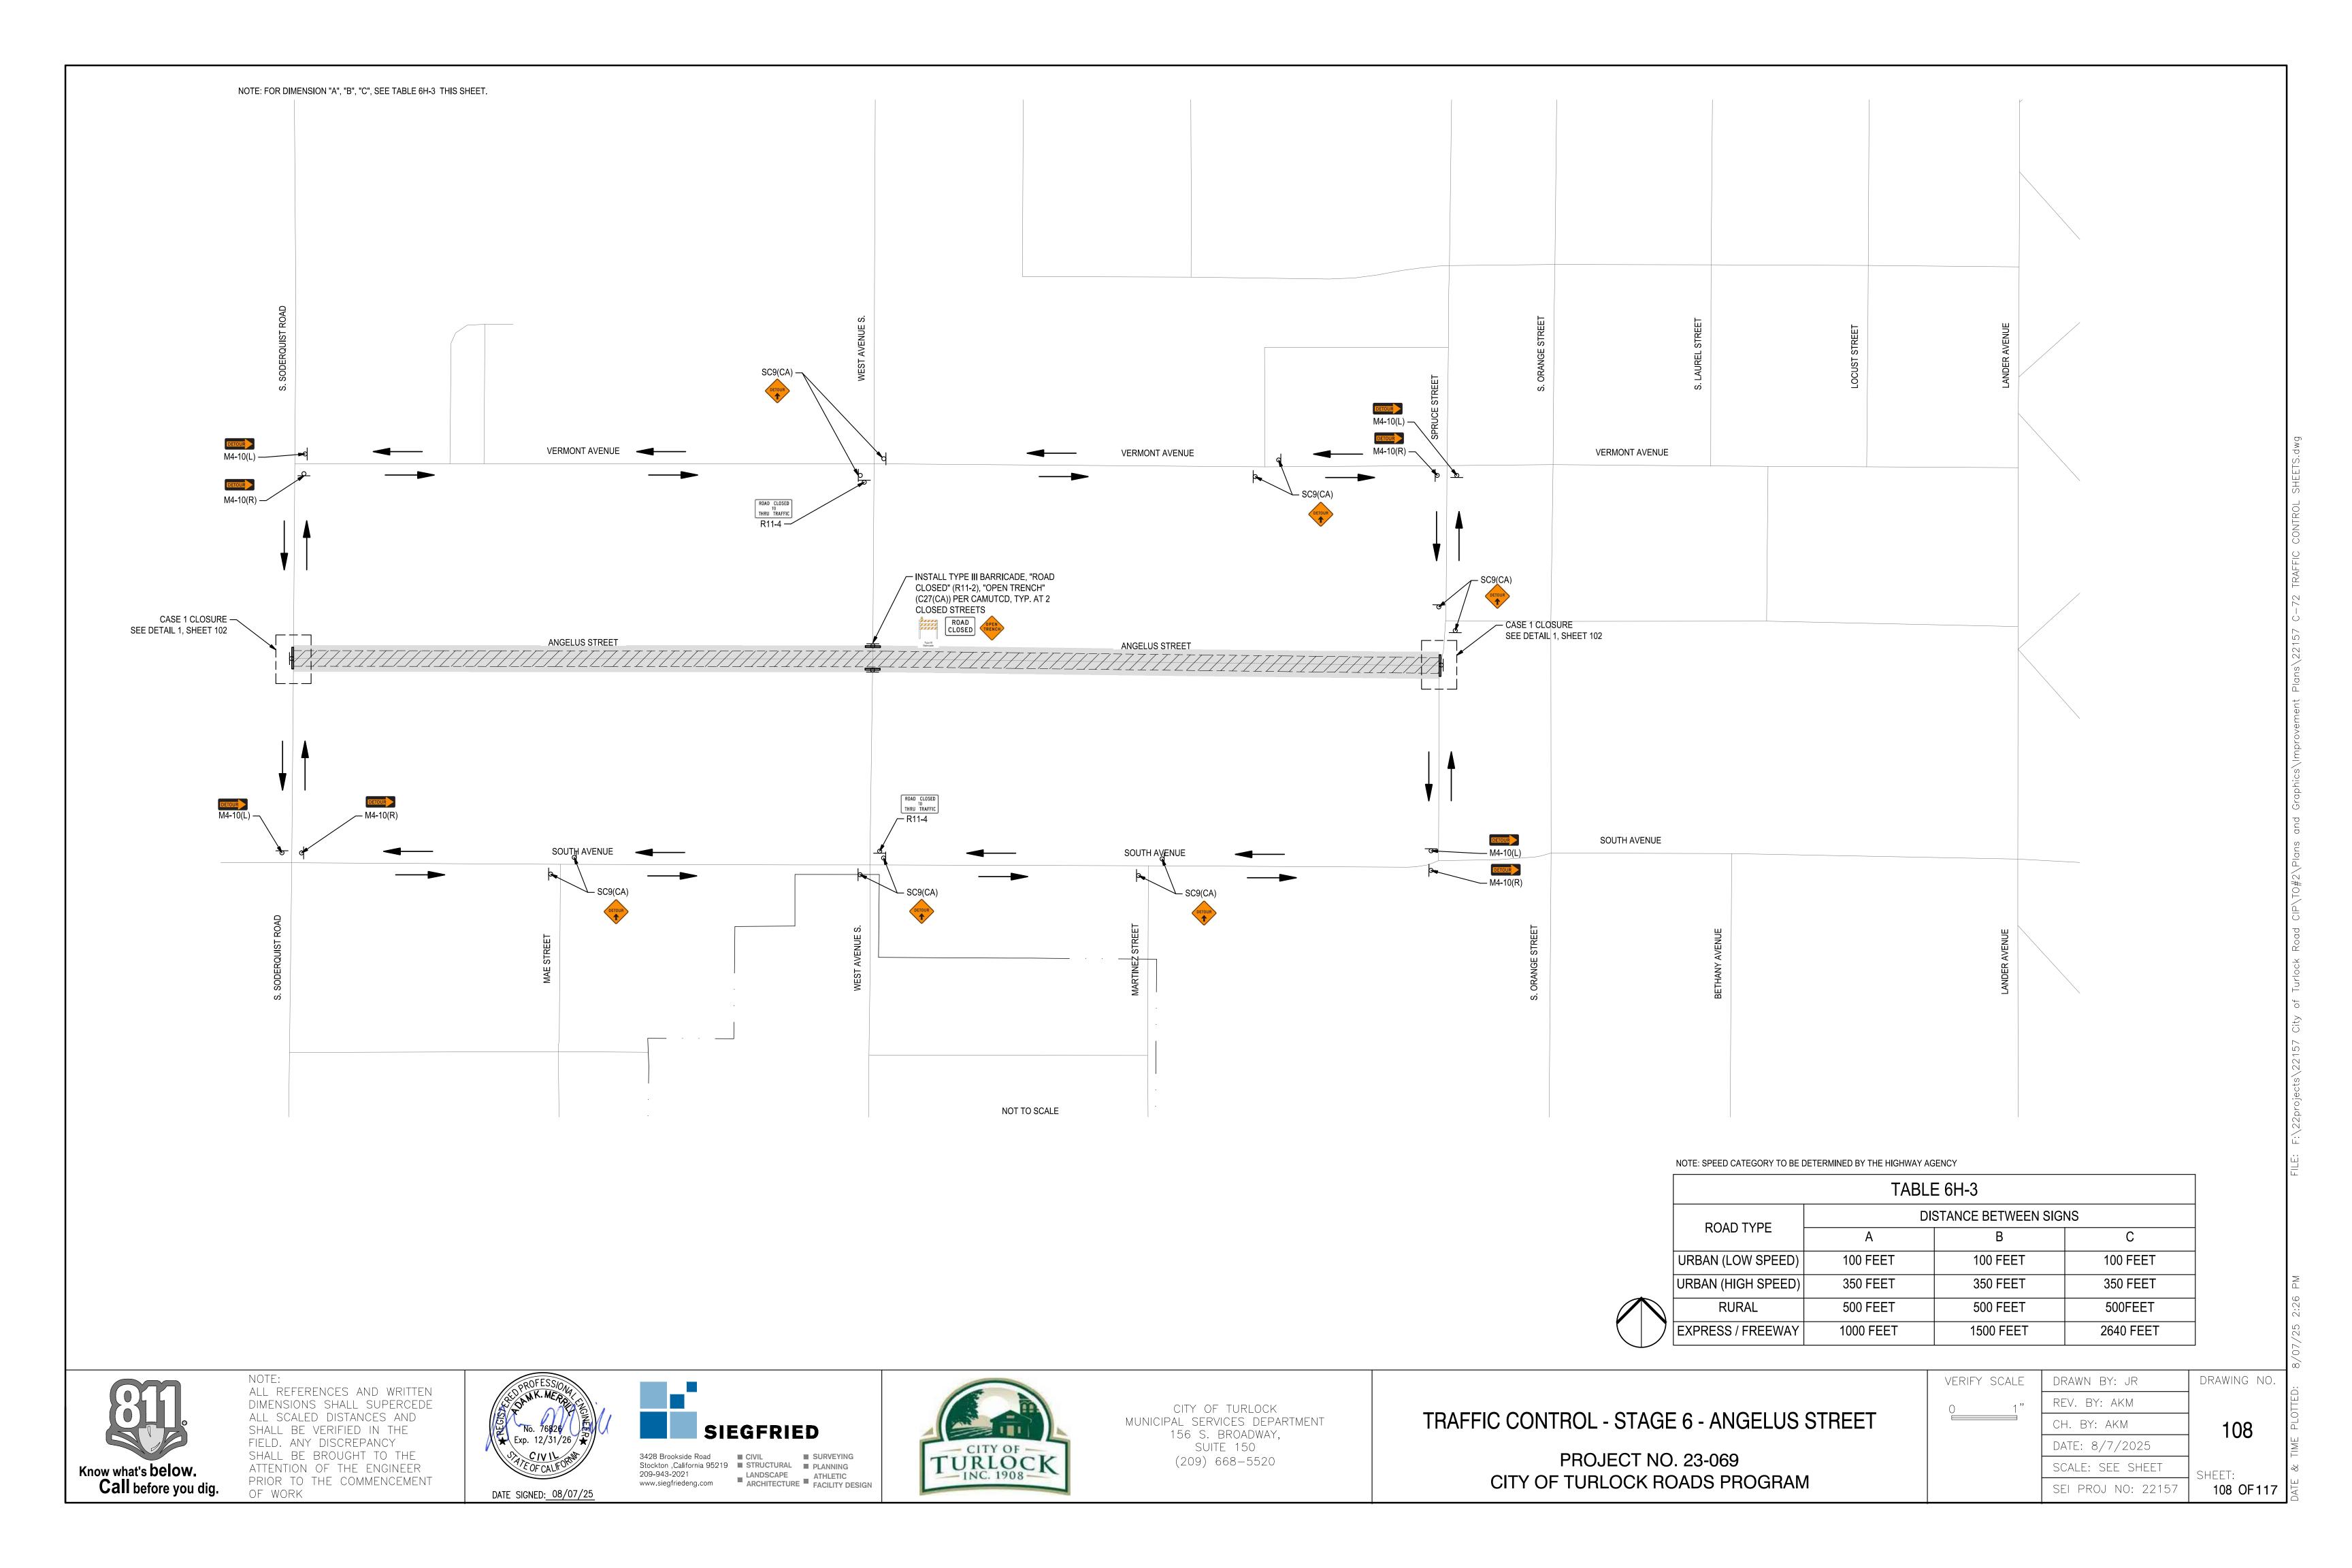

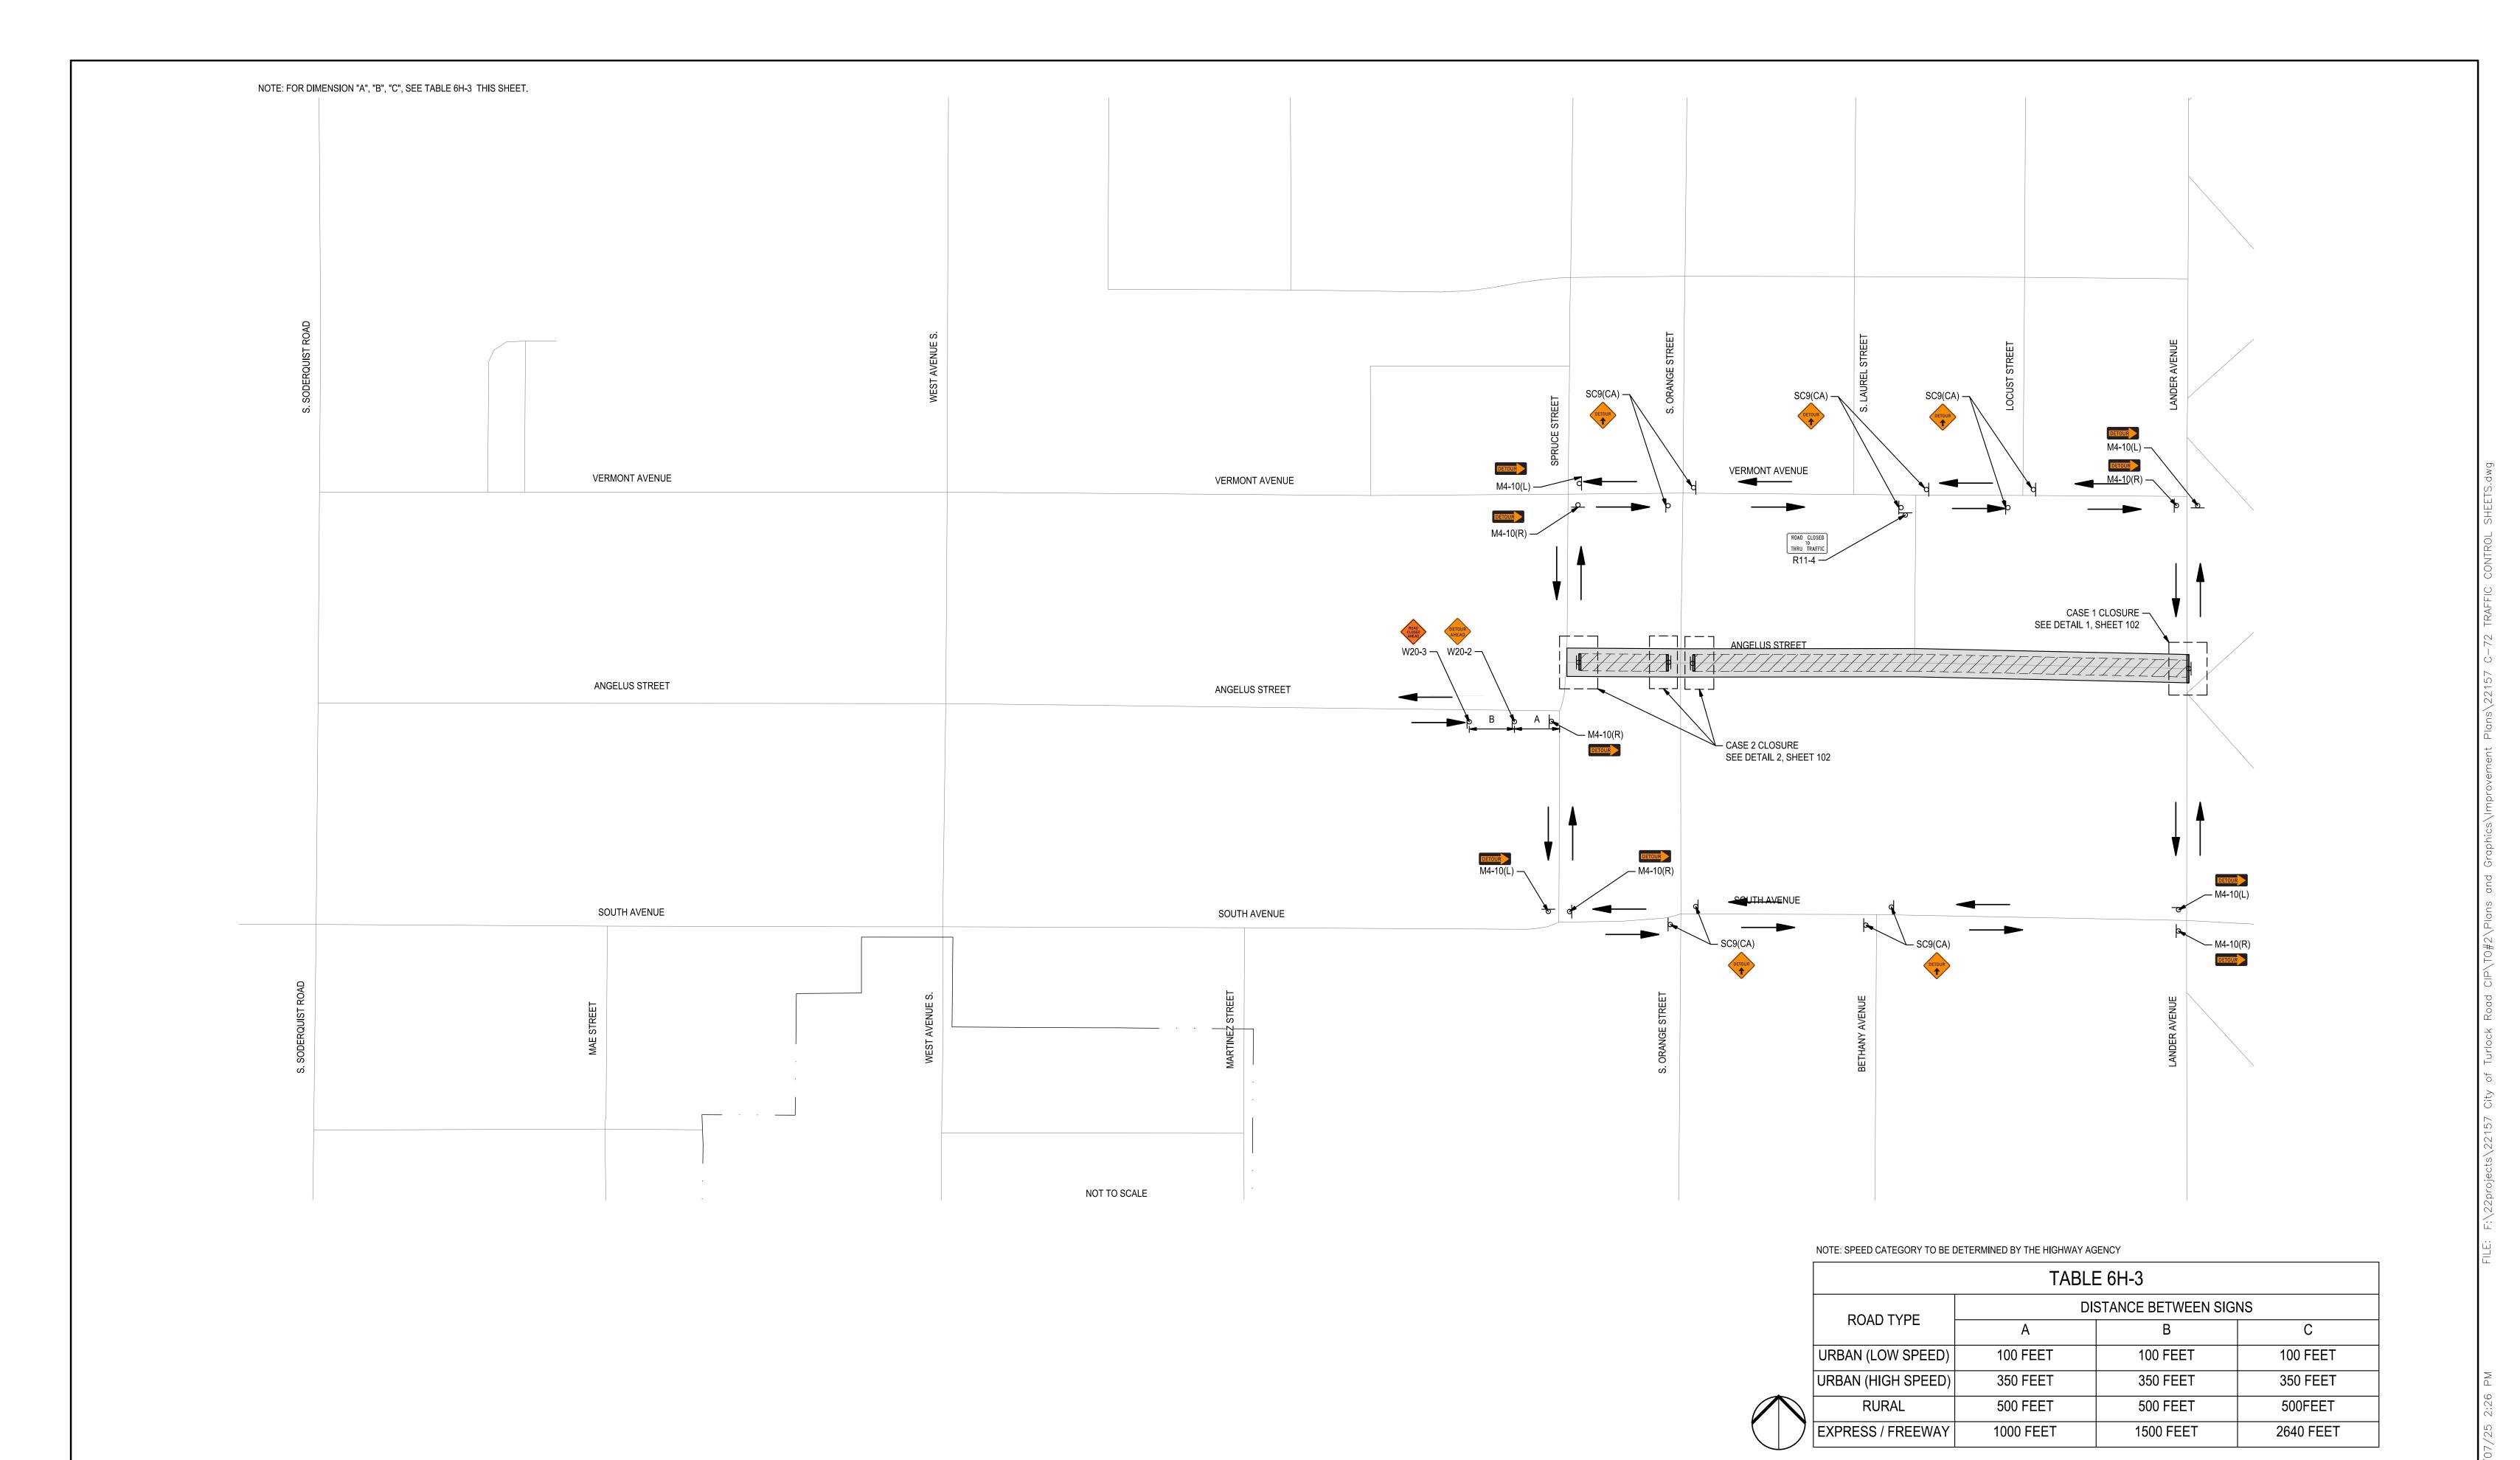


Know what's **below. Call** before you dig.

ALL REFERENCES AND WRITTEN DIMENSIONS SHALL SUPERCEDE ALL SCALED DISTANCES AND SHALL BE VERIFIED IN THE FIELD. ANY DISCREPANCY SHALL BE BROUGHT TO THE ATTENTION OF THE ENGINEER PRIOR TO THE COMMENCEMENT OF WORK

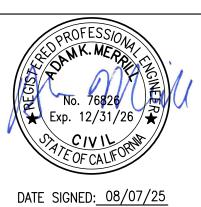



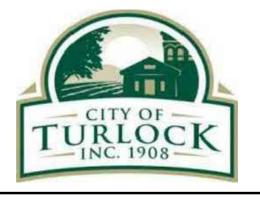



CITY OF TURLOCK MUNICIPAL SERVICES DEPARTMENT 156 S. BROADWAY, SUITE 150 (209) 668-5520


PROJECT NO. 23-069

RIFY SCALE	DRAWN BY: JR	drawing no.
1 "	REV. BY: AKM	
	CH. BY: AKM	109
	DATE: 8/7/2025	
	SCALE: SEE SHEET	SHEET:
	SEI PROJ NO: 22157	109 OF117

TRAFFIC CONTROL - STAGE 7 - ANGELUS STREET

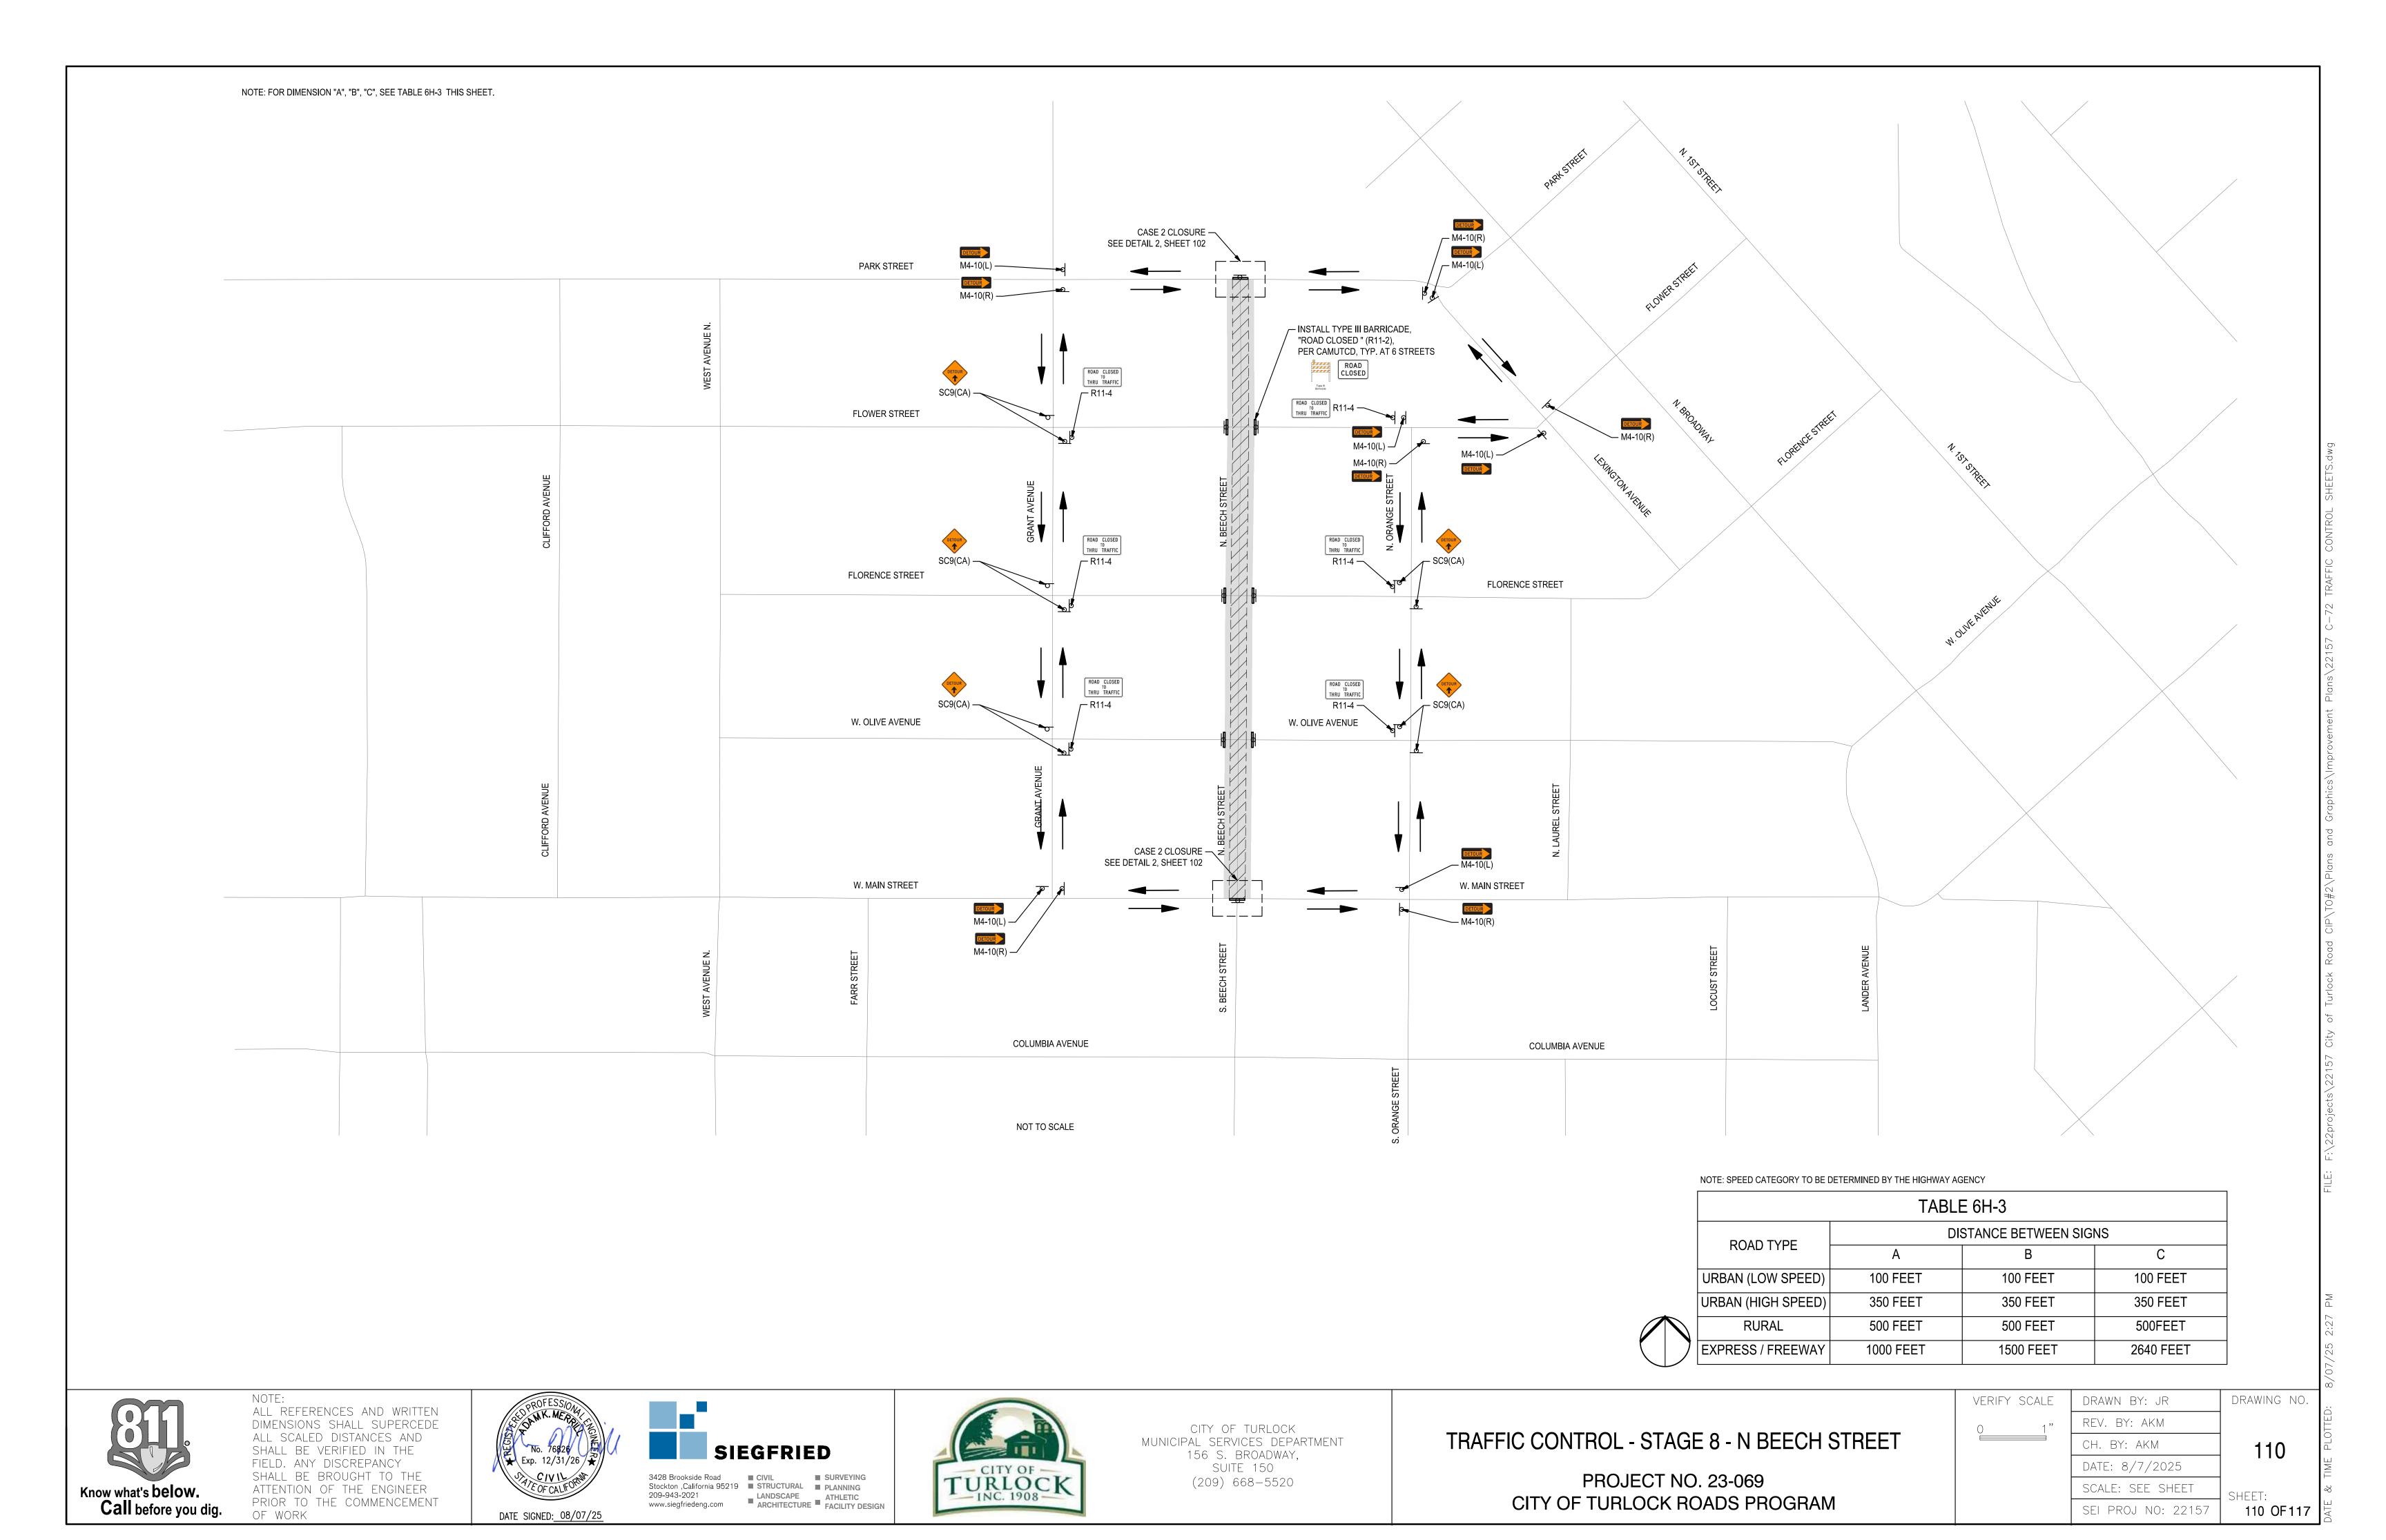

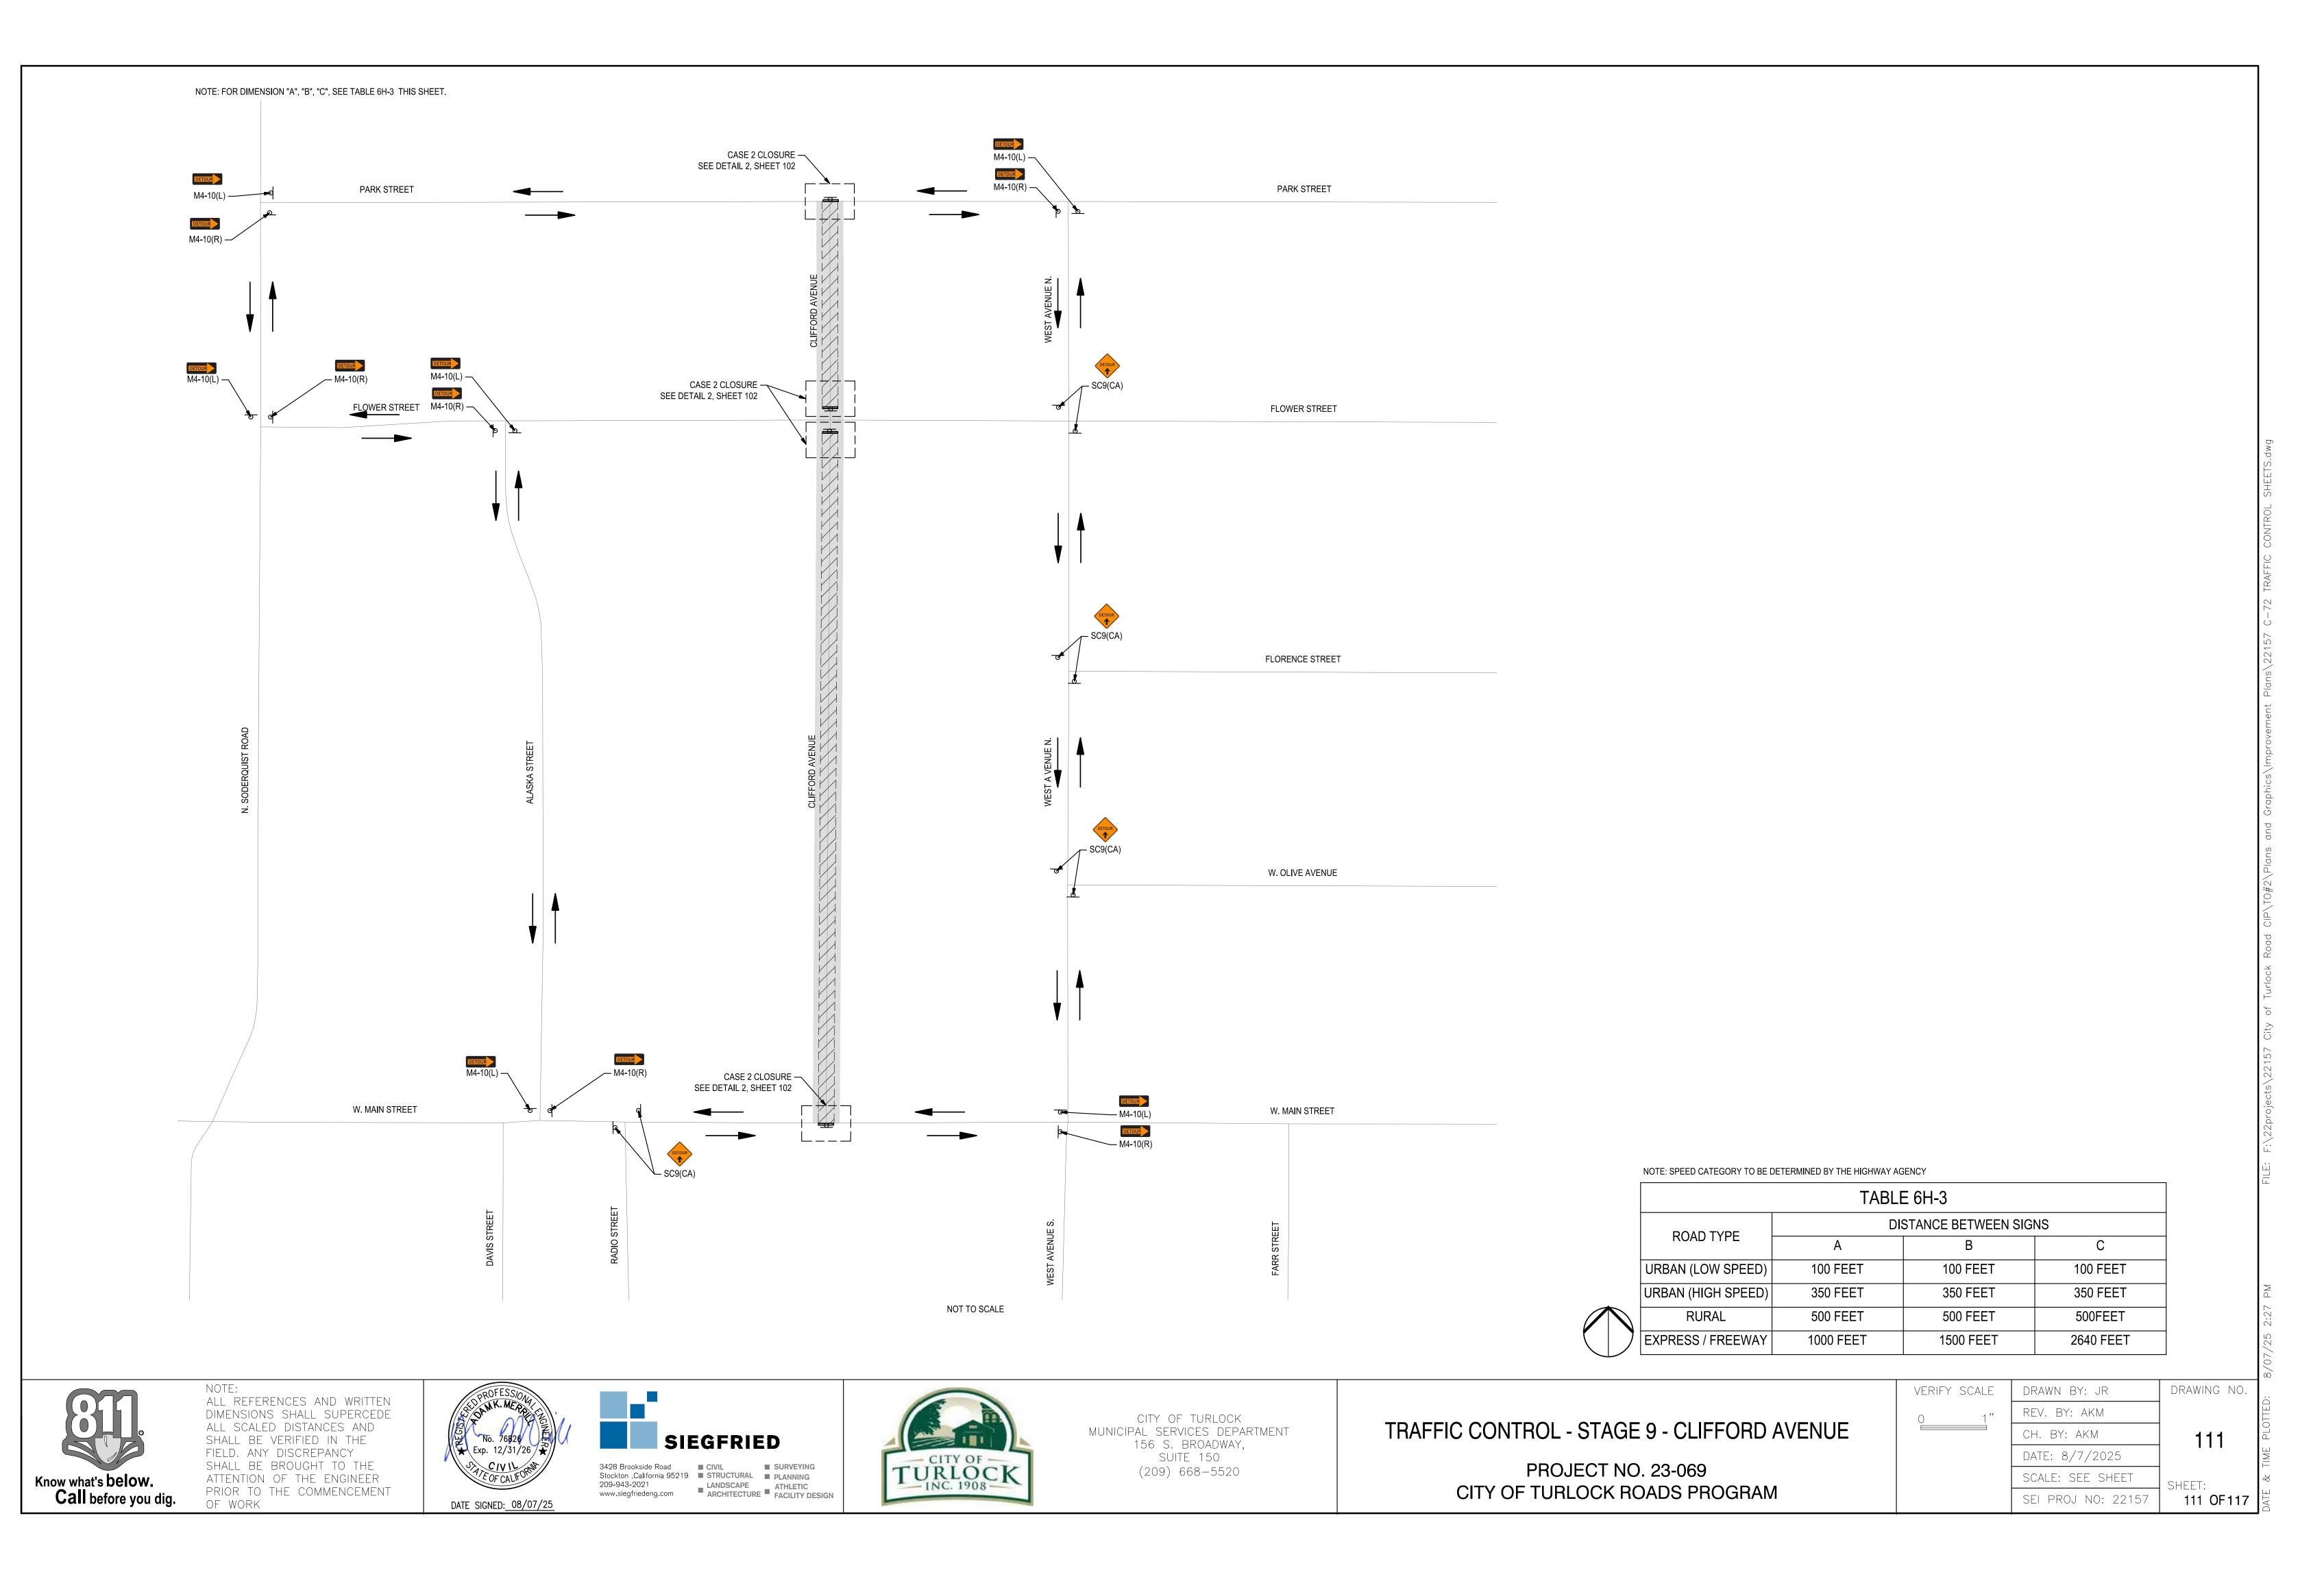

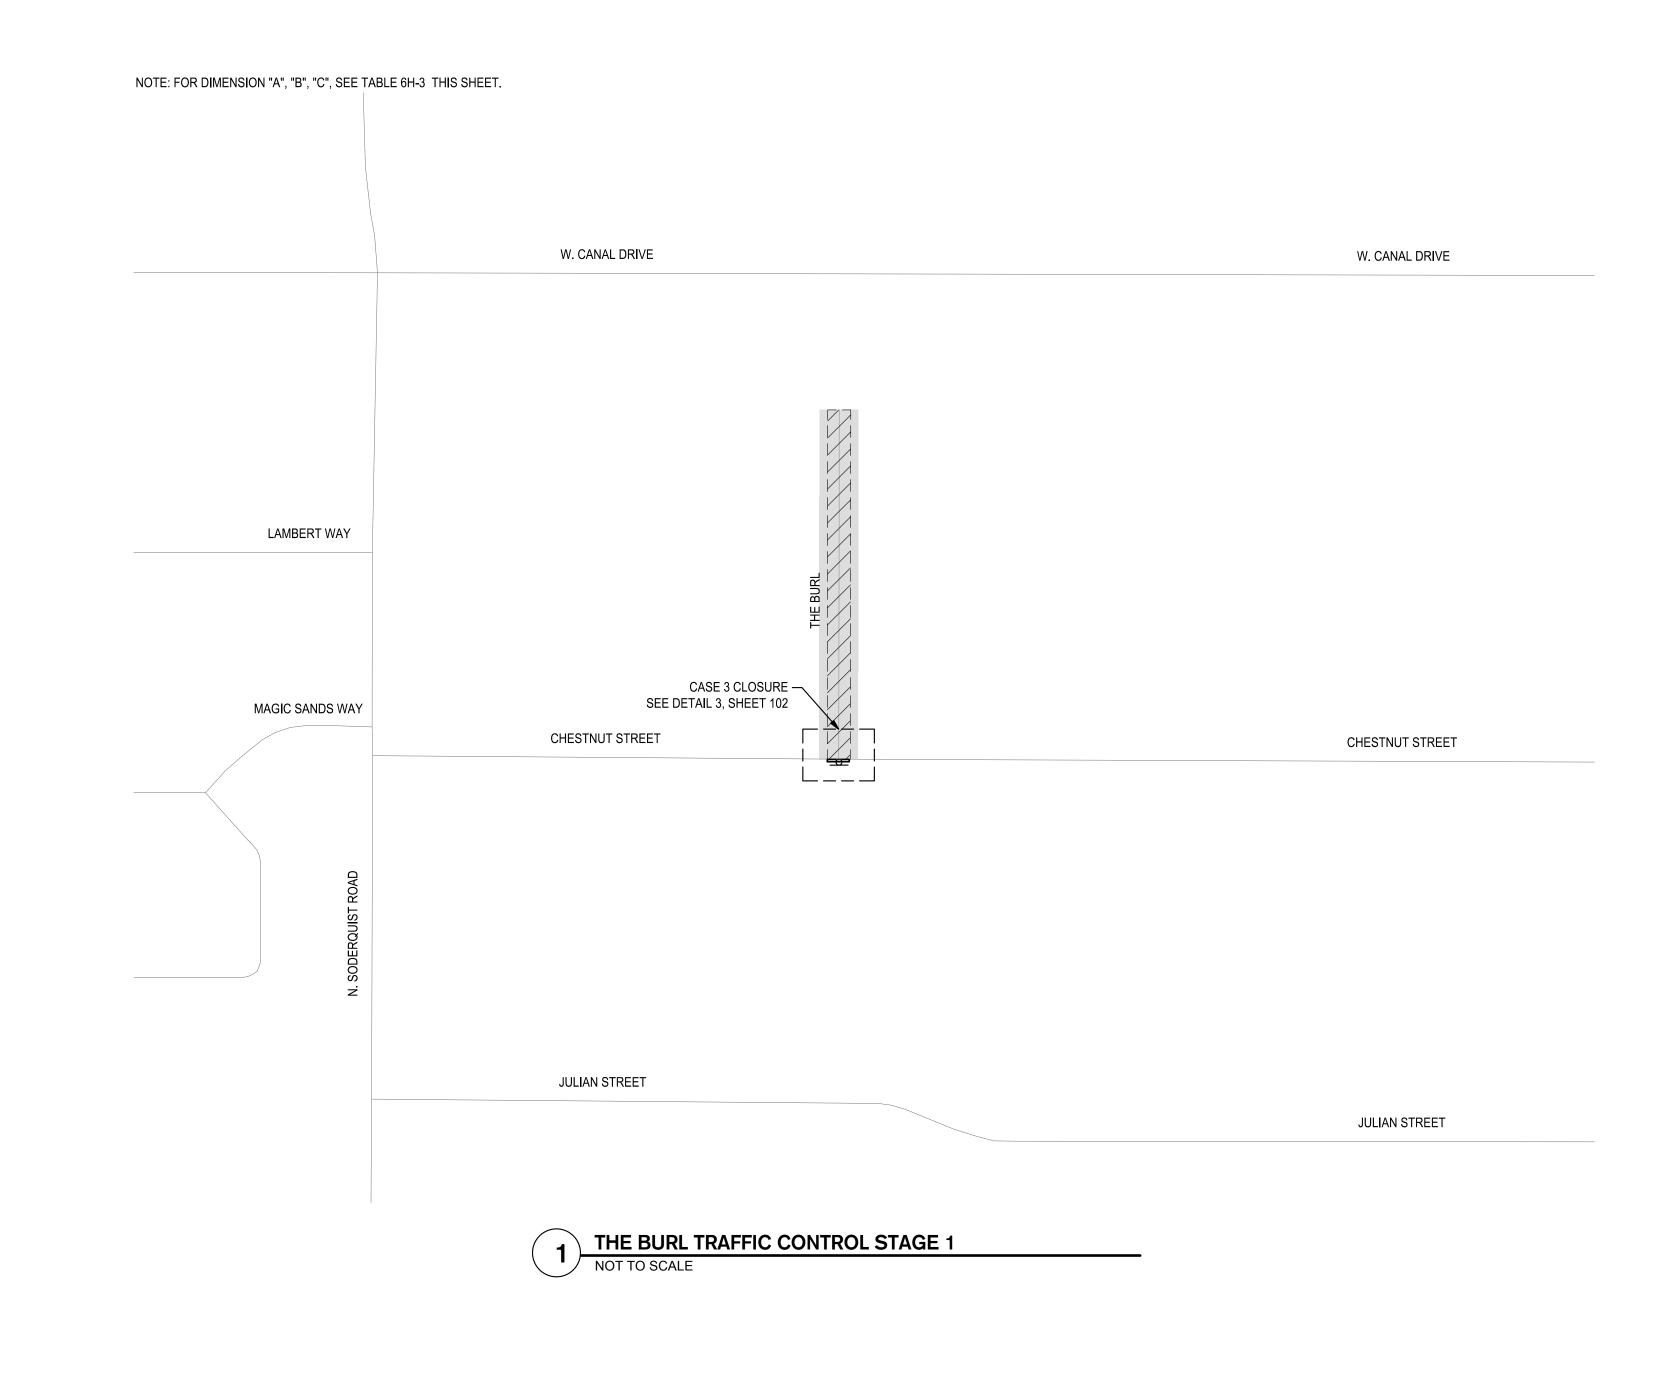


NOTE: SPEED CATEGORY TO BE DETERMINED BY THE HIGHWAY AGENCY


	TABL	.E 6H-3		
DOAD TYPE	DISTANCE BETWEEN SIGNS			
ROAD TYPE —	А	В	С	
URBAN (LOW SPEED)	100 FEET	100 FEET	100 FEET	
URBAN (HIGH SPEED)	350 FEET	350 FEET	350 FEET	
RURAL	500 FEET	500 FEET	500FEET	
EXPRESS / FREEWAY	1000 FEET	1500 FEET	2640 FEET	

Know what's below.
Call before you dig.

NOTE:
ALL REFERENCES AND WRITTEN
DIMENSIONS SHALL SUPERCEDE
ALL SCALED DISTANCES AND
SHALL BE VERIFIED IN THE
FIELD. ANY DISCREPANCY
SHALL BE BROUGHT TO THE
ATTENTION OF THE ENGINEER
PRIOR TO THE COMMENCEMENT
OF WORK

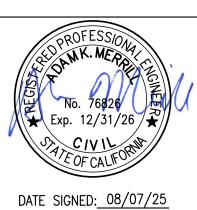



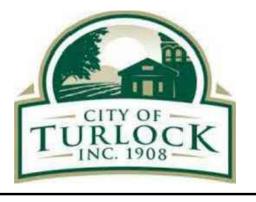



CITY OF TURLOCK MUNICIPAL SERVICES DEPARTMENT 156 S. BROADWAY, SUITE 150 (209) 668-5520

TRAFFIC CONTROL - STAGE 10 - THE BURL


PROJECT NO. 23-069
CITY OF TURLOCK ROADS PROGRAM

verify scale	DRAWN BY: JR	DRAWING NO.
0 1"	REV. BY: AKM	
	CH. BY: AKM	112
	DATE: 8/7/2025	112
	SCALE: SEE SHEET	SHEET:
	SEI PROJ NO: 22157	112 OF117

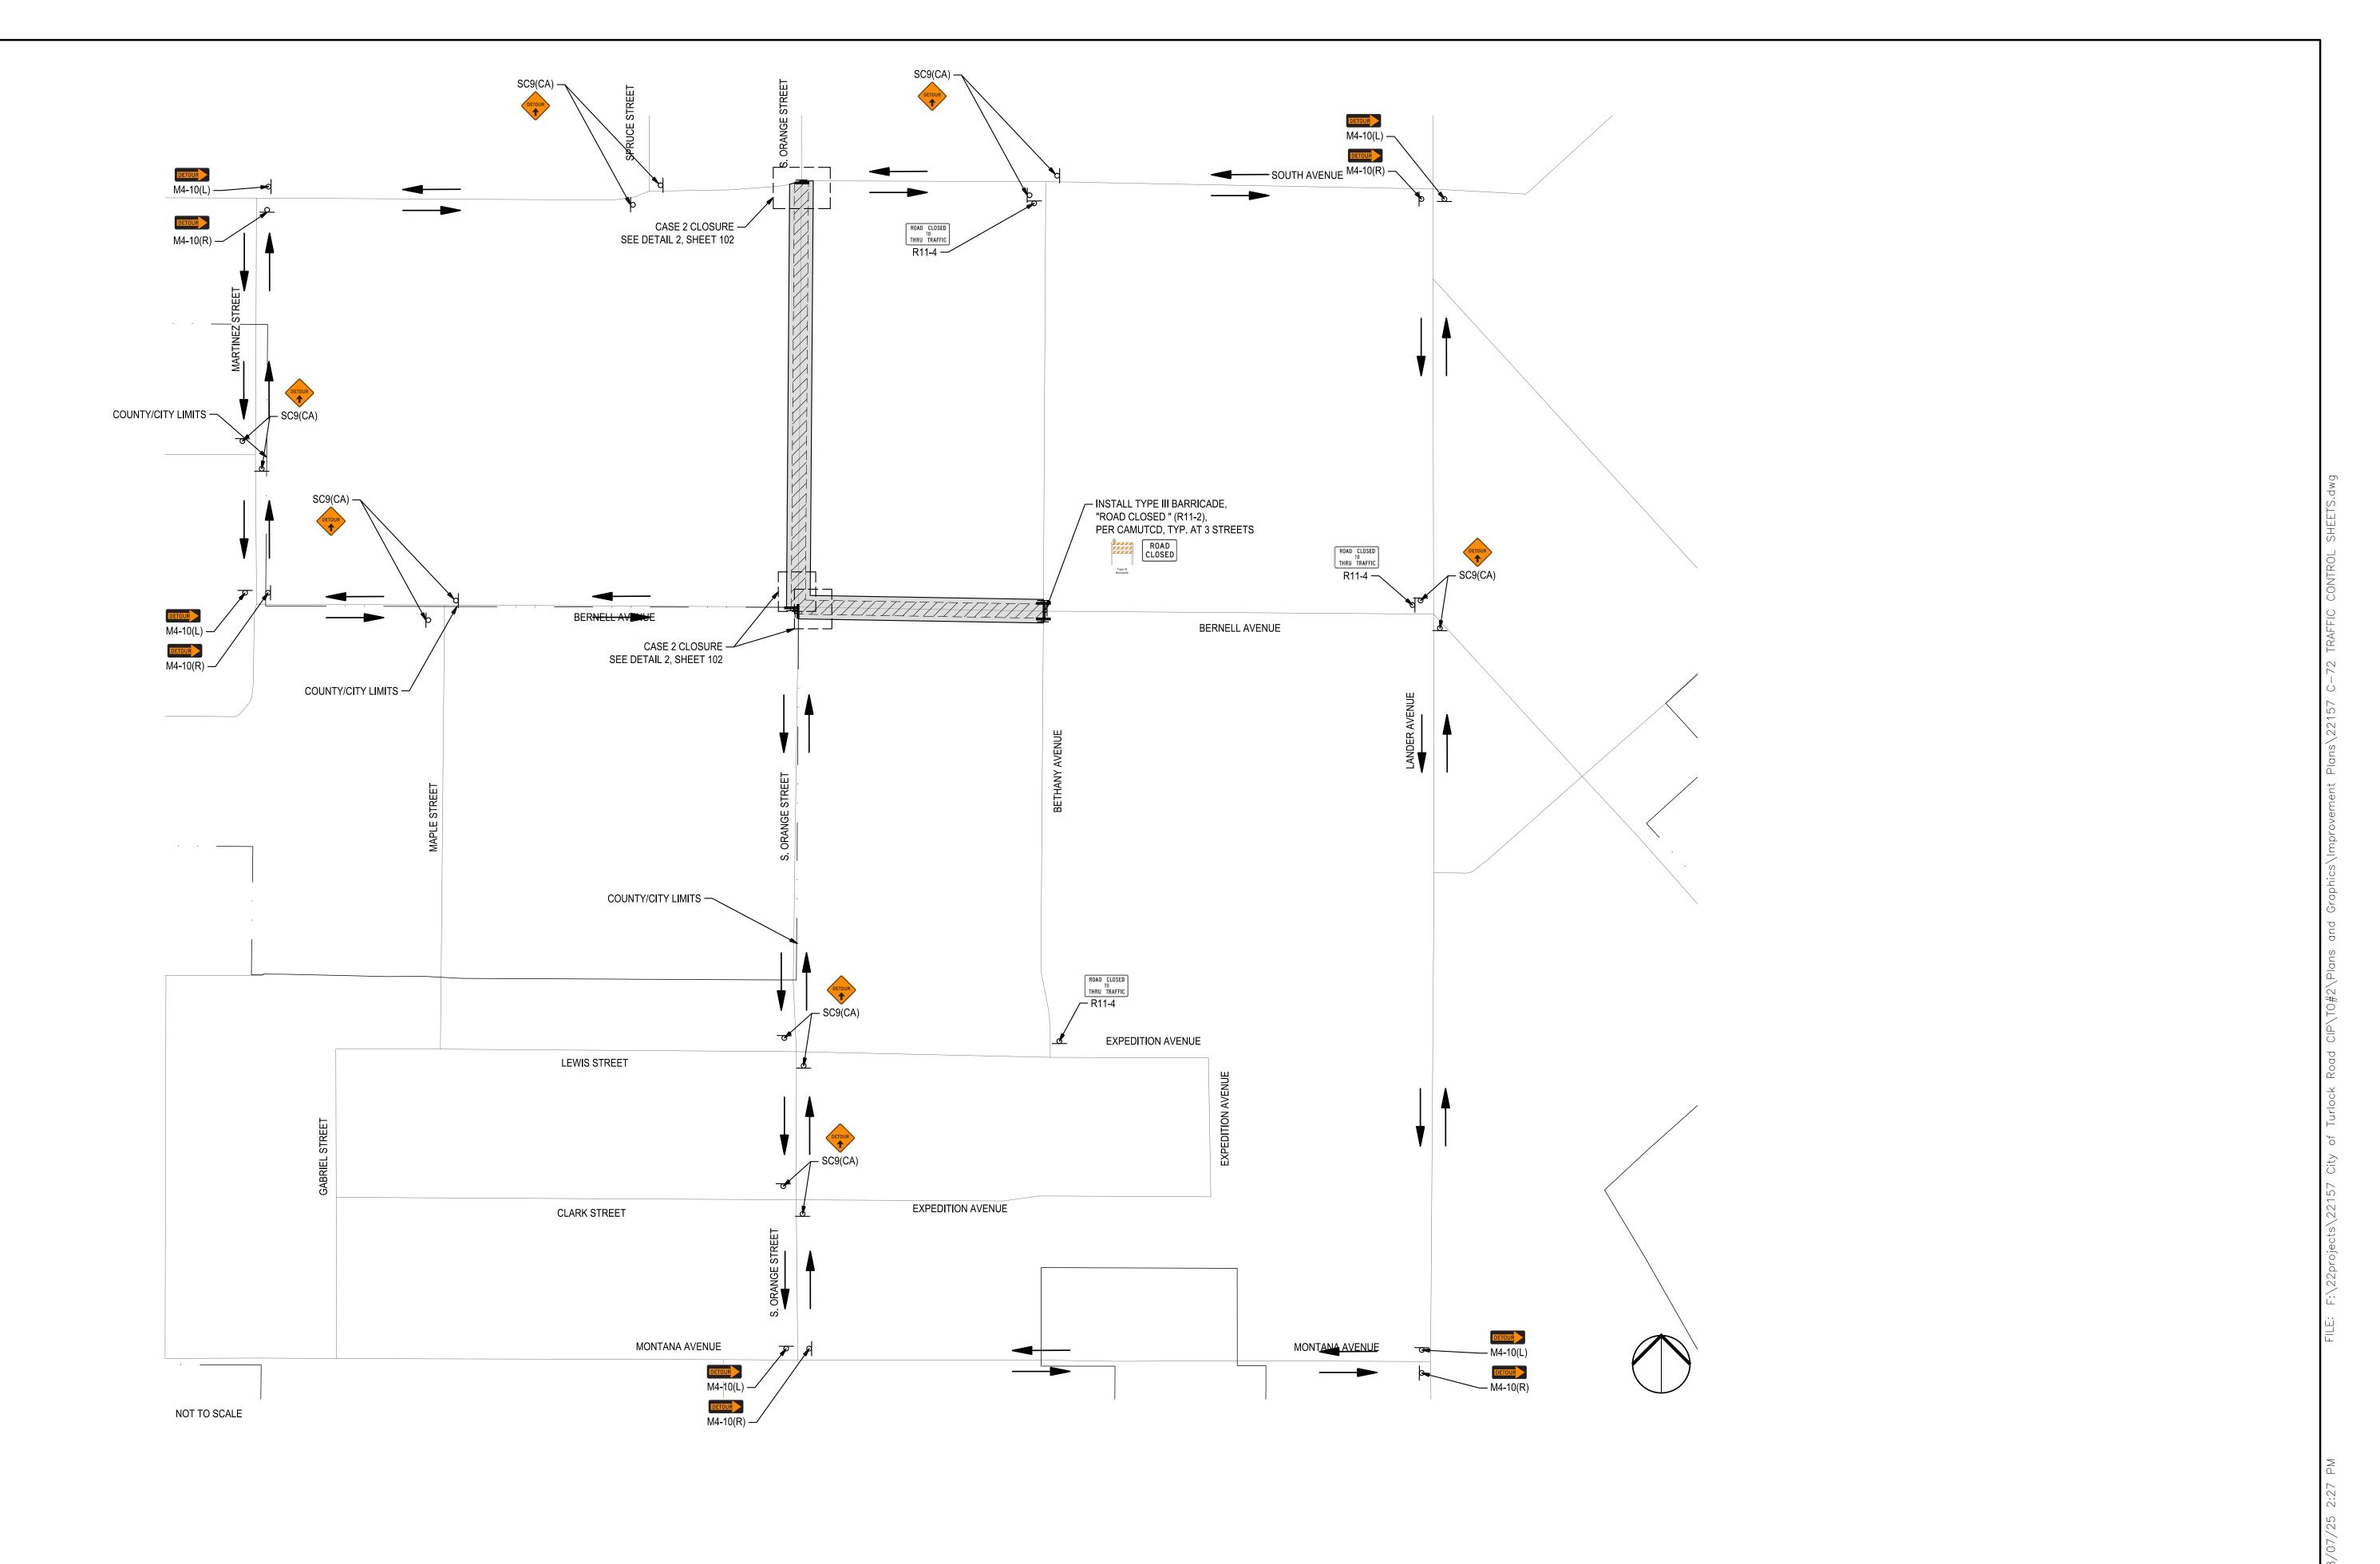


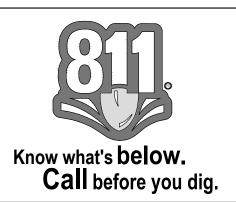

NOTE:
ALL REFERENCES AND WRITTEN
DIMENSIONS SHALL SUPERCEDE
ALL SCALED DISTANCES AND
SHALL BE VERIFIED IN THE
FIELD. ANY DISCREPANCY
SHALL BE BROUGHT TO THE
ATTENTION OF THE ENGINEER
PRIOR TO THE COMMENCEMENT
OF WORK

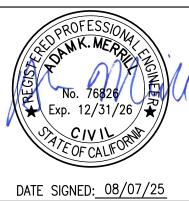





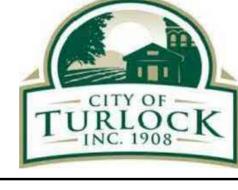



CITY OF TURLOCK MUNICIPAL SERVICES DEPARTMENT 156 S. BROADWAY, SUITE 150 (209) 668-5520 TRAFFIC CONTROL - STAGE 11 - S ORANGE
STREET & BERNELL AVENUE
PROJECT NO. 23-069
CITY OF TURLOCK ROADS PROGRAM


VERIFY SCALE	DRAWN BY: JR	DRAWING NO
0 1"	REV. BY: AKM	
	CH. BY: AKM	113
	DATE: 8/7/2025	
	SCALE: SEE SHEET	SHEET:
	SEI PROJ NO: 22157	113 OF 117

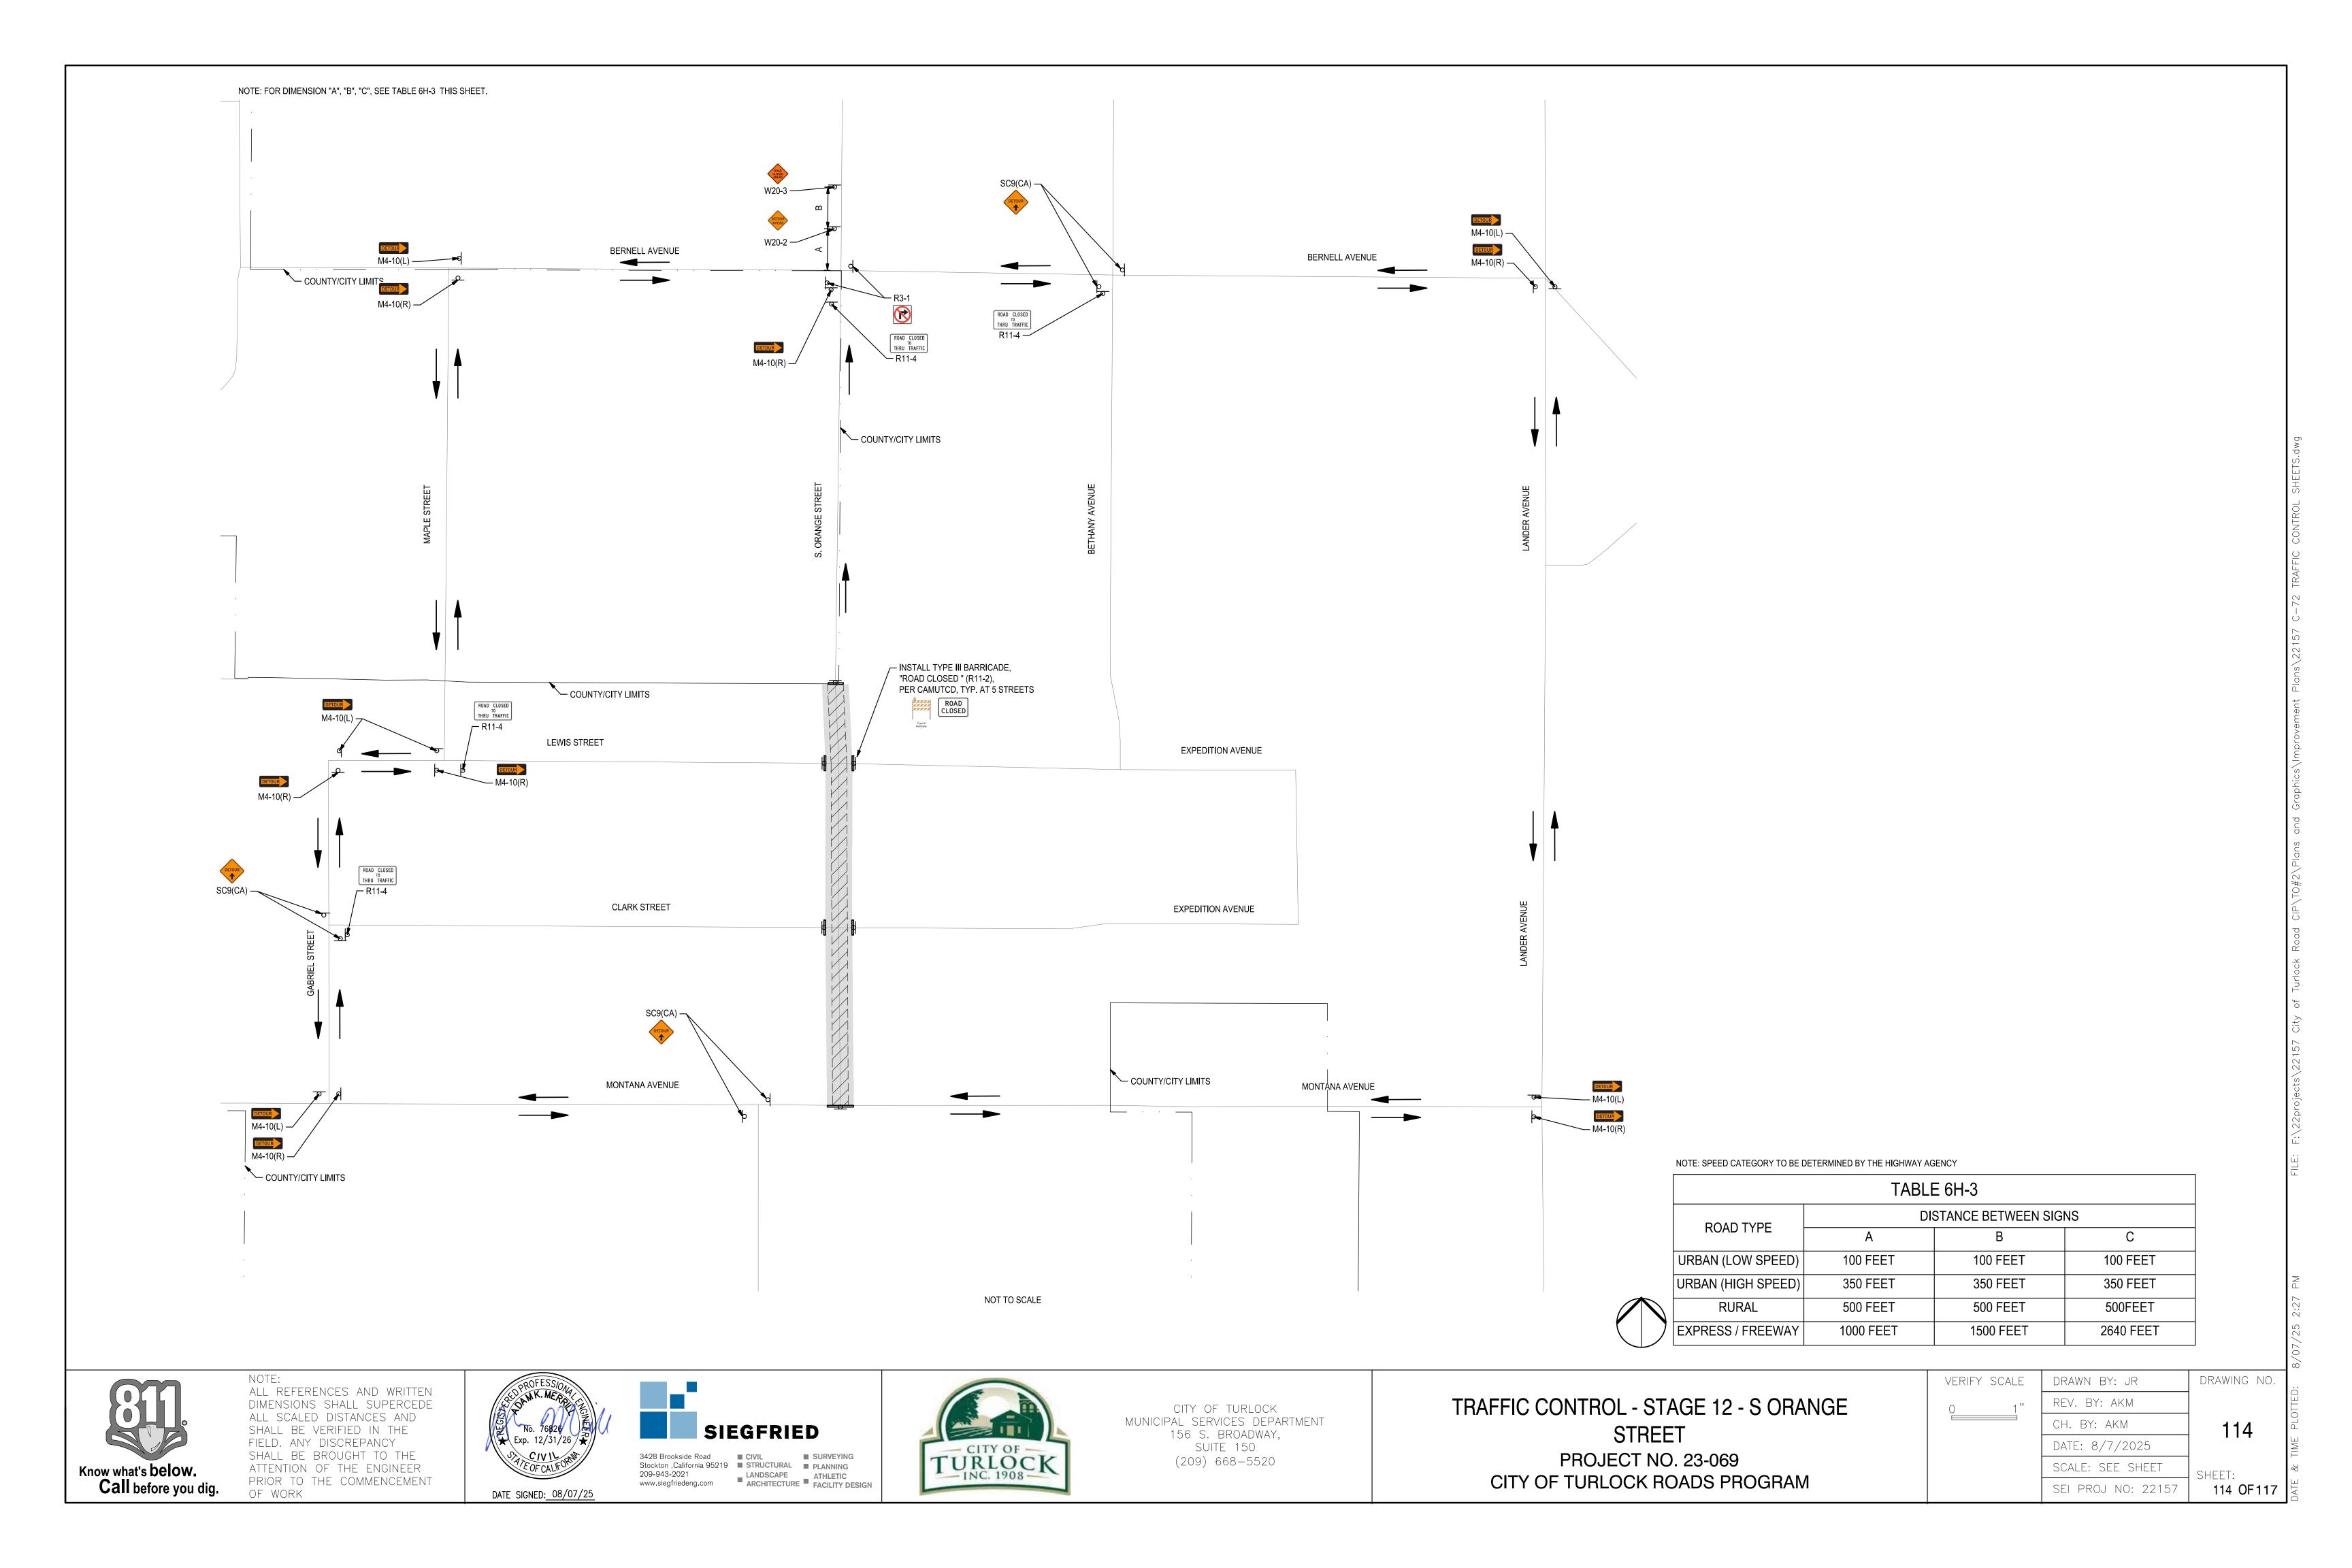


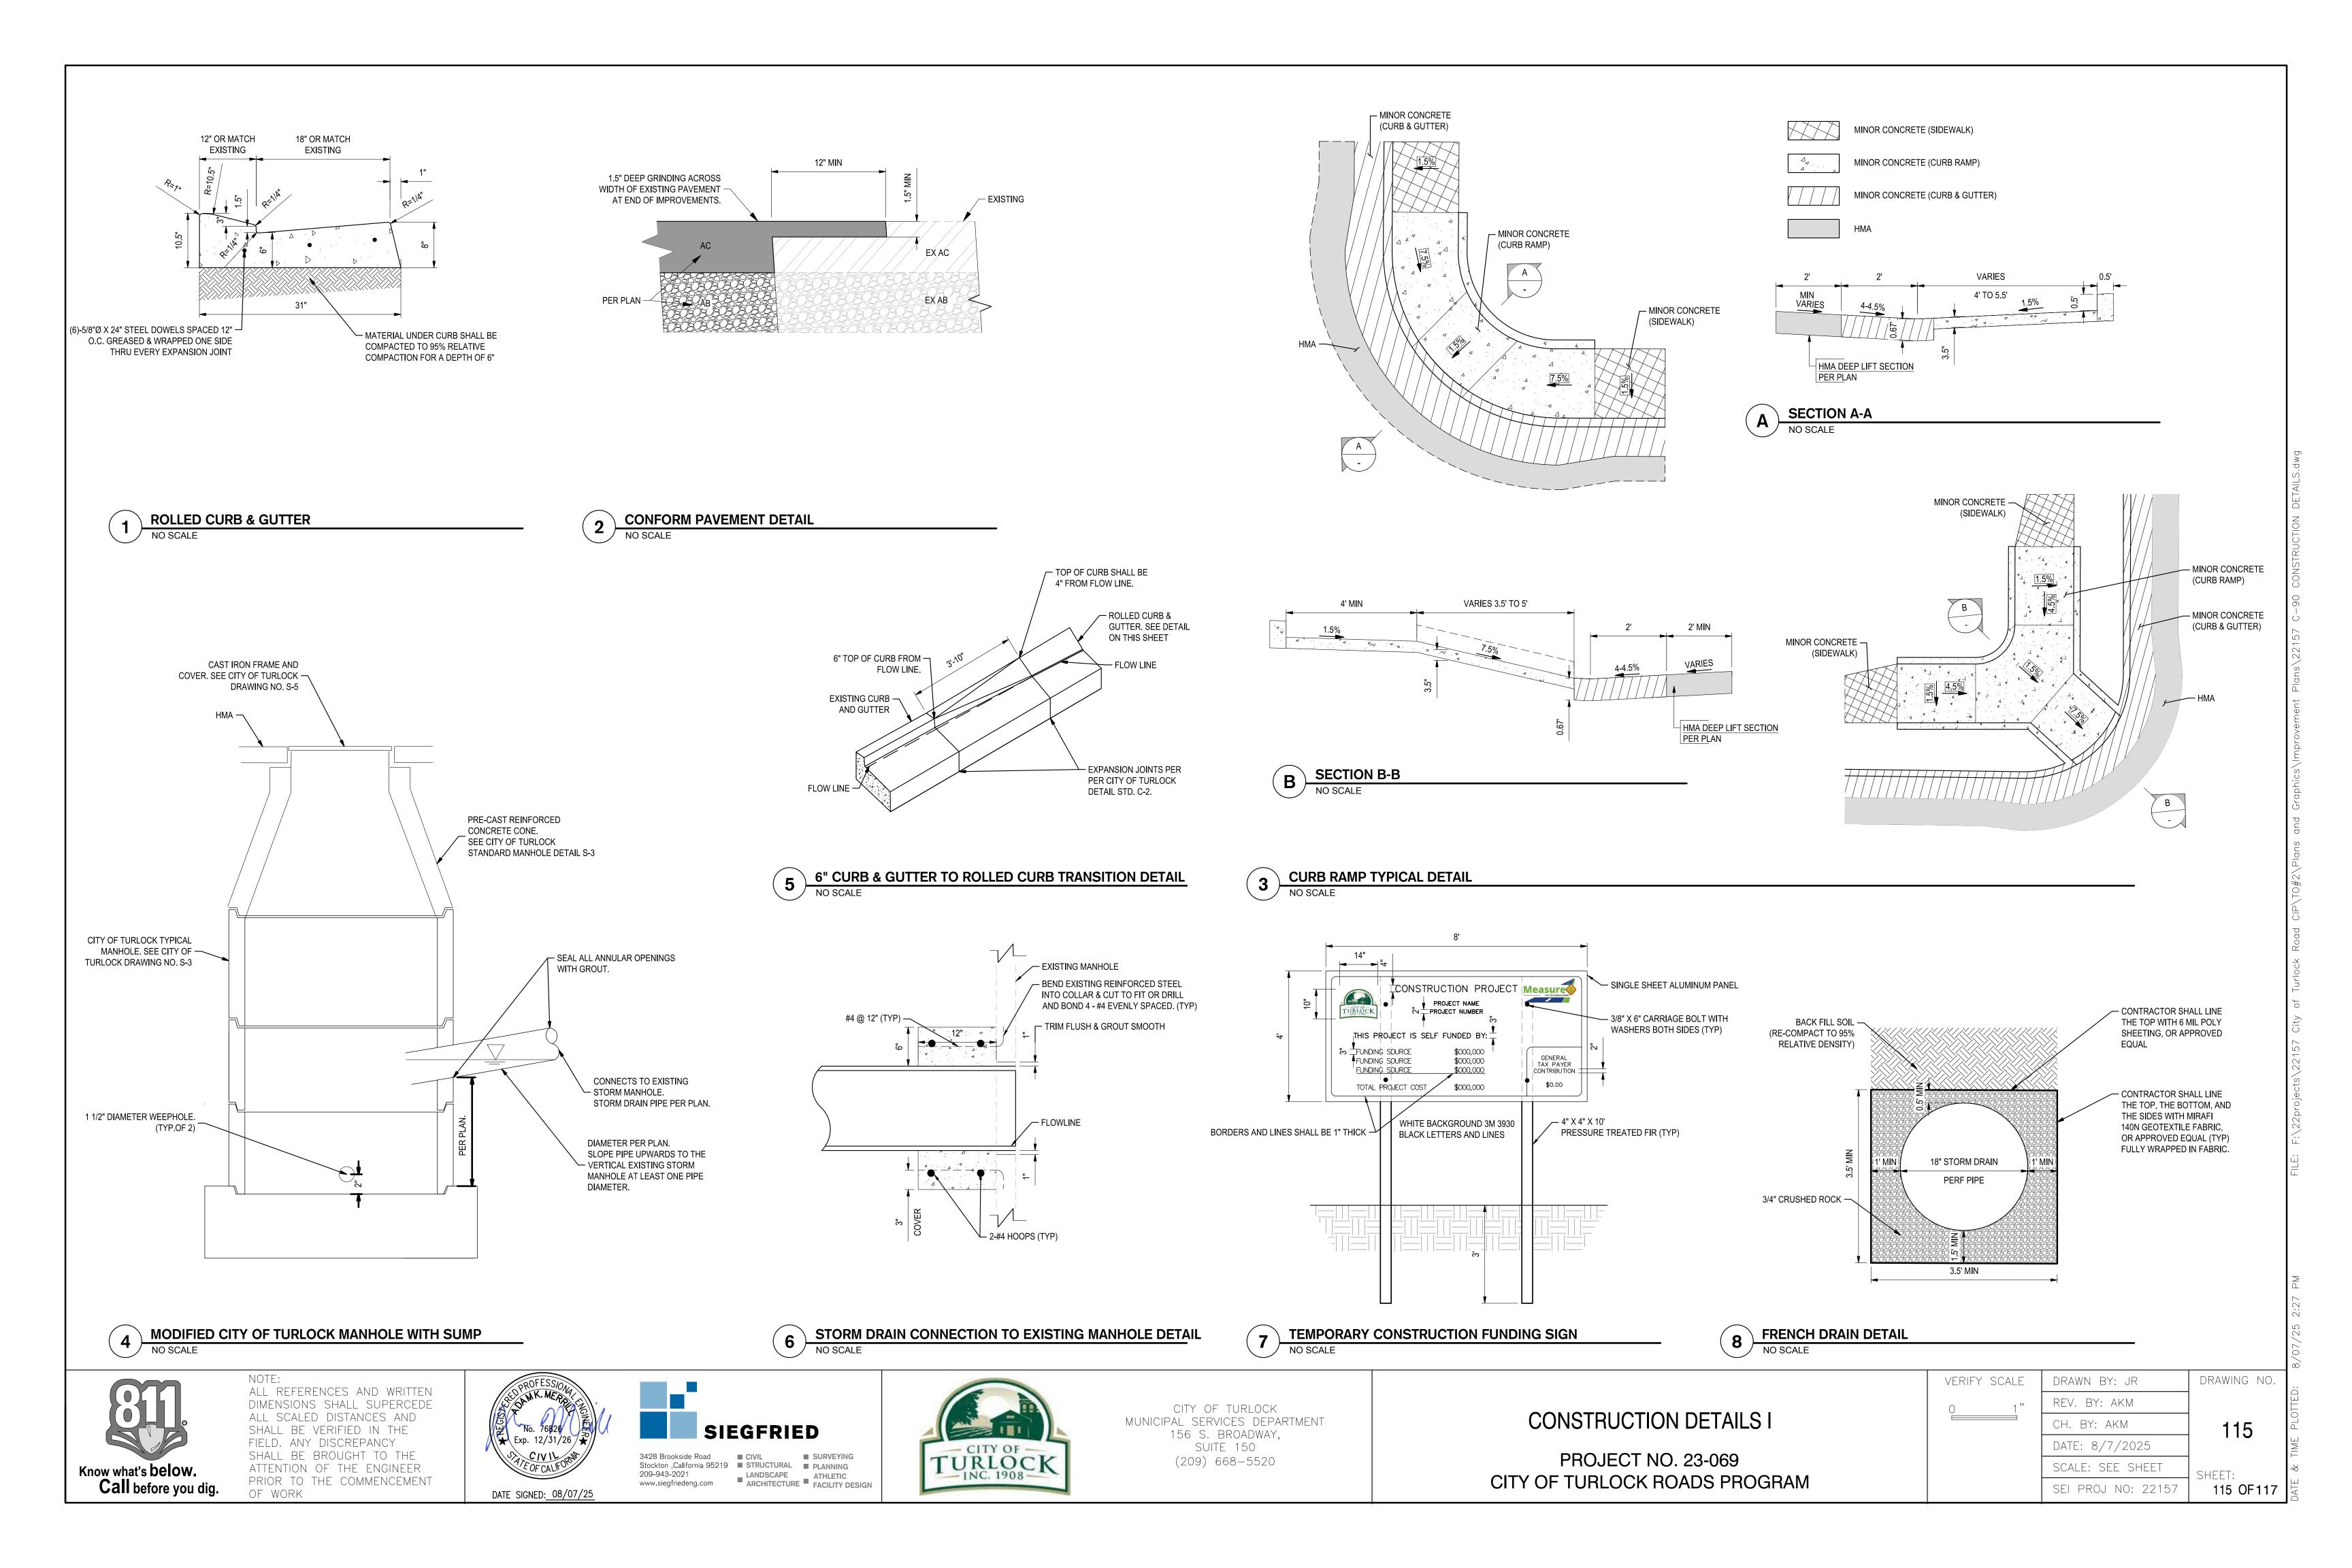


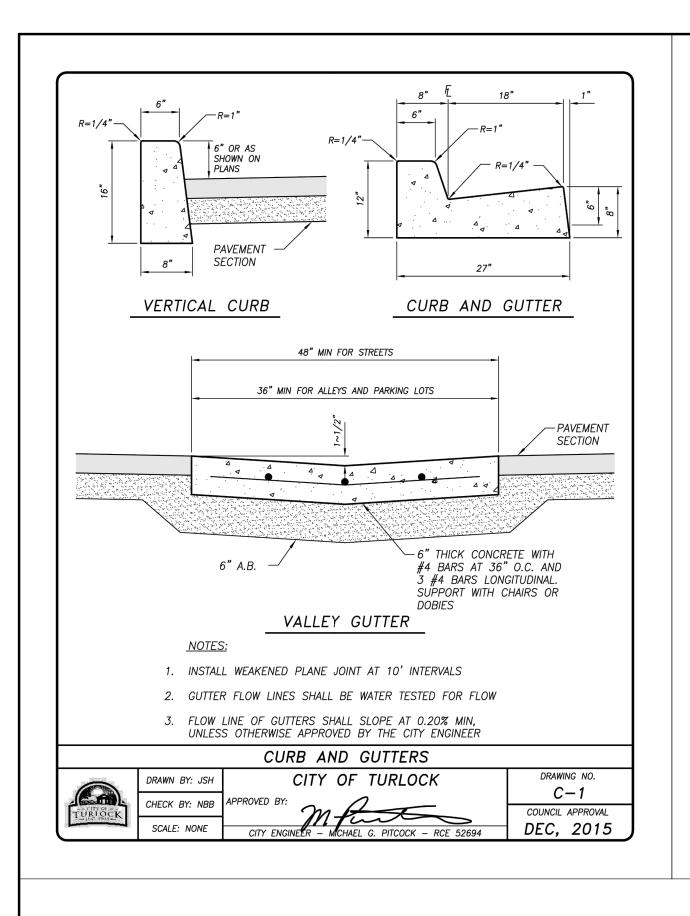


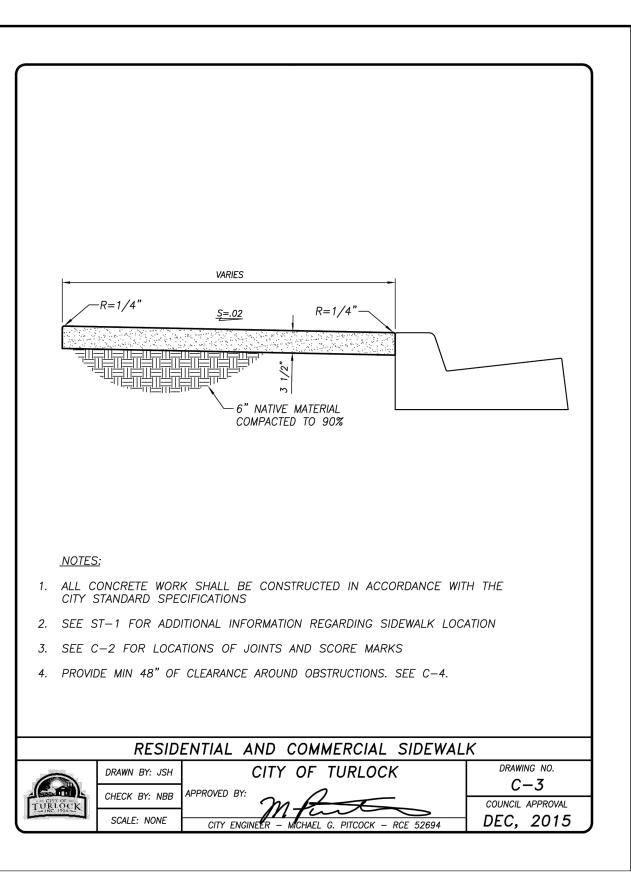


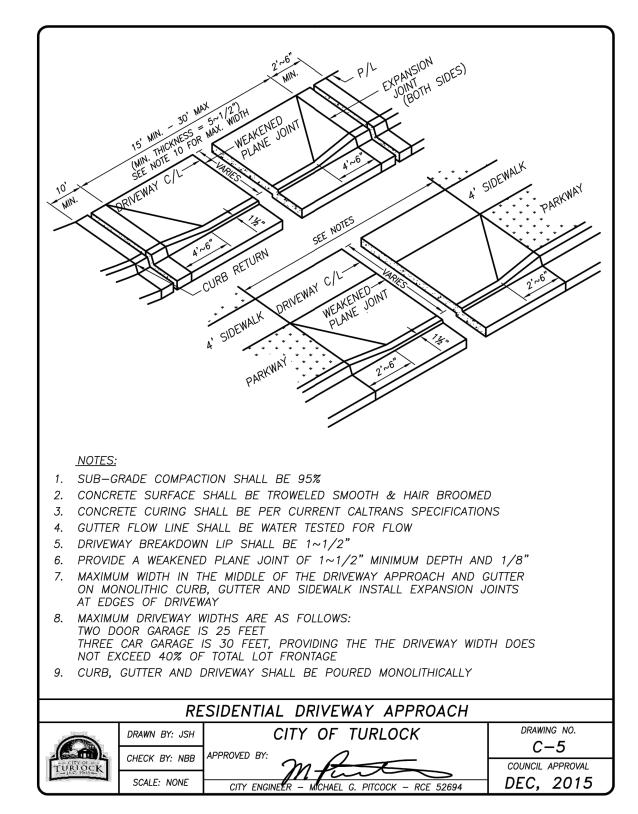


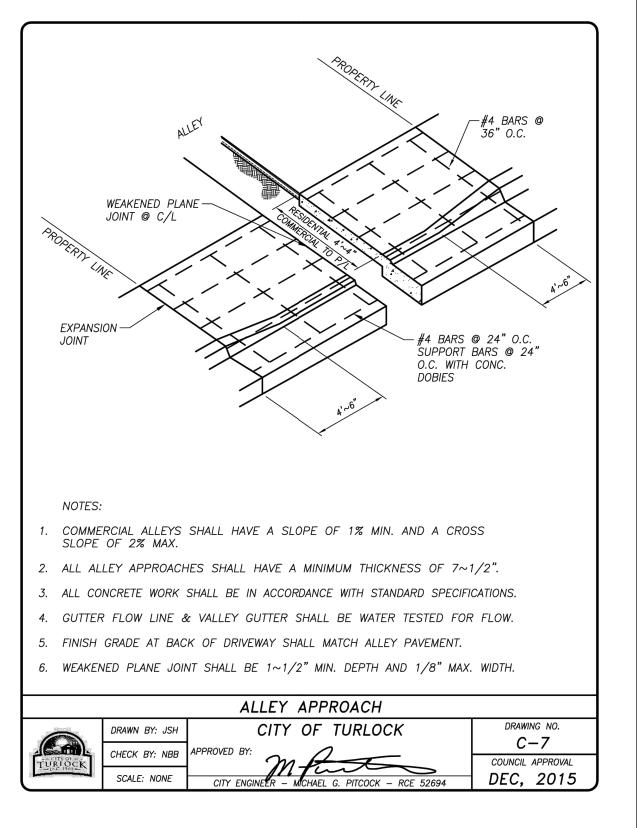


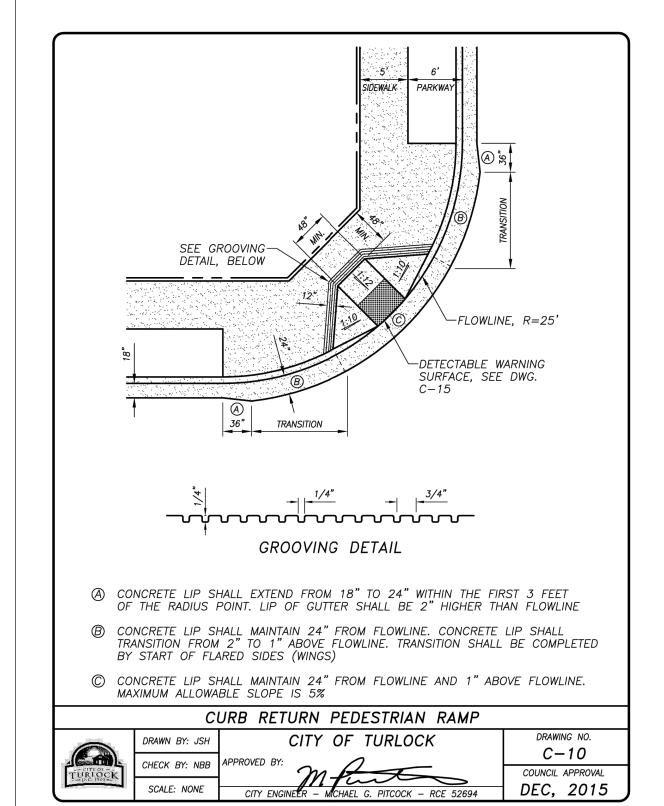


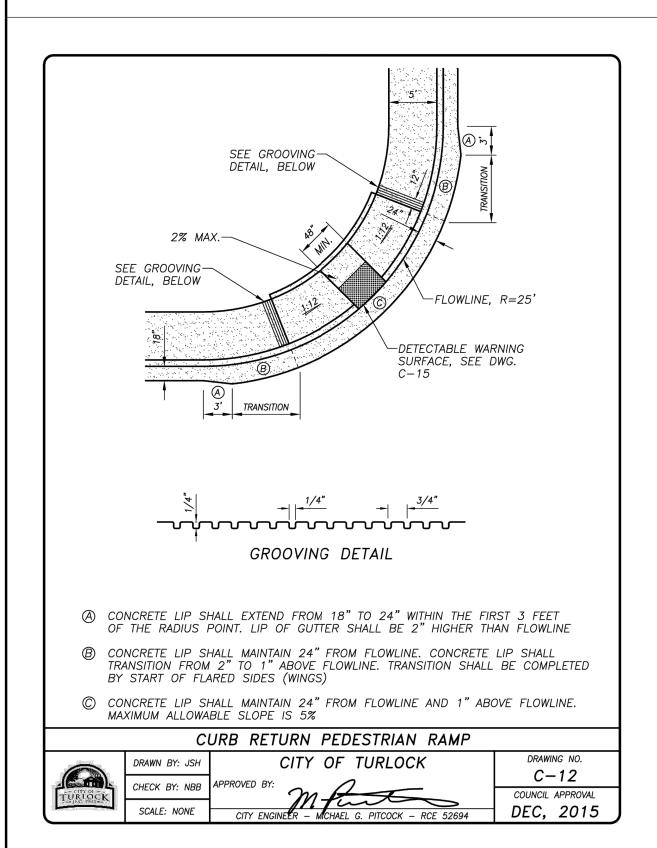


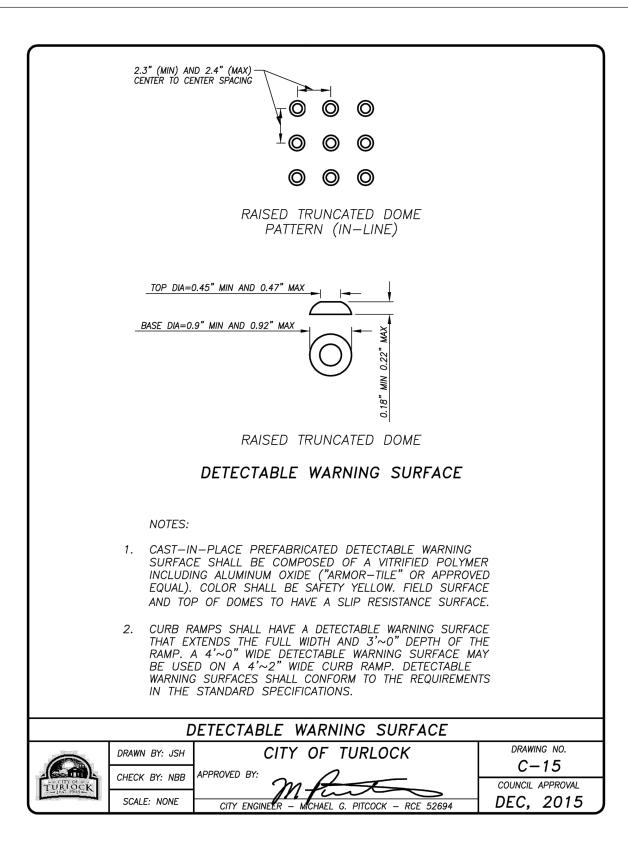

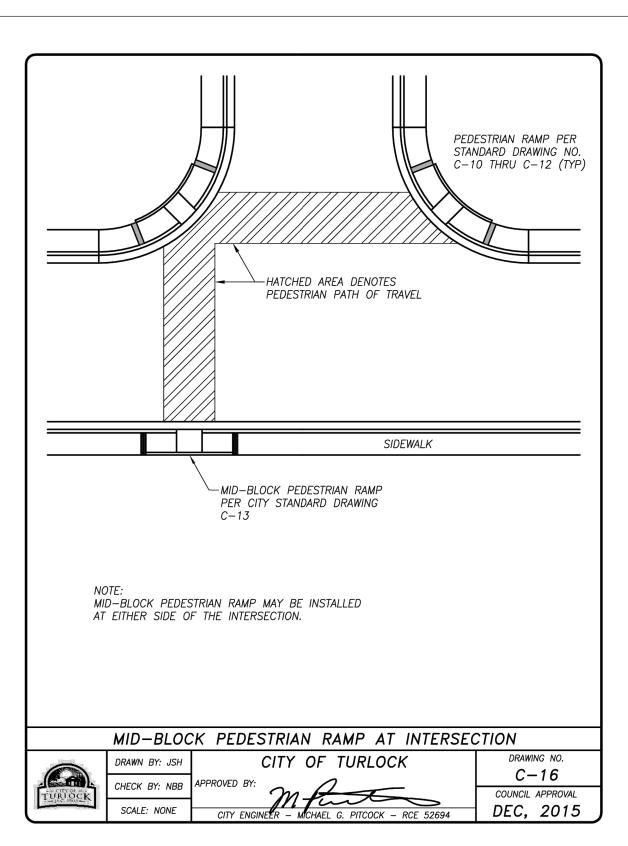


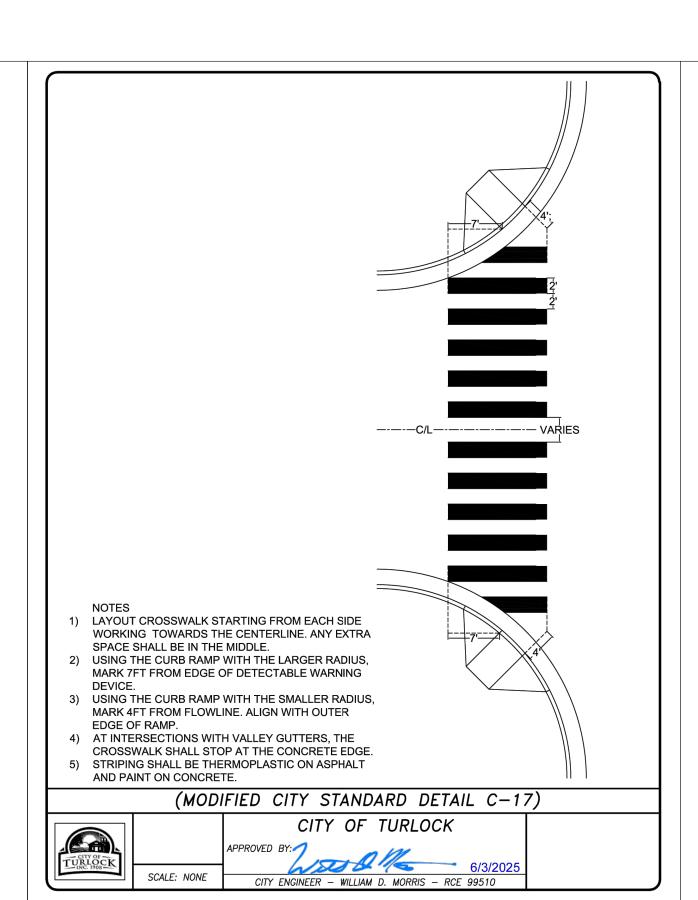

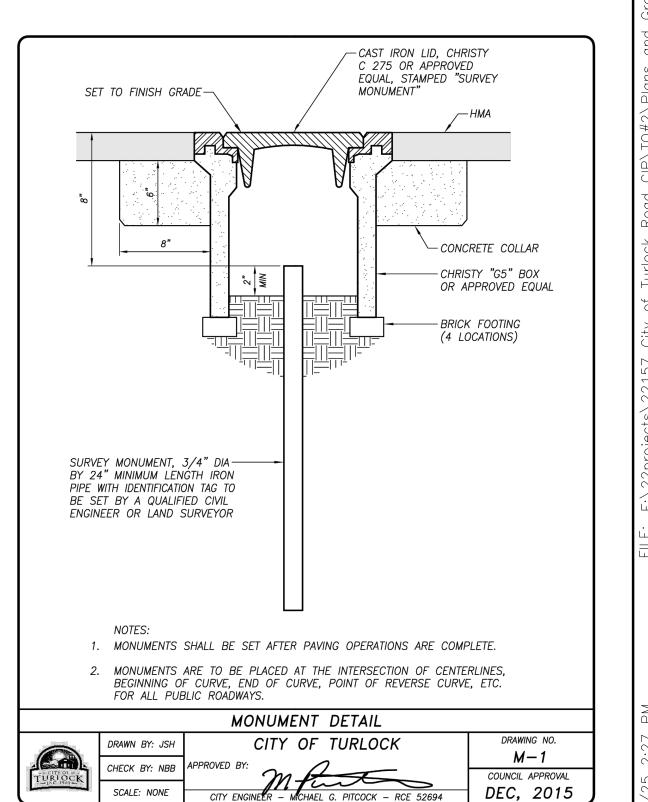

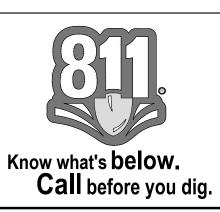


ALL REFERENCES AND WRITTEN DIMENSIONS SHALL SUPERCEDE ALL SCALED DISTANCES AND SHALL BE VERIFIED IN THE FIELD. ANY DISCREPANCY SHALL BE BROUGHT TO THE ATTENTION OF THE ENGINEER PRIOR TO THE COMMENCEMENT OF WORK

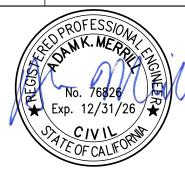


DATE SIGNED: 08/07/25




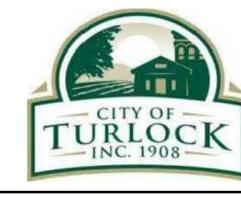



CITY OF TURLOCK MUNICIPAL SERVICES DEPARTMENT 156 S. BROADWAY, SUITE 150 (209) 668 - 5520


CONSTRUCTION DETAILS II

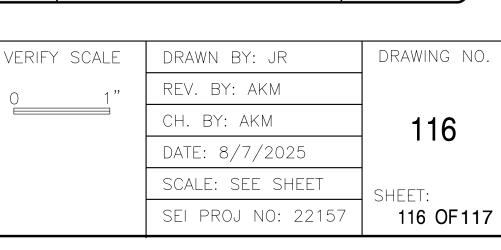


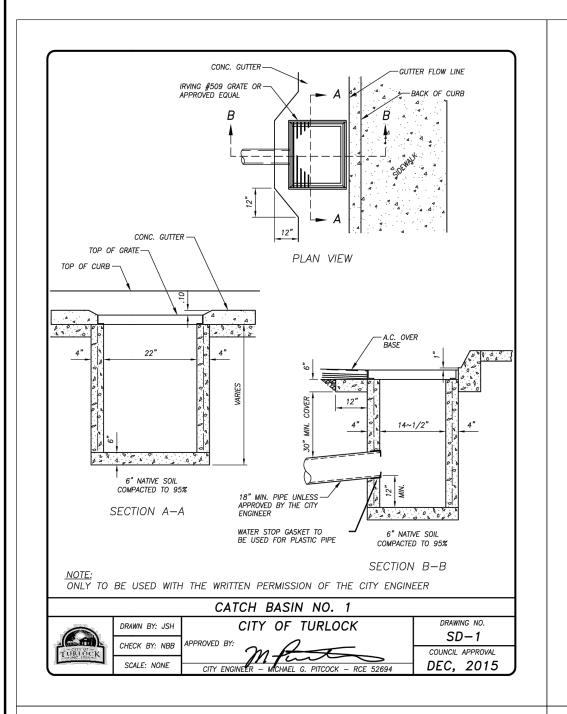


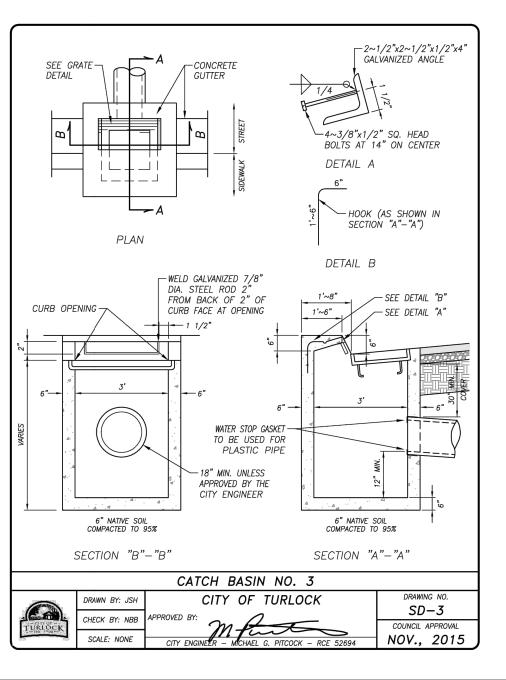


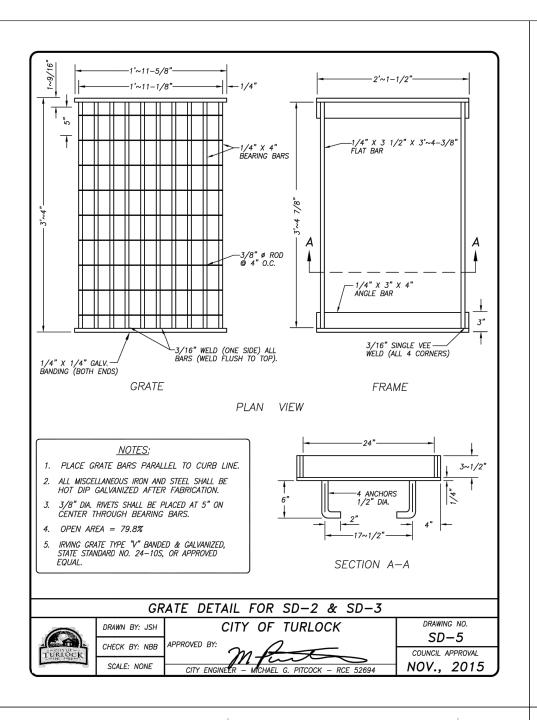


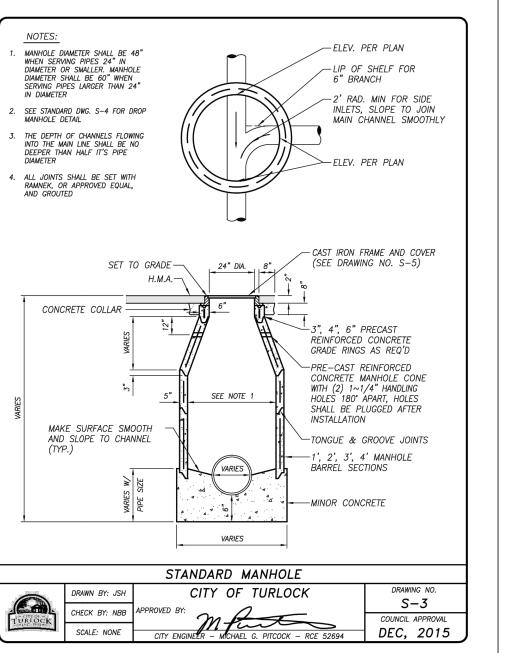


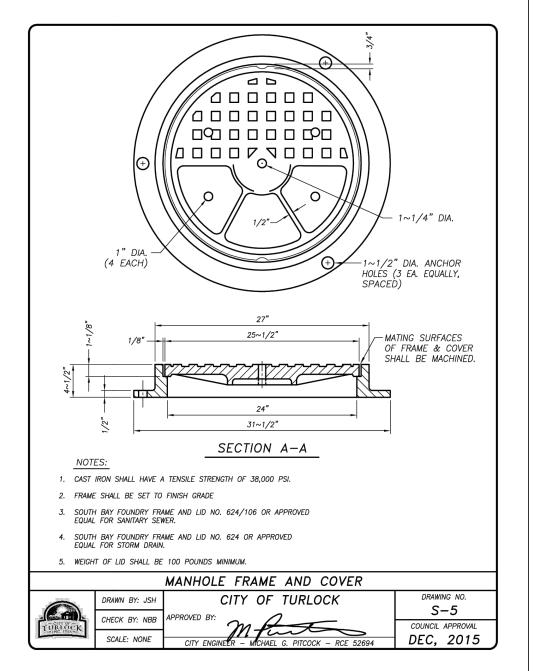


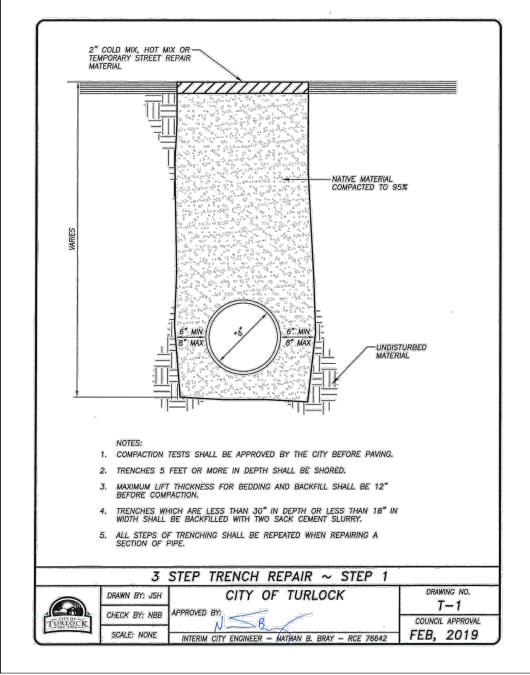


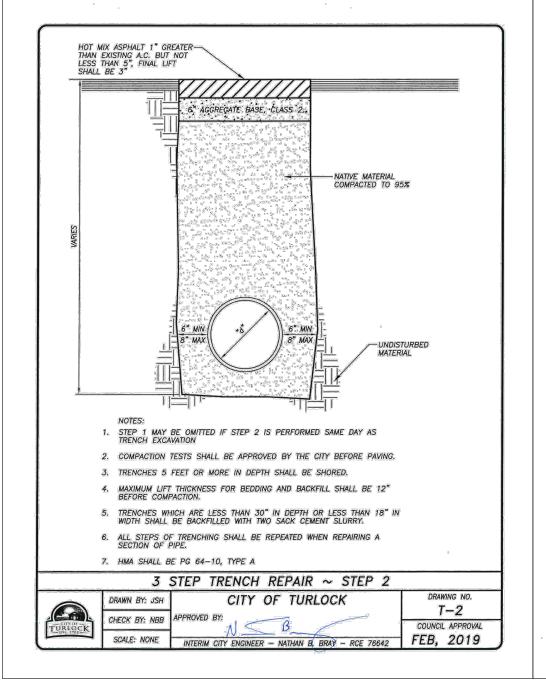


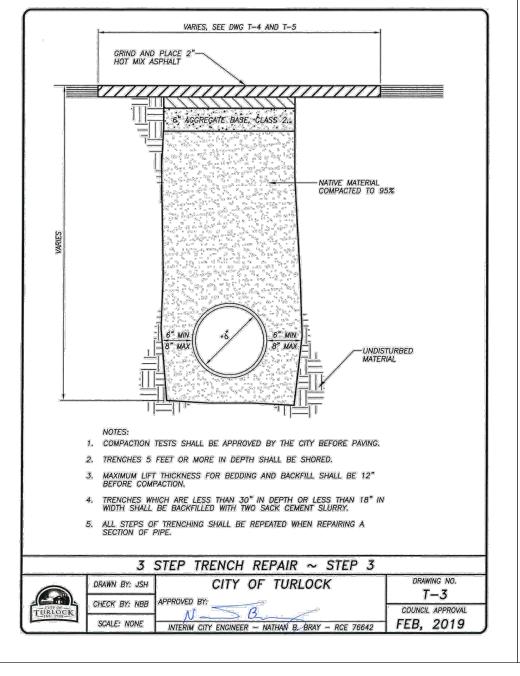

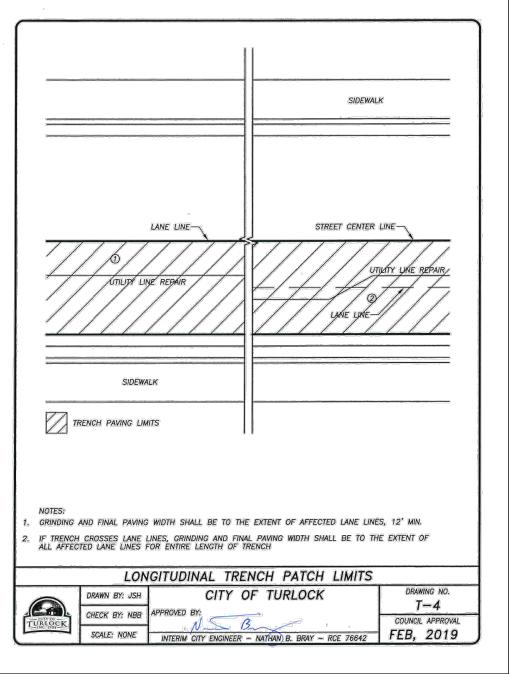

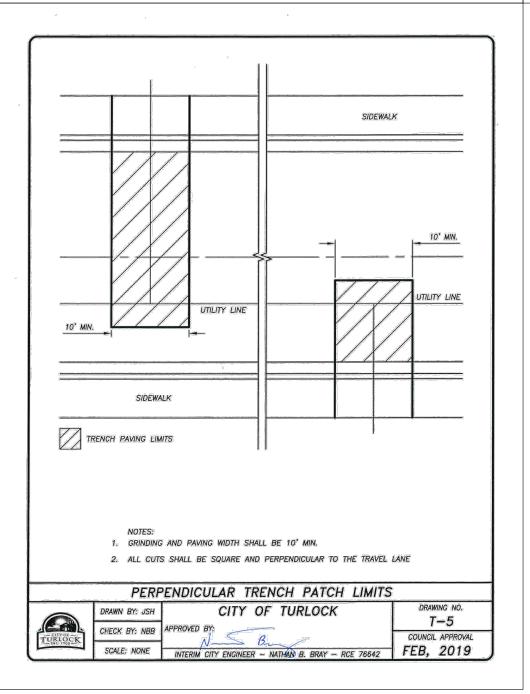

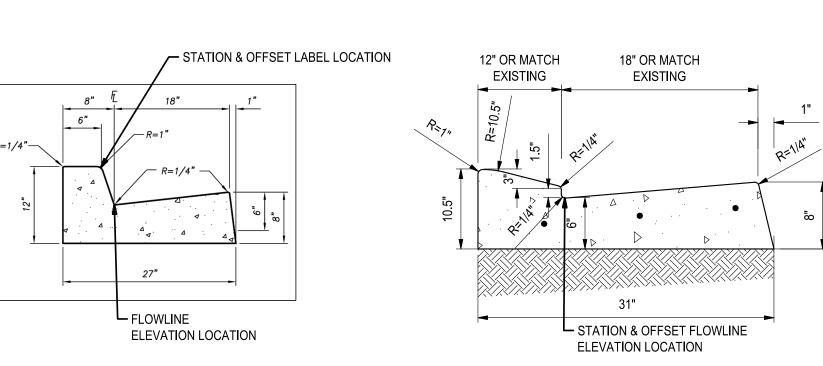

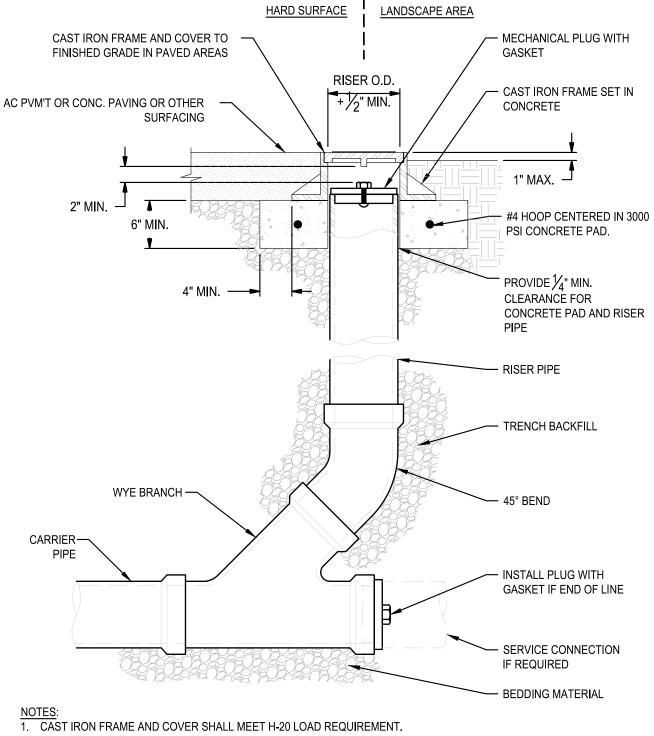

FOR CARRIER PIPE SIZE 10" Ø AND LESS, PROVIDE RISER PIPE SIZE TO MATCH CARRIER I


- 2. FOR CARRIER PIPE SIZE 10" \varnothing AND LESS, PROVIDE RISER PIPE SIZE TO MATCH CARRIER PIPE.
- 3. FOR CARRIER PIPE SIZE 12" \varnothing AND LARGER, RISER PIPE SHALL BE 10" \varnothing .
- 4. RISER PIPE MATERIAL TO MATCH CARRIER PIPE MATERIAL.

A TYPICAL STORM DRAIN CLEANOUT DETAIL


NO SCALE

 (\mathbf{B}) $\frac{\mathbf{S}}{NC}$


B STATION AND OFFSET LABEL PLACEMENT DETAIL
NO SCALE

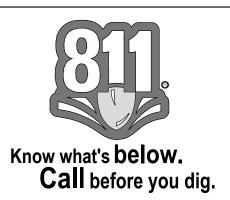

NOTE:
ALL REFERENCES AND WRITTEN
DIMENSIONS SHALL SUPERCEDE
ALL SCALED DISTANCES AND
SHALL BE VERIFIED IN THE
FIELD. ANY DISCREPANCY
SHALL BE BROUGHT TO THE
ATTENTION OF THE ENGINEER
PRIOR TO THE COMMENCEMENT
OF WORK

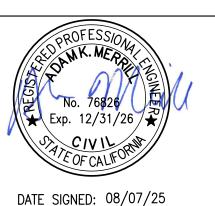



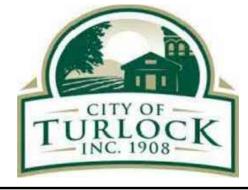

CITY OF TURLOCK
MUNICIPAL SERVICES DEPARTMENT
156 S. BROADWAY,
SUITE 150
(209) 668-5520

CONSTRUCTION DETAILS III

PROJECT NO. 23-069 CITY OF TURLOCK ROADS PROGRAM

ERIFY SCALE	DRAWN BY: JR	DRAWING NC
1 "	REV. BY: AKM	
	CH. BY: AKM	117
	DATE: 8/7/2025	
	SCALE: SEE SHEET	SHEET:
	SEI PROJ NO: 22157	117 OF11
	•	·

)TTED: 8/07/25 2:27 PM FILE